164 OLD MAMMOTH ROAD, MAMMOTH LAKES, CA 93564

DESIGN REVIEW SUBMITTAL

JANUARY 28, 2022

SCOPE OF WORK

PARTIAL RENOVATION OF EXISTING HOTEL AND RESTAURANT. DEMOLITION OF EXISTING RESTAURANT BUILDING. ADDITION OF NEW SLEEPING UNITS IN DETACHED BUILDINGS PER SITE PLAN.

LIST OF PERMITS

PERMIT NUMBER DATE OF SUBMITTAL DESIGN REVIEW SUBMITTAL TBD

APPLICABLE CODES

2019 CALIFORNIA BUILDING CODE 2019 CALIFORNIA ENERGY EFFICIENT STANDARDS 2019 CALIFORNIA ELECTRICAL CODE 2019 CALIFORNIA PLUMBING CODE 2019 CALIFORNIA MECHANICAL CODE

2019 CALGREEN CODE



PROJECT TEAM

WN SN MAMMOTH, LLC 164 OLD MAMMOTH RD, MAMMOTH LAKES, CA 93546 CONTACT: PEG BLACKALL - (P) (850) 251-2337

CONTRACTOR: WATERTON RESIDENTIAL LLC 30 S WACKER DR, STE 3600, CHICAGO, IL 60606 CONTACT: JOHN DALEY - (P) (508) 509-5529

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HODGSON DOUGLAS LANDSCAPE ARCHITECTS 507 MAIN ST, NASHVILLE, TN 37206 CONTACT: RICHIE JONES - (P) (615) 417-3137

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ASHLEY & VANCE ENGINEERING

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HANGAR 7, 7 HAMILTON LANDING, STE 200, NOVATO, CA 94949 CONTACT: RAY GONZALES - (P) (415) 755-9210

	OUEET	DATE	CONTENTO
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	A.00	01/06/22	DESIGN REVIEW COVER SHEET
	A.01	11/01/21	CONTEXT MAP + PROJECT OVERVIEW
	$ \uparrow $		$\sim\sim\sim\sim$
7	B.01	11/17/21	STREET ELEVATIONS
J	B.02	V01/06/22	PROJECT REPSPECTIVES - OLD MAMMONH ROAD
	B.03	01/06/22	PROJECT PERSPECTIVES - STREET FRONTAGES
	B.04	01/06/22	PROJECT PERSPECTIVES - CABIN OPEN SPACE
	B.05	01/06/22	PROJECT PERSPECTIVES - FOOD GARDEN
	B.06	01/06/22	SHADOW STUDIES
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>	B.07	01/28/22	PROJECT MATERIALS (NEW / PROPOSED BUILDINGS)
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/	B.09	01/28/22	PROJECT MATERIALS (EXISTING BUILDINGS)
	B.10	01/28/22	PROPOSED STONE CLADDING AT NEW BUILDINGS
\ \ \ \ \ \ \ \ \ \ \ \ \ \ \ \ \ \ \	B.11	01/28/22	PROPOSED STONE CLADDING AT NEW BUILDINGS
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B1.01 01/06/22 HOTEL COURTYARD SITE PLAN ENLARGEMENT B1.02 01/06/22 INNER COURTYARD SITE PLAN ENLARGEMENT

B1.03 01/06/22 CABIN OPEN SPACE SITE PLAN ENLARGEMENT

B1.04 01/06/22 FOOD COURTYARD SITE PLAN ENLARGEMENT

01/06/22 COVER SHEET

01/06/22 GRADING PLAN - NORTH

01/06/22 GRADING PLAN - SOUTH

•	01/00/22	0.0.0.10.10.10.10.10.10.10.10.10.10.10.1
C4	01/06/22	DRAINAGE AND UTILITY PLAN
C5	01/06/22	EROSION CONTROL PLAN
C6	01/06/22	SNOW STORAGE PLAN
C7	01/06/22	SITE COVERAGE PLAN
D0.00	01/06/22	GENERAL NOTES
D3.00	01/06/22	OVERALL GRADING PLAN
D3.01	01/06/22	HOTEL COURTYARD GRADING PLAN ENLARGEMENT
D3.02	01/06/22	INNER COURTYARD GRADING PLAN ENLARGEMENT
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D3.04	01/06/22	FOOD COURTYARD GRADING PLAN ENLARGEMENT
D5.00	01/06/22	EXISTING TREE PLAN
D5.00a	01/06/22	OVERALL LANDSCAPE PLAN
D6.00	01/06/22	OVERALL EXTENT OF IRRIGATION
D7.00	01/06/22	OVERALL LIGHTING PLAN
E1.01	11/17/21	OVERALL FLOOR PLANS AT EXISTING BUILDINGS
E1.02	11/17/21	OVERALL FLOOR PLANS AT EXISTING BUILDINGS
E1.03	11/17/21	OVERALL FLOOR PLANS AT EXISTING BUILDINGS
E4.01	01/06/22	ELEVATIONS - ENTRY PORTAL
E4.02	11/17/21	EXTERIOR ELEVATIONS
E4.03	11/17/21	EXTERIOR ELEVATIONS
E4.11	01/06/22	EXTERIOR COLOR PALETTE
	, , ,	
F.01	01/06/22	CABIN (TYP 10 LOCATIONS)

F.05 01/06/22 CABANA ELEVATIONS APPENDIX A: SITE LIGHTING, 01/06/22

F.02 01/06/22 VILLA (TYP 5 LOCATIONS) 01/06/22 VILLA ELEVATIONS

DESIGN REVIEW SUBMITTAL November 17, 2021

SIERRA NEVADA RESORT

164 OLD MAMMOTH RD,

MAMMOTH LAKES, CA

93546



(S) SPRINGBOARD

SHEET DATE: REVISIONS

DESIGN REVIEW COVER SHEET













The Sierra Nevada Resort will honor the original escape into the wild & unexpected.



SIERRA NEVADA RESORT SP PRESENTATION - SITE PLAN



DESIGN REVIEW SUBMITTAL November 17, 2021

Porte Cochere Entry

4 Fire Pit Area with Adirondack Chairs

7 Flagstone Paved, Recessed Fire Pit with Lounge Seating

6 Trash / Back-of-House Access

Parking Count = 182

2 Retaining Wall

5 Cafe Tables

9 Raised Planter



PROJECT

OVERVIEW

SHEET DATE:

REVISIONS

CHECKED:

PROJECT No.

SHEET TITLE:

CONTEXT MAP +




EXISTING CONDITIONS - OLD MAMMOTH ROAD



EXISTING CONDITIONS INTERSECTION OF LAUREL MOUNTAIN ROAD AND SIERRA NEVADA ROAD



EXISTING CONDITIONS -INTERSECTION OF OLD MAMMOTH ROAD AND SIERRA NEVADA ROAD

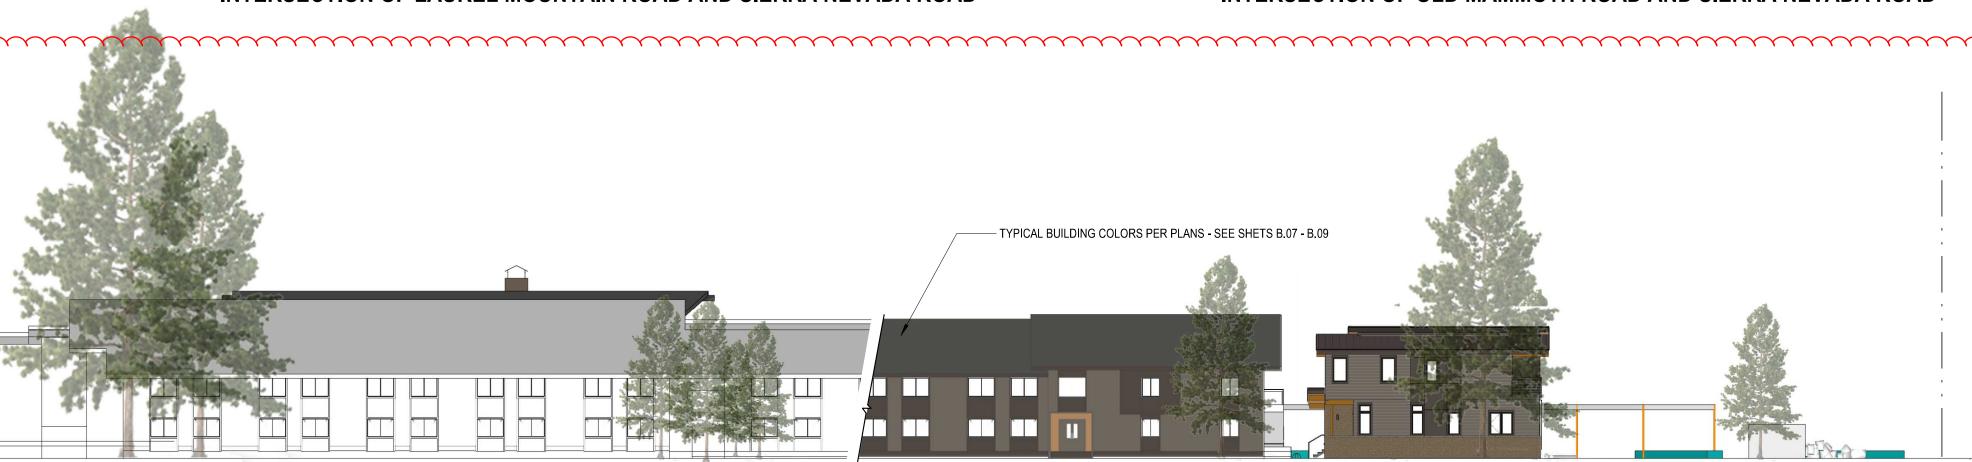



STREET ELEVATION - OLD MAMMOTH ROAD (LOOKING WEST)
SCALE: 1" = 20'-0"



STREET ELEVATION - SIERRA NEVADA ROAD (LOOKING NORTH)
SCALE: 1" = 20'-0"





164 OLD MAMMOTH RD,

MAMMOTH LAKES, CA

DESIGN REVIEW

November 17, 2021

SUBMITTAL

93546

WATERTON WATERTON STREET ELEVATION - LAUREL MOUNTAIN ROAD (LOOKING EAST)
SCALE: 1" = 20'-0" grouparchitect EDG FELLOW (S) SPRINGBOARD

> SHEET DATE: REVISIONS

PROJECT ISSUES:


DESIGN REVIEW SUBMITTAL

CHECKED: PROJECT No.

STREET ELEVATIONS

B.01

ORIGINAL SHEET SIZE IS 24"x36" | PLOT DATE: 1/28/2022 5:15:45 PM

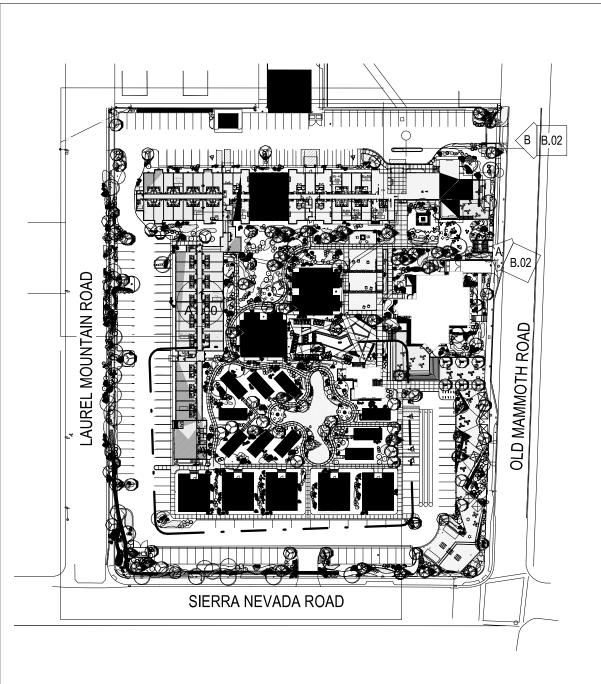



OUTDOOR GARDENS ALONG OLD MAMMOTH ROAD

B.02





PROJECT ENTRY FROM OLD MAMMOTH ROAD



SIERRA NEVADA RESORT 164 OLD MAMMOTH RD,

MAMMOTH LAKES, CA


DESIGN REVIEW SUBMITTAL November 17, 2021

93546



PROJECT No.

SHEET DATE: REVISIONS

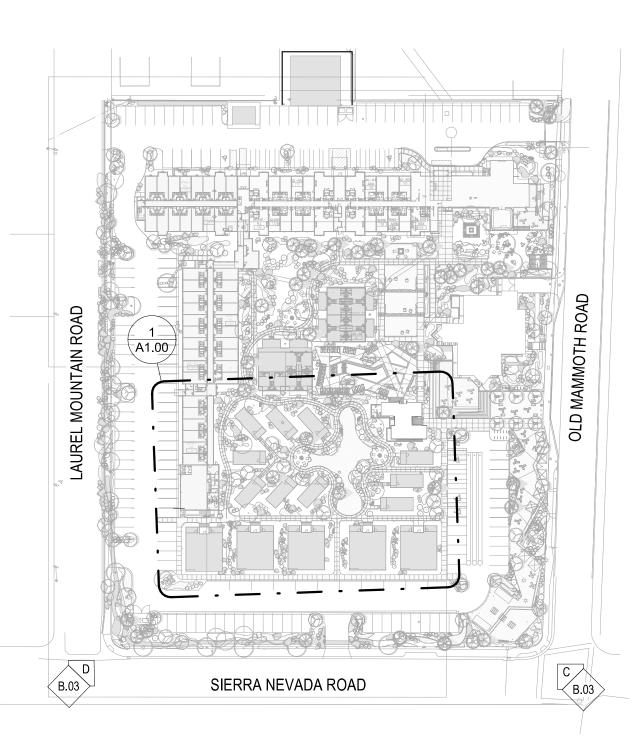

















INTERSECTION OF SIERRA NEVADA ROAD + LAUREL MOUNTAIN ROAD






DESIGN REVIEW SUBMITTAL November 17, 2021



CHECKED: PROJECT No.

SHEET TITLE:
PROJECT PERSPECTIVES -STREET **FRONTAGES**

SHEET DATE: REVISIONS

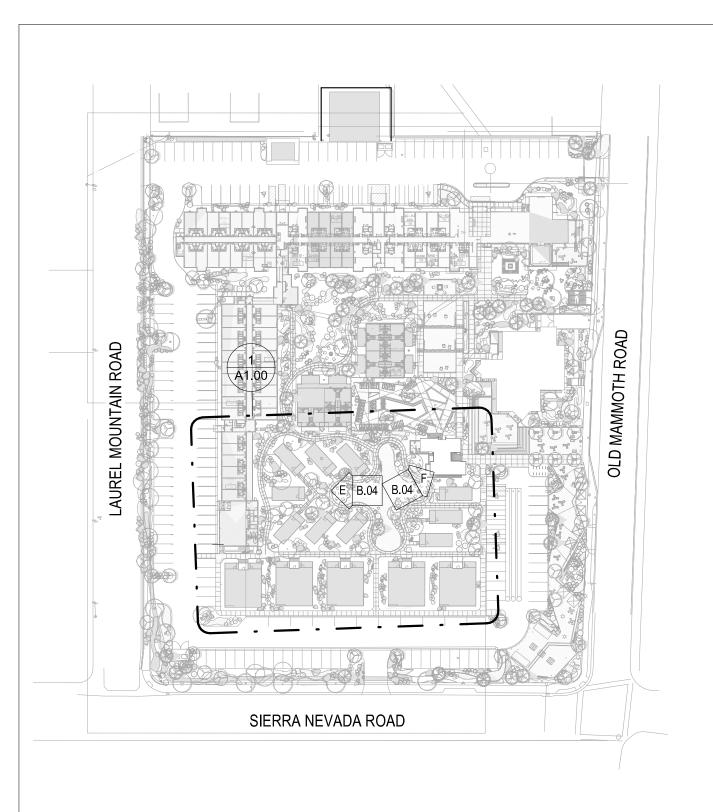



OPEN SPACE AT CABINS - LOOKING WEST





OPEN SPACE AT CABINS - LOOKING EAST





164 OLD MAMMOTH RD,

MAMMOTH LAKES, CA

DESIGN REVIEW SUBMITTAL November 17, 2021

93546




PROJECT No. SHEET TITLE:
PROJECT

PERSPECTIVES -**CABIN OPEN SPACE**

SHEET DATE: REVISIONS

CHECKED:

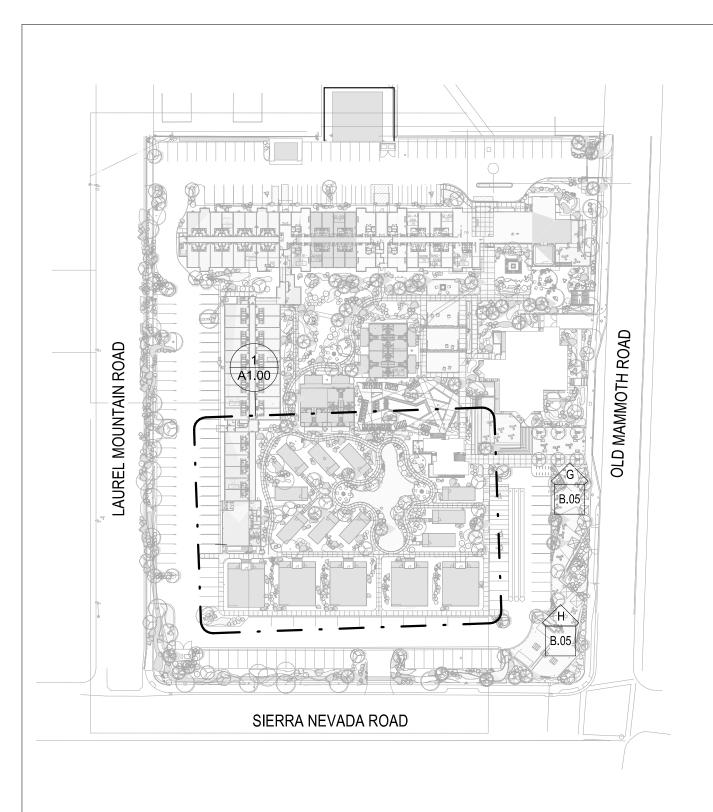



FOOD GARDEN AT RAFTERS RESTAURANT

B.05





FOOD GARDEN (SOUTH) LOOKING NORTH





SIERRA NEVADA RESORT 164 OLD MAMMOTH RD,

MAMMOTH LAKES, CA

DESIGN REVIEW SUBMITTAL November 17, 2021


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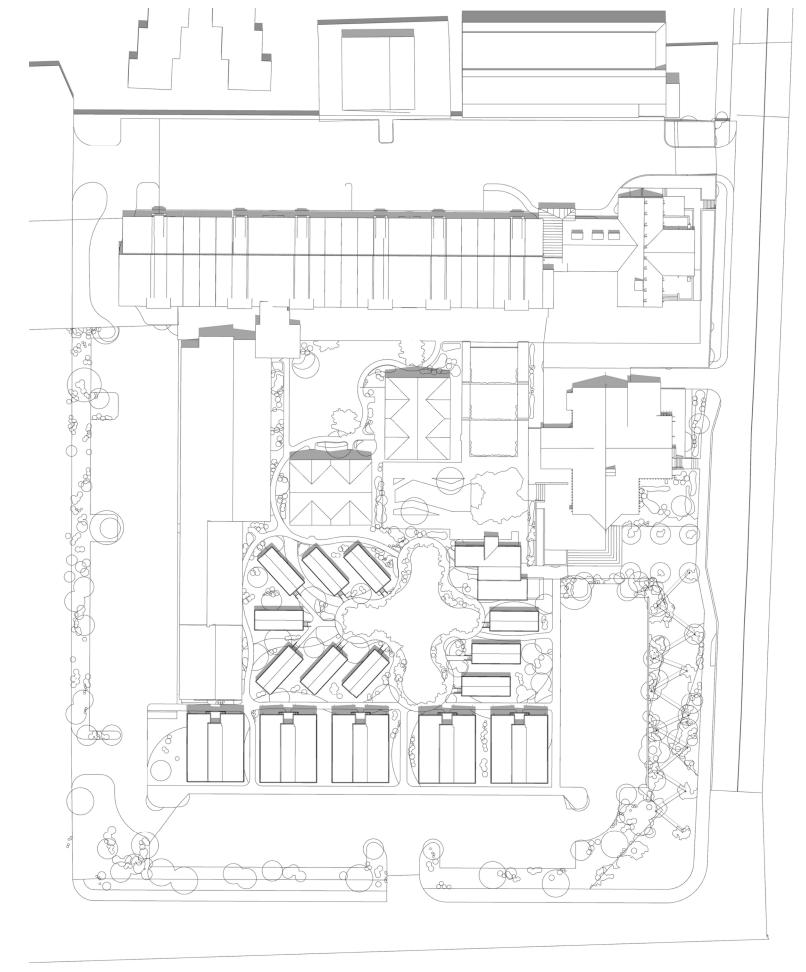



SHEET DATE: REVISIONS

CHECKED: PROJECT No.


SHEET TITLE:
PROJECT PERSPECTIVES -**FOOD GARDEN**




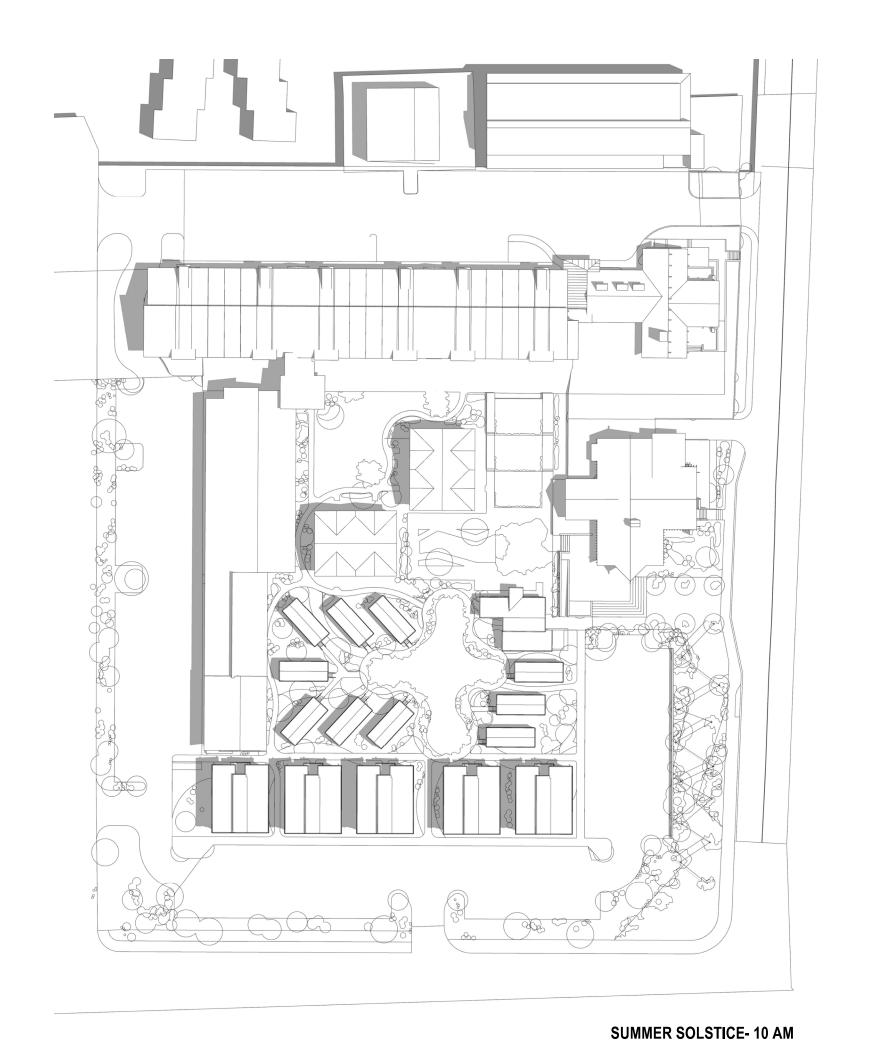

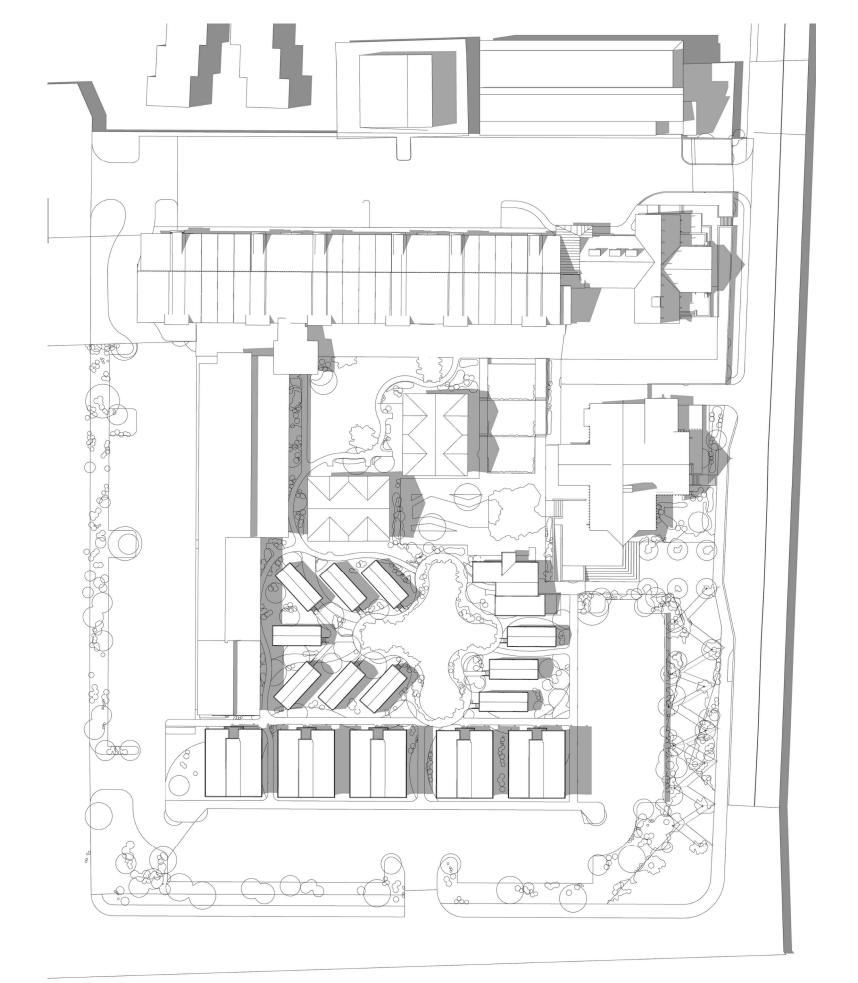


SUMMER SOLSTICE - 15 PM

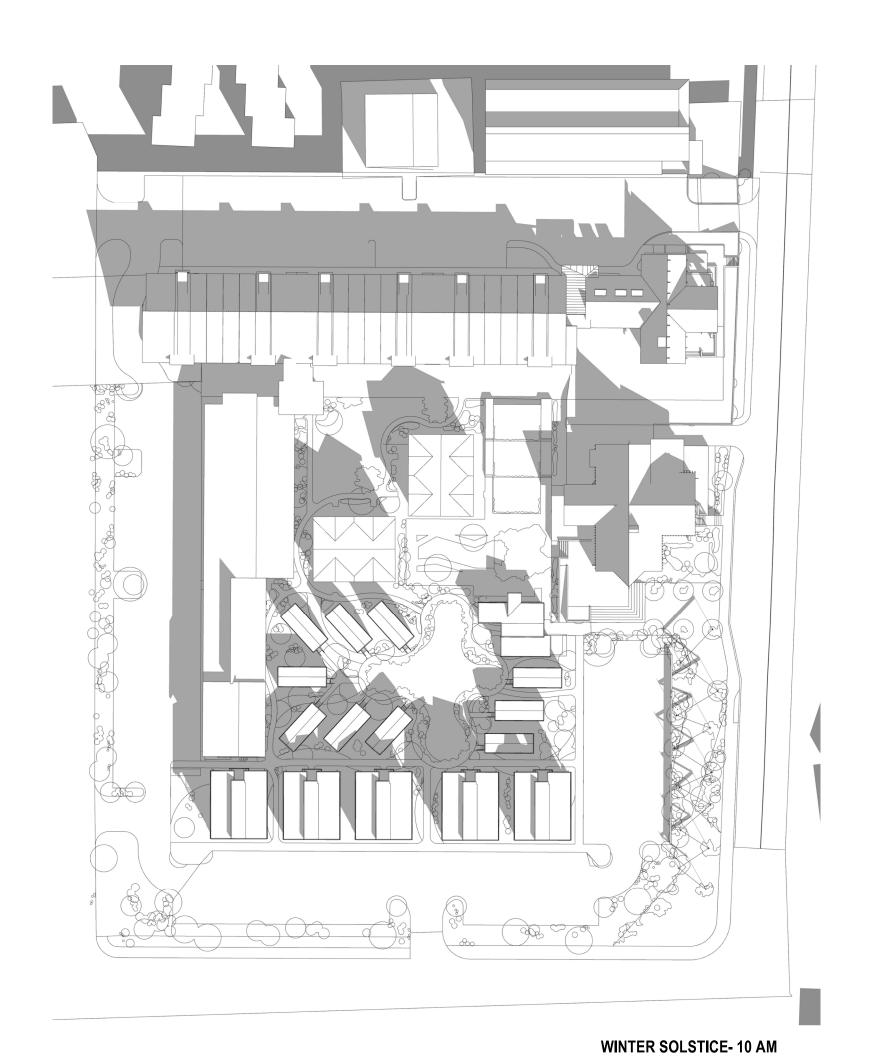

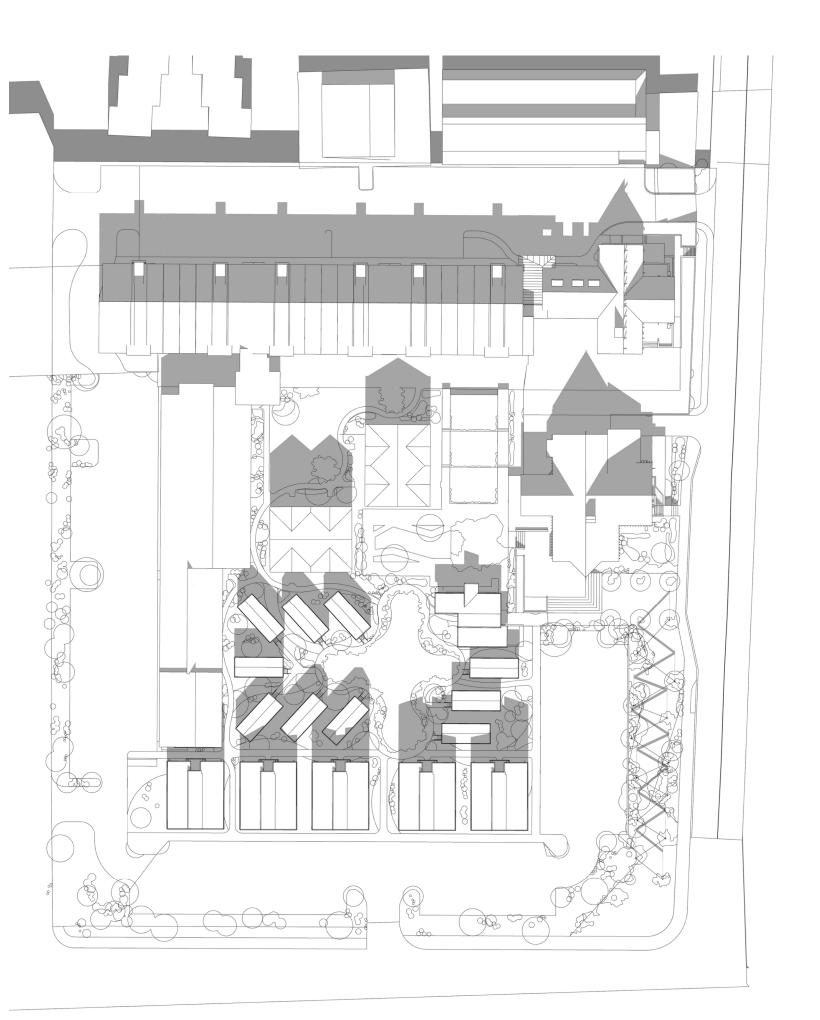

SUMMER SOLSTICE - 12 PM

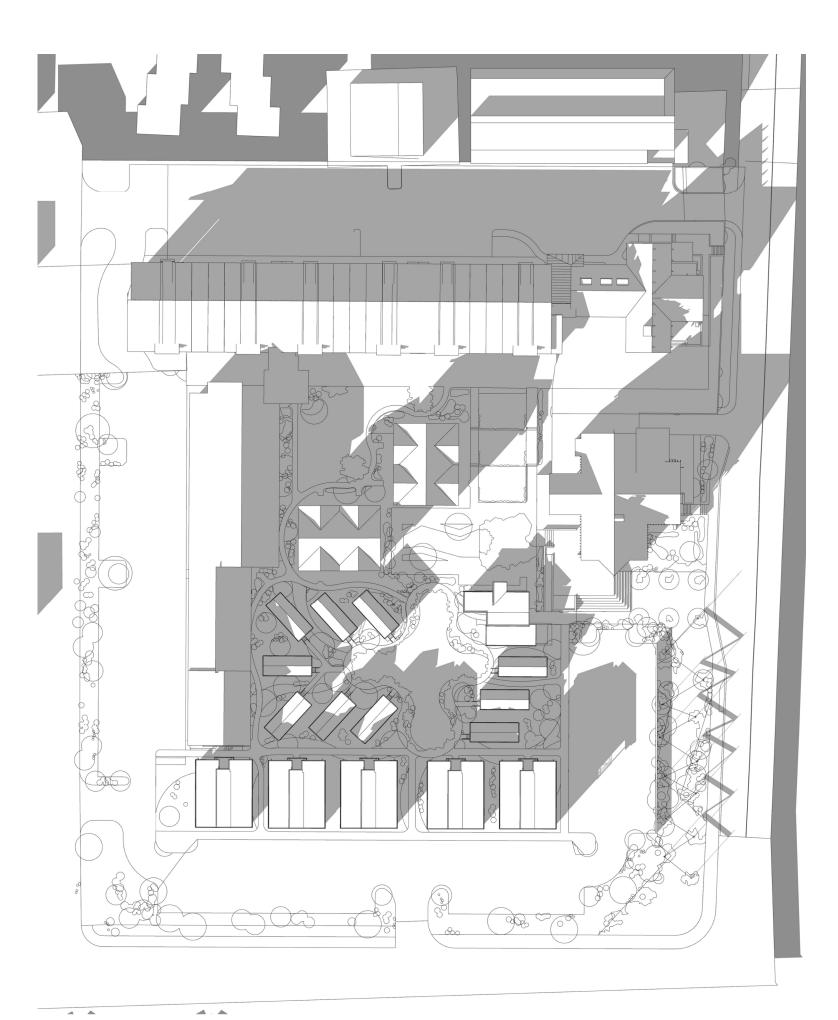

WINTER SOLSTICE - 15 PM WINTER SOLSTICE - 12 PM

SIERRA NEVADA RESORT

164 OLD MAMMOTH RD,

MAMMOTH LAKES, CA

DESIGN REVIEW SUBMITTAL November 17, 2021


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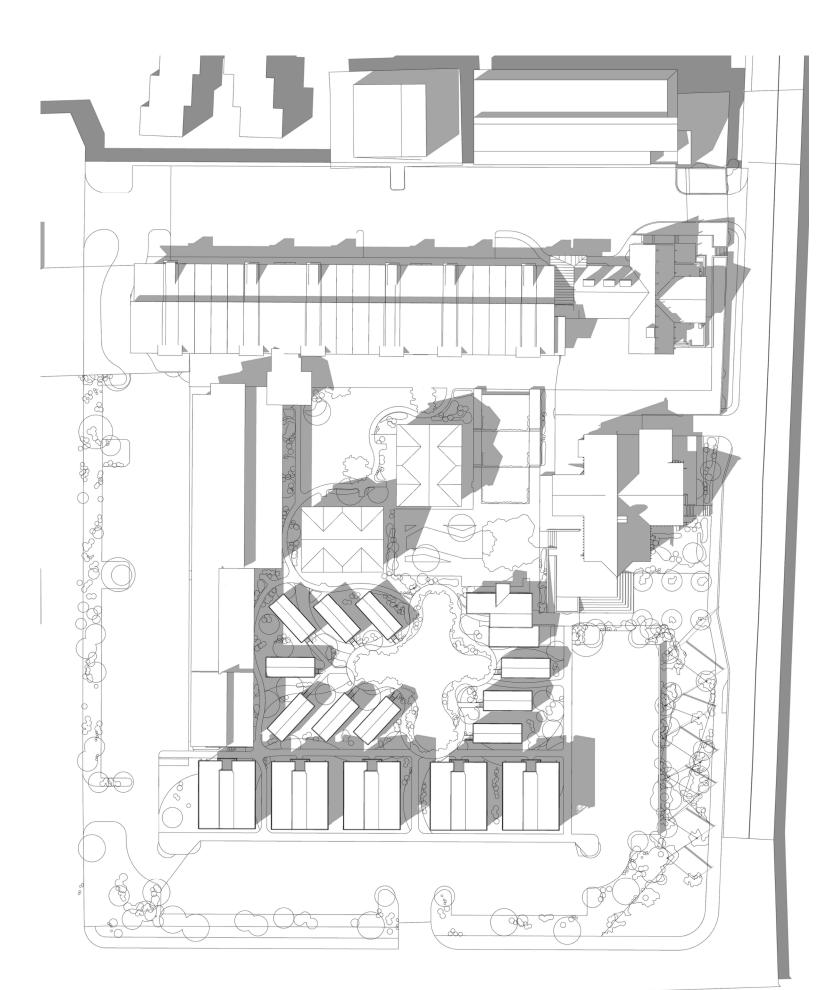


SHEET TITLE: **SHADOW STUDIES**

SHEET DATE: REVISIONS

CHECKED: PROJECT No.



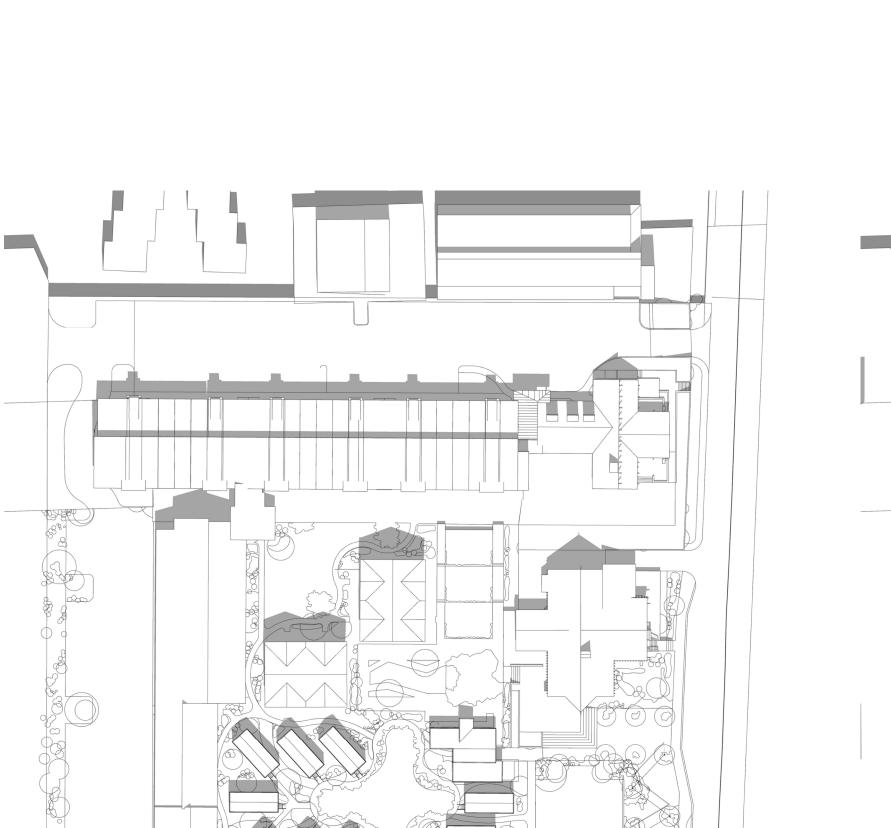



SPRING EQUINOX - 10 AM

SPRING EQUINOX - 12 PM

SPRING EQUINOX - 15 PM

SIERRA NEVADA RESORT

164 OLD MAMMOTH RD, MAMMOTH LAKES, CA 93546

DESIGN REVIEW SUBMITTAL November 17, 2021



SHEET DATE: REVISIONS

CHECKED: PROJECT No.

SHEET TITLE:
SHADOW STUDIES

B.06a






NEW / PROPOSED BUILDING - VILLAS (SIDE)
SCALE: 1/4" = 1'-0" **4**B.07

NEW / PROPOSED BUILDING - VILLAS (FRONT)
SCALE: 1/4" = 1'-0"






NEW / PROPOSED BUILDING - CABANA B.07 SCALE: 1/4" = 1'-0"

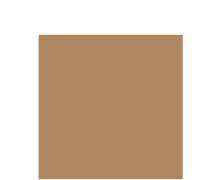

NEW / PROPOSED BUILDINGS - CABINS

PT-B1 **EXISTING SIDING** (REPAINT) SHERWIN WILLIAMS SW XXXX - TBD (MATCH WD-2 / CB-4)

SCALE: 1/4" = 1'-0"

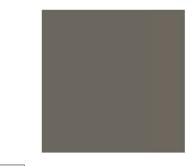


PT-G1 **EXISTING SIDING** (REPAINT) SHERWIN WILLIAMS SW XXXX - TBD (MATCH CB-1 WOODTONE STONE

GREY)



CB-4 CEMENT BOARD LAP SIDING CB-1 WOODTONE - RUSTIC LAP IN "SUMMER WHEAT"

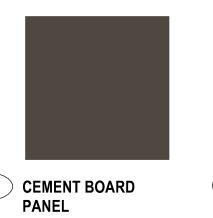

SHERWIN WILLIAMS SW 7020 BLACK FOX OR SIM



CB-2 CEMENT BOARD LAP SIDING WOODTONE -RUSTIC LAP IN "RIVER ROCK"



WD-2 CEDAR LAP SIDING CEDAR NICKEL GAP T&G, STAIN TBD



SV-1 STONE VENEER CERTAINTEED STONEFACADE -"HARBOR

SUNSET"



WN-1 WINDOW MARVIN ESSENTIAL IN "BRONZE"



MS-1 METAL - CAP / FLASHING KYNAR, DARK BRONZE



MS-2 METAL ROOFING

BOARD & BATTEN KYNAR, DARK BRONZE



SHEET DATE: REVISIONS

CHECKED: PROJECT No.

SHEET TITLE:

PROJECT

PROPOSED

SIERRA NEVADA RESORT

164 OLD MAMMOTH RD,

MAMMOTH LAKES, CA

DESIGN REVIEW

November 17, 2021


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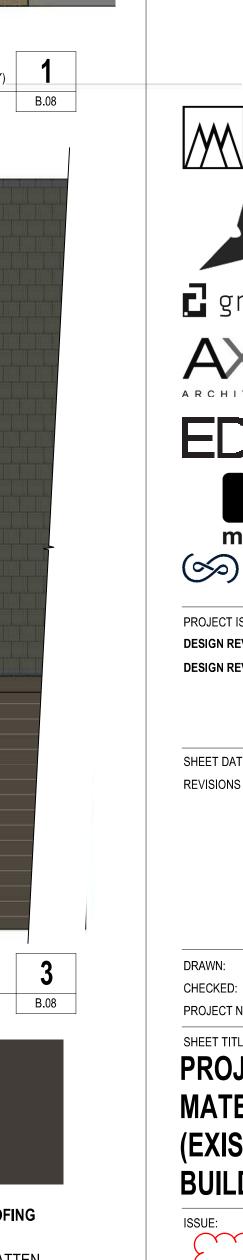
93546

BUILDINGS) ISSUE: PERMIT SET $\sim\sim\sim\sim$ **B.07**

MATERIALS (NEW /

01/28/22



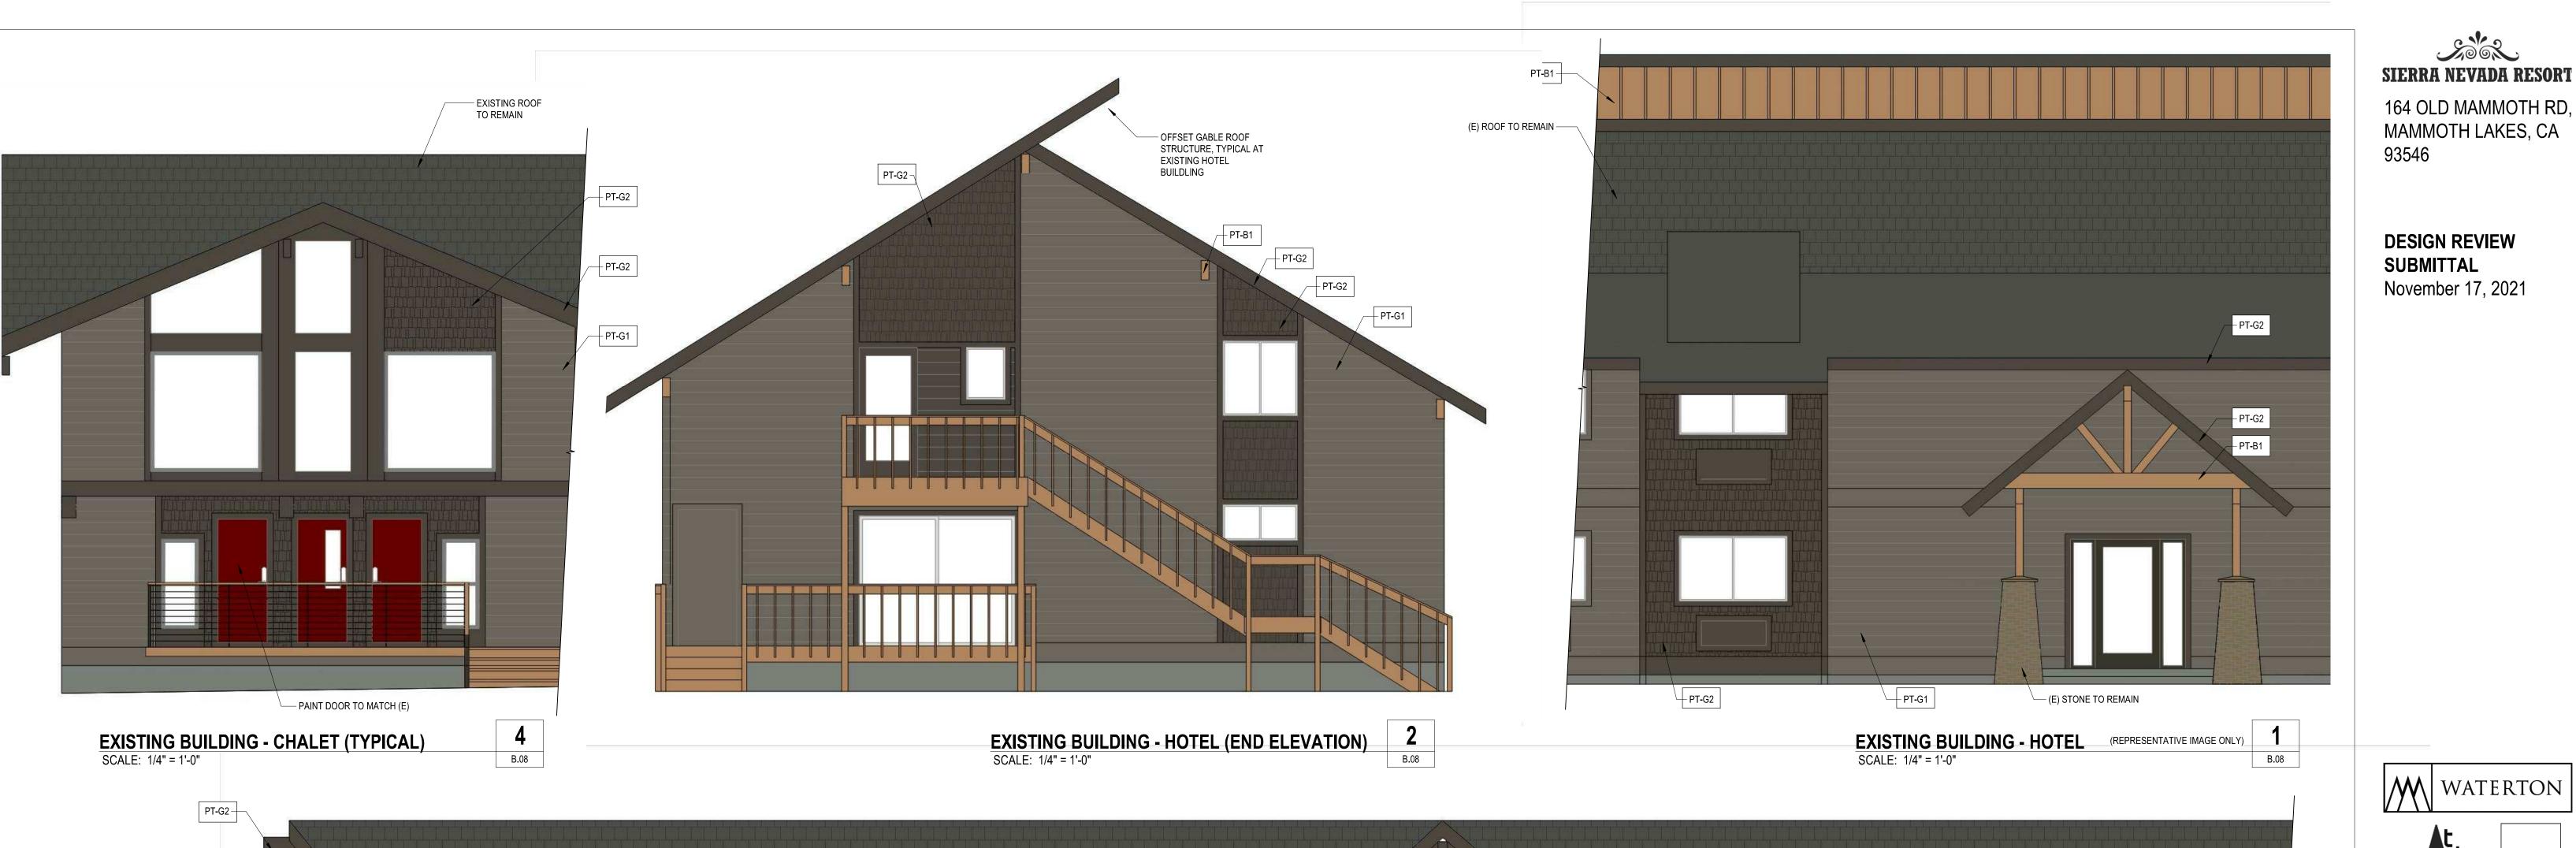



01/28/22







DESIGN REVIEW SUBMITTAL November 17, 2021

WATERTON

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PROJECT
MATERIALS
(EXISTING

BUILDINGS)
ISSUE:

SHEET DATE:

REVISIONS

DRAWN:

CHECKED:

PROJECT No.

PERMIT SET

01/28/22



Code Compliance Research Report CCRR-0259

Issue Date: 01-06-2017 Revision Date: 12-23-2020 Renewal Date: 01-31-2022

DIVISION: 04 00 00 MASONRY Section: 04 73 00 Manufactured Stone Masonry

REPORT HOLDER:

CERTAINTEED LLC 20 Moores Road Malvern, PA 19355

REPORT SUBJECT:

www.certainteed.com

STONEfacade™ Exterior Wall Covering

1.0 SCOPE OF EVALUATION

1.1 This Research Report addresses compliance with the following Codes:

- ▶ 2018, 2015 International Building Code® (IBC) 2018, 2015 International Residential Code® (IRC) 2020 Florida Building Code (FBC) excluding HVHZ (See
- NOTE: This report references 2018 IBC sections with 2015 IBC and FBC sections shown in brackets where they differ.

1.2 CertainTeed's STONEfacade™ has been evaluated for the following properties:

- Strength
- Durability Combustibility
- Surface Burning Characteristics

Section 9.0.)

- Weather Protection Wind Resistance
- 1.3 CertainTeed's STONEfacade™ has been evaluated for the
- following uses: Use as an exterior wall covering in accordance with IBC
- Use on exterior walls of Type V construction. Use as an interior wall finishes IBC Section 803 and IRC
- Section 1402 [1403], 1403 [1404] and IRC Section R703.

2.0 STATEMENT OF COMPLIANCE

CertainTeed's STONEfacade™ complies with the Codes listed in Section 1.1, for the properties stated in Section 1.2 and uses stated in Section 1.3, when installed as described in this report, including the Conditions of Use stated in Section 6.0.

3.0 DESCRIPTION

3.1 STONEfacade™ is a pre-cast concrete and galvanized or stainless-steel panel that simulates natural stone. The concrete is cast with an integrated galvanized or stainless steel rain screen insert creating the exterior facade panels. The façade is produced in three lengths 10", 14" and 24". All panels are 8" in height. The thickness of panels varies based on stone profile from 1 inch to 2.38 inch. See Figure 1, 2, 3 and 4 for details.

3.2 Galvanized or stainless steel rain screen inserts have predrilled holes on the top flange of each panel spaced at 1" to attach to exterior walls.

3.3 Galvanized or stainless steel starter strips are used at the first course of installed panels. See Figure 4.

3.3 Corner panels, light boxes, electrical boxes and sills are additional details used to finish the exterior and also simulate natural stone.

4.0 PERFORMANCE CHARACTERISTICS

4.1 Density: The average density of the panel concrete is 90 lb/ft3 determined in accordance with ASTM C567.

4.2 Durability: The panels met the conditions of acceptance after 50 cycles of freeze-thaw in accordance with Section 4.2

4.3 Weight: The saturated weight of the panels is 12.6 pounds per square foot determined in accordance with Section 4.1 of AC51.



Section R302.9

545 E. Algonquin Road • Arlington Heights • Illinois • 60005

Version: 21 December 2017

SFT-CCRR-OP-40b

TESTED FOR ACCEPTANCE AFTER 50 CYCLES OF FREEZE-THAW PER ICC-ES AC51 - ADHERED MANUFACTURED STONE MASONRY VENEER https://www.certainteed.com/resources/STONEfacade_CCRR-0259_Report_0118.pdf

https://bpdirectory.intertek.com/pages/DLP_Search.aspx https://specdirect.intertek.com/controls/SDDocumentViewer.aspx?ccrr=CCRR-0259

Great features for lasting beauty



Fully-integrated rainscreen A 3/8" steel insert embedded into each panel allows top-to-bottom drainage that protects walls from moisture build-up, and reduces the

potential for moisture-related issues.

Avoid moisture issues and unwanted call backs



that has a true integrated rainscreen. That's essential pecause moisture intrusion on the exterior wall is one of the leading reasons for wall assembly failure - and costly call backs. Our integrated rainscreen is designed to allow adequate airflow behind the panel. This promotes drying and helps eliminate potential moisture issues like mold and mildew within the wall cavity.




Patented technology Fully-integrated rainscreen, and a fastening flange that is designed to

provide ease of installation.

Beveled perimeter

Improves overall fit and finish for an uninterrupted appearance along the length of the wall.

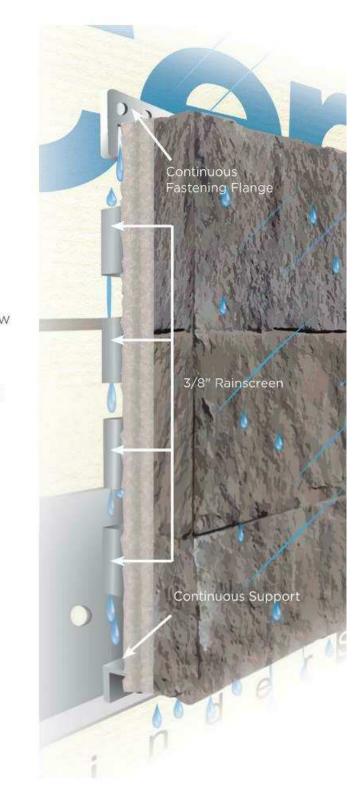

Exceptional looks and performance

nder STUDfinder STUDfinder S

STONE façade

STONEfaçade is an easy-to-install product that replicates the look and feel of real stone, and has been tested to withstand the industry's most stringent performance standards.

The look and feel of real stone

CertainTeed employs a unique hand-applied technique to give STONEfaçade products the infinite tonal variations of natural stone. The nature-inspired color options give your customer the freedom to create any design they can imagine. It will enhance any home - whether as an accenting kneewall, to add a distinctive touch around an entryway, or to highlight an architectural focal point.







STONEfa



STONEfaçade is molded from natural stones that are individually selected and positioned by our craftsmen, creating panels that mimic the irregular patterns and variegated colors of hand-laid stone. STONEfaçade covers over 110 square feet without a repeat.



No other stone veneer product offers the features and benefits of STONEfaçade: fully-integrated rainscreen, screw-in-place mortarless installation, unique panel configurations, and a full complement of matching accessories that includes sills, corners, and electrical and light boxes.

Panel height is 8" and either 10", 14" or 24" in width, so they're easy to handle. The assorted panel lengths minimize the panelized appearance on the wall.

Less room for error Installs in cold weather

Traditional masonry must be installed in temperatures above 40°F to avoid the risks of mortar and grout failure. With STONEfaçade, there's no mortar involved, so installations can go on when temperatures drop.




CertainTeed STONEfaçade installs SIX TIMES faster than traditional stone, helping your customers get to the next job faster.

Approximately one square of traditional masonry can be installed per day - and it can take multiple days to complete a job. Three to four squares of STONEfaçade can be installed in a single day, keeping crews productive.

Traditional masonry veneer installation

- 1. Install weep screen
- 2. Install a layer of WRB
- 3. Install another layer of WRB 4. Intall lath
- 5. Apply mortar scratch coat
- 6. Apply mortar setting bed
- 7. Adhere masonry 8. Mortar joints

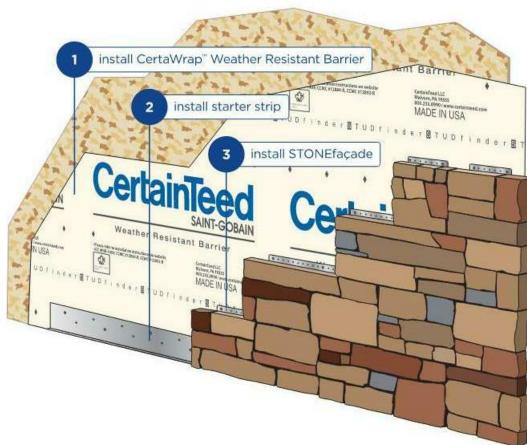









SIERRA NEVADA RESORT 164 OLD MAMMOTH RD, MAMMOTH LAKES, CA

DESIGN REVIEW SUBMITTAL November 17, 2021

93546




EDG FELLOW (S) SPRINGBOARD

PROJECT ISSUES: DESIGN REVIEW SUBMITTAL DESIGN REVIEW RESUBMITTAL

SHEET DATE: REVISIONS

CHECKED: PROJECT No.

SHEET TITLE: PROPOSED STONE **CLADDING AT NEW BUILDINGS**

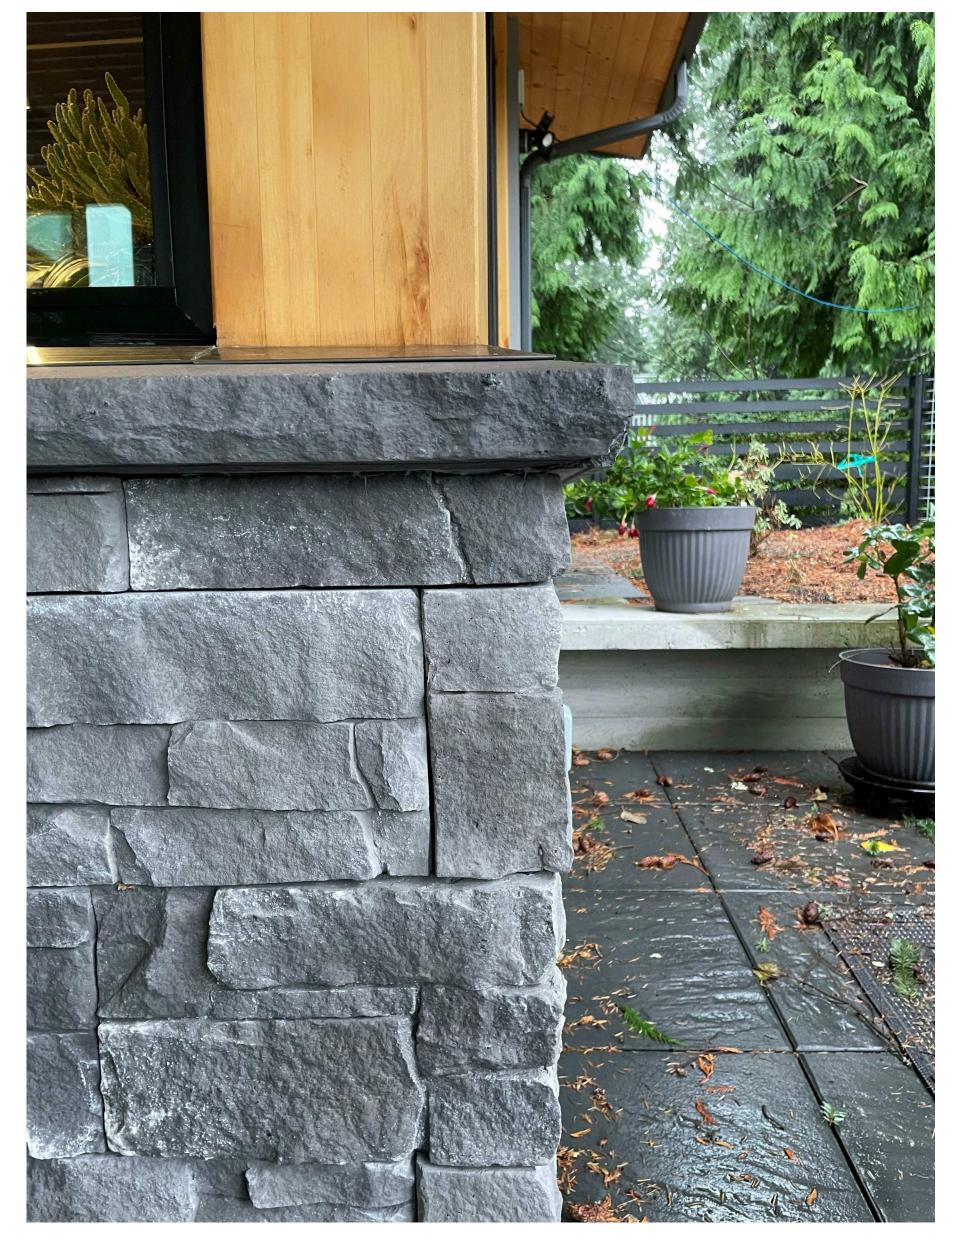




EXAMPLE INSTALLATION. CERTAINTEED STONE FACADE, COLOR: HARBOR SUNSET. PROPOSED COLOR.









EXISTING STONE VENEER ACCENTS AT SIERRA NEVADA RESORT

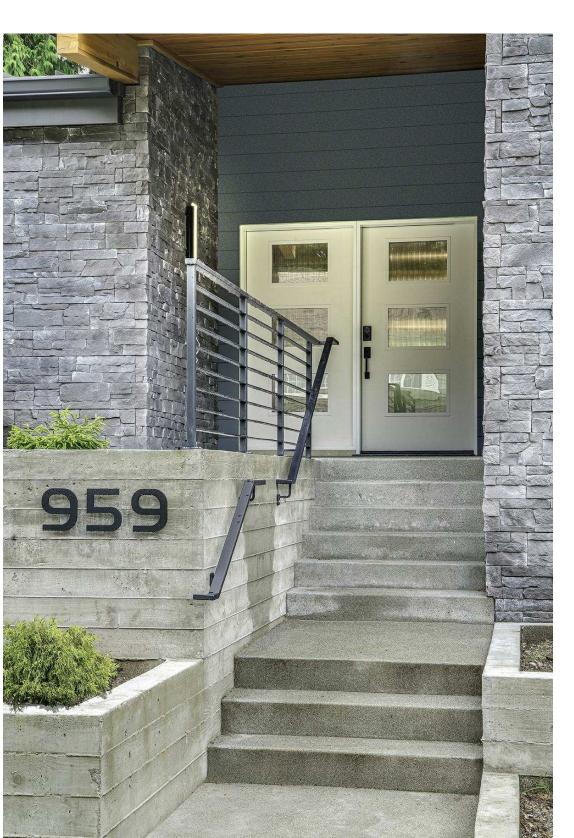



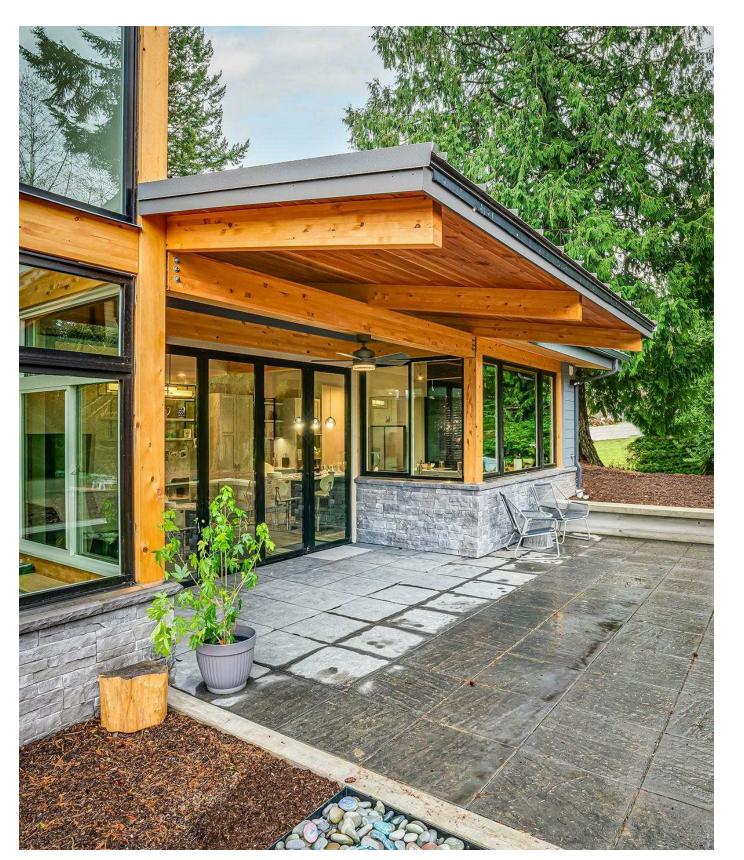

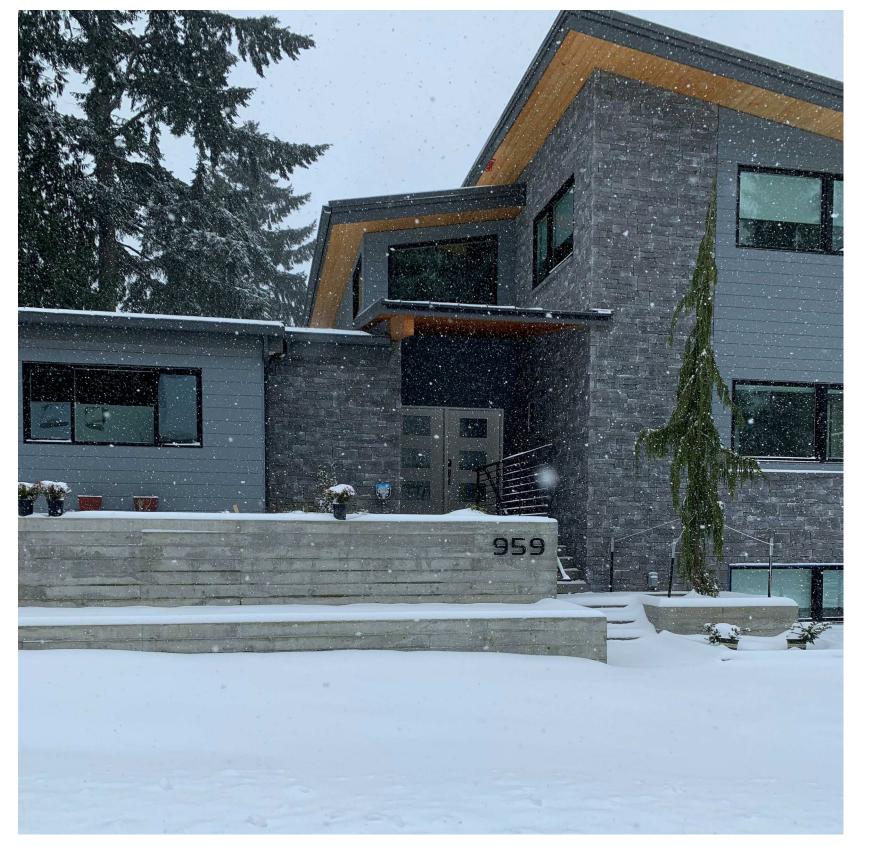

164 OLD MAMMOTH RD, MAMMOTH LAKES, CA 93546

DESIGN REVIEW SUBMITTAL November 17, 2021




SHEET DATE: REVISIONS

CHECKED:

PROJECT No. SHEET TITLE: PROPOSED STONE **CLADDING AT NEW**

BUILDINGS

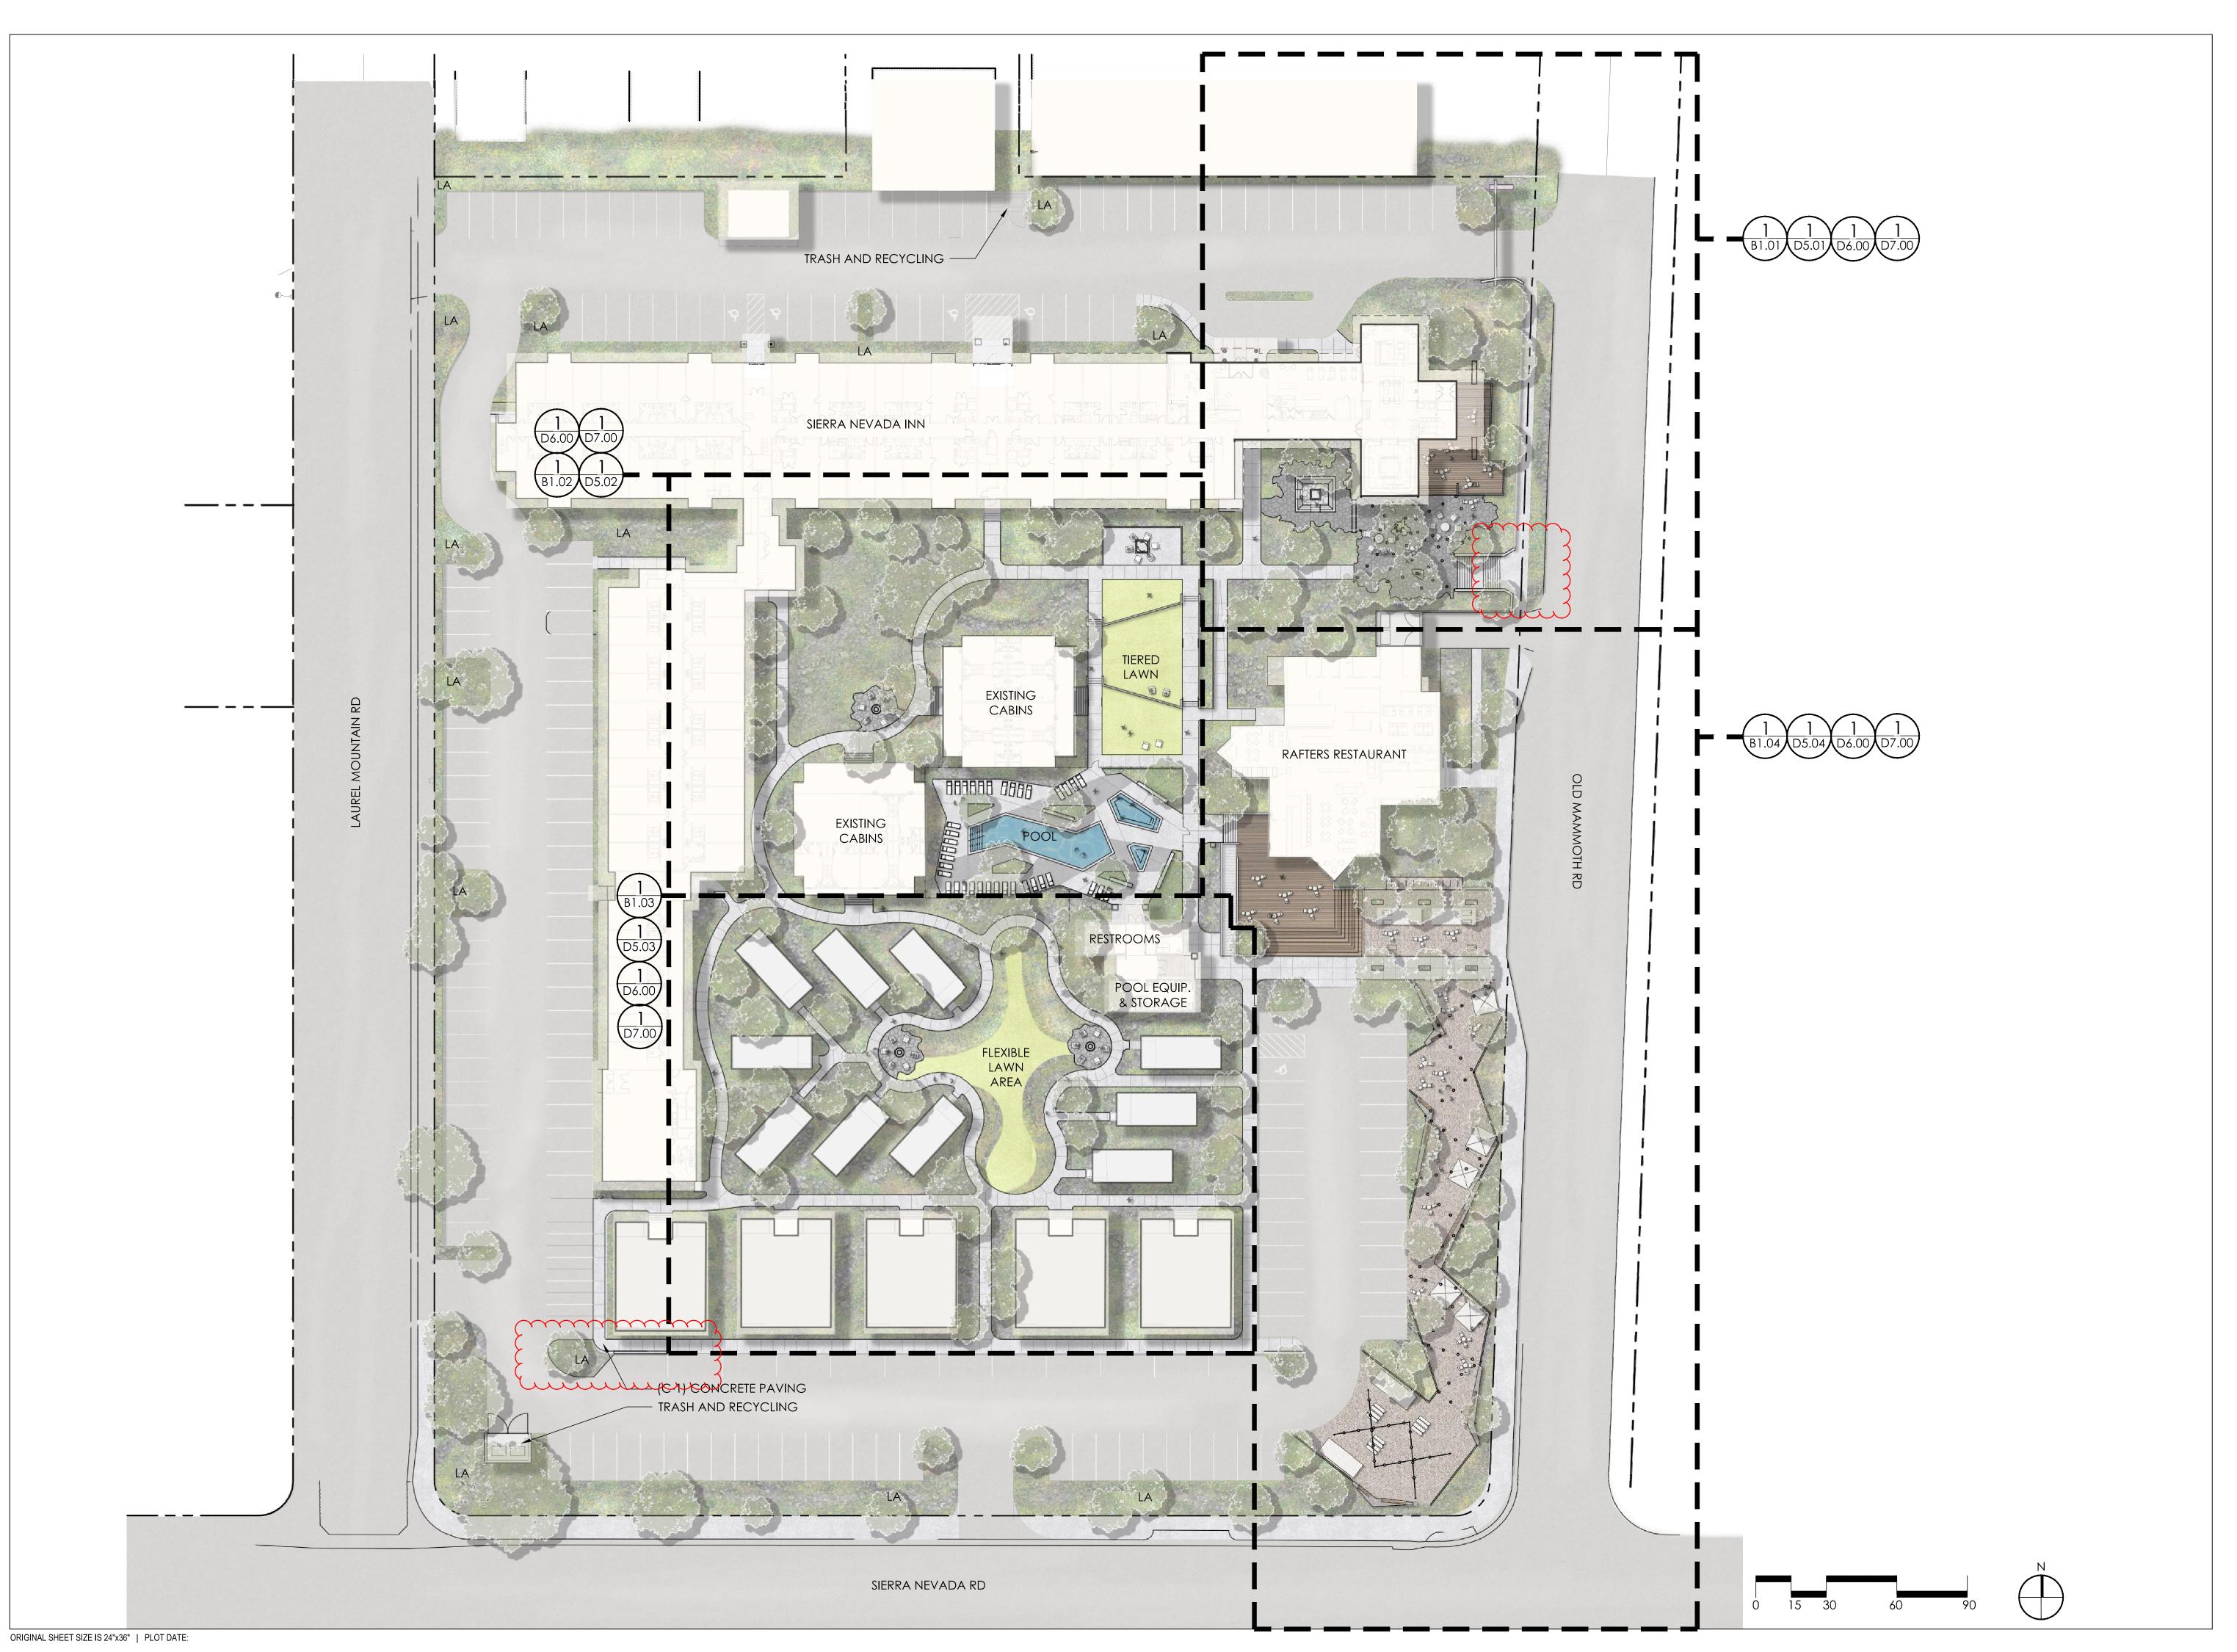

164 OLD MAMMOTH RD, MAMMOTH LAKES, CA 93546

DESIGN REVIEW SUBMITTAL

November 17, 2021

WATERTON

the Lagrangian grouparchitect

AXISCF/
ARCHITECTURE + DESIGN

EDG FELLOW

SPRINGBOARD
HOSPITALITY
PROJECT ISSUES:

method homes

PROJECT ISSUES:

DESIGN REVIEW SUBMITTAL 11/17/2021


DESIGN REVIEW RESUBMITTAL 01/28/2022

SHEET DATE: REVISIONS

DRAWN:
CHECKED:
PROJECT No.

OVERALL SITE PLAN

ISSUE: **DESIGN REVIEW SUBMITTAL**

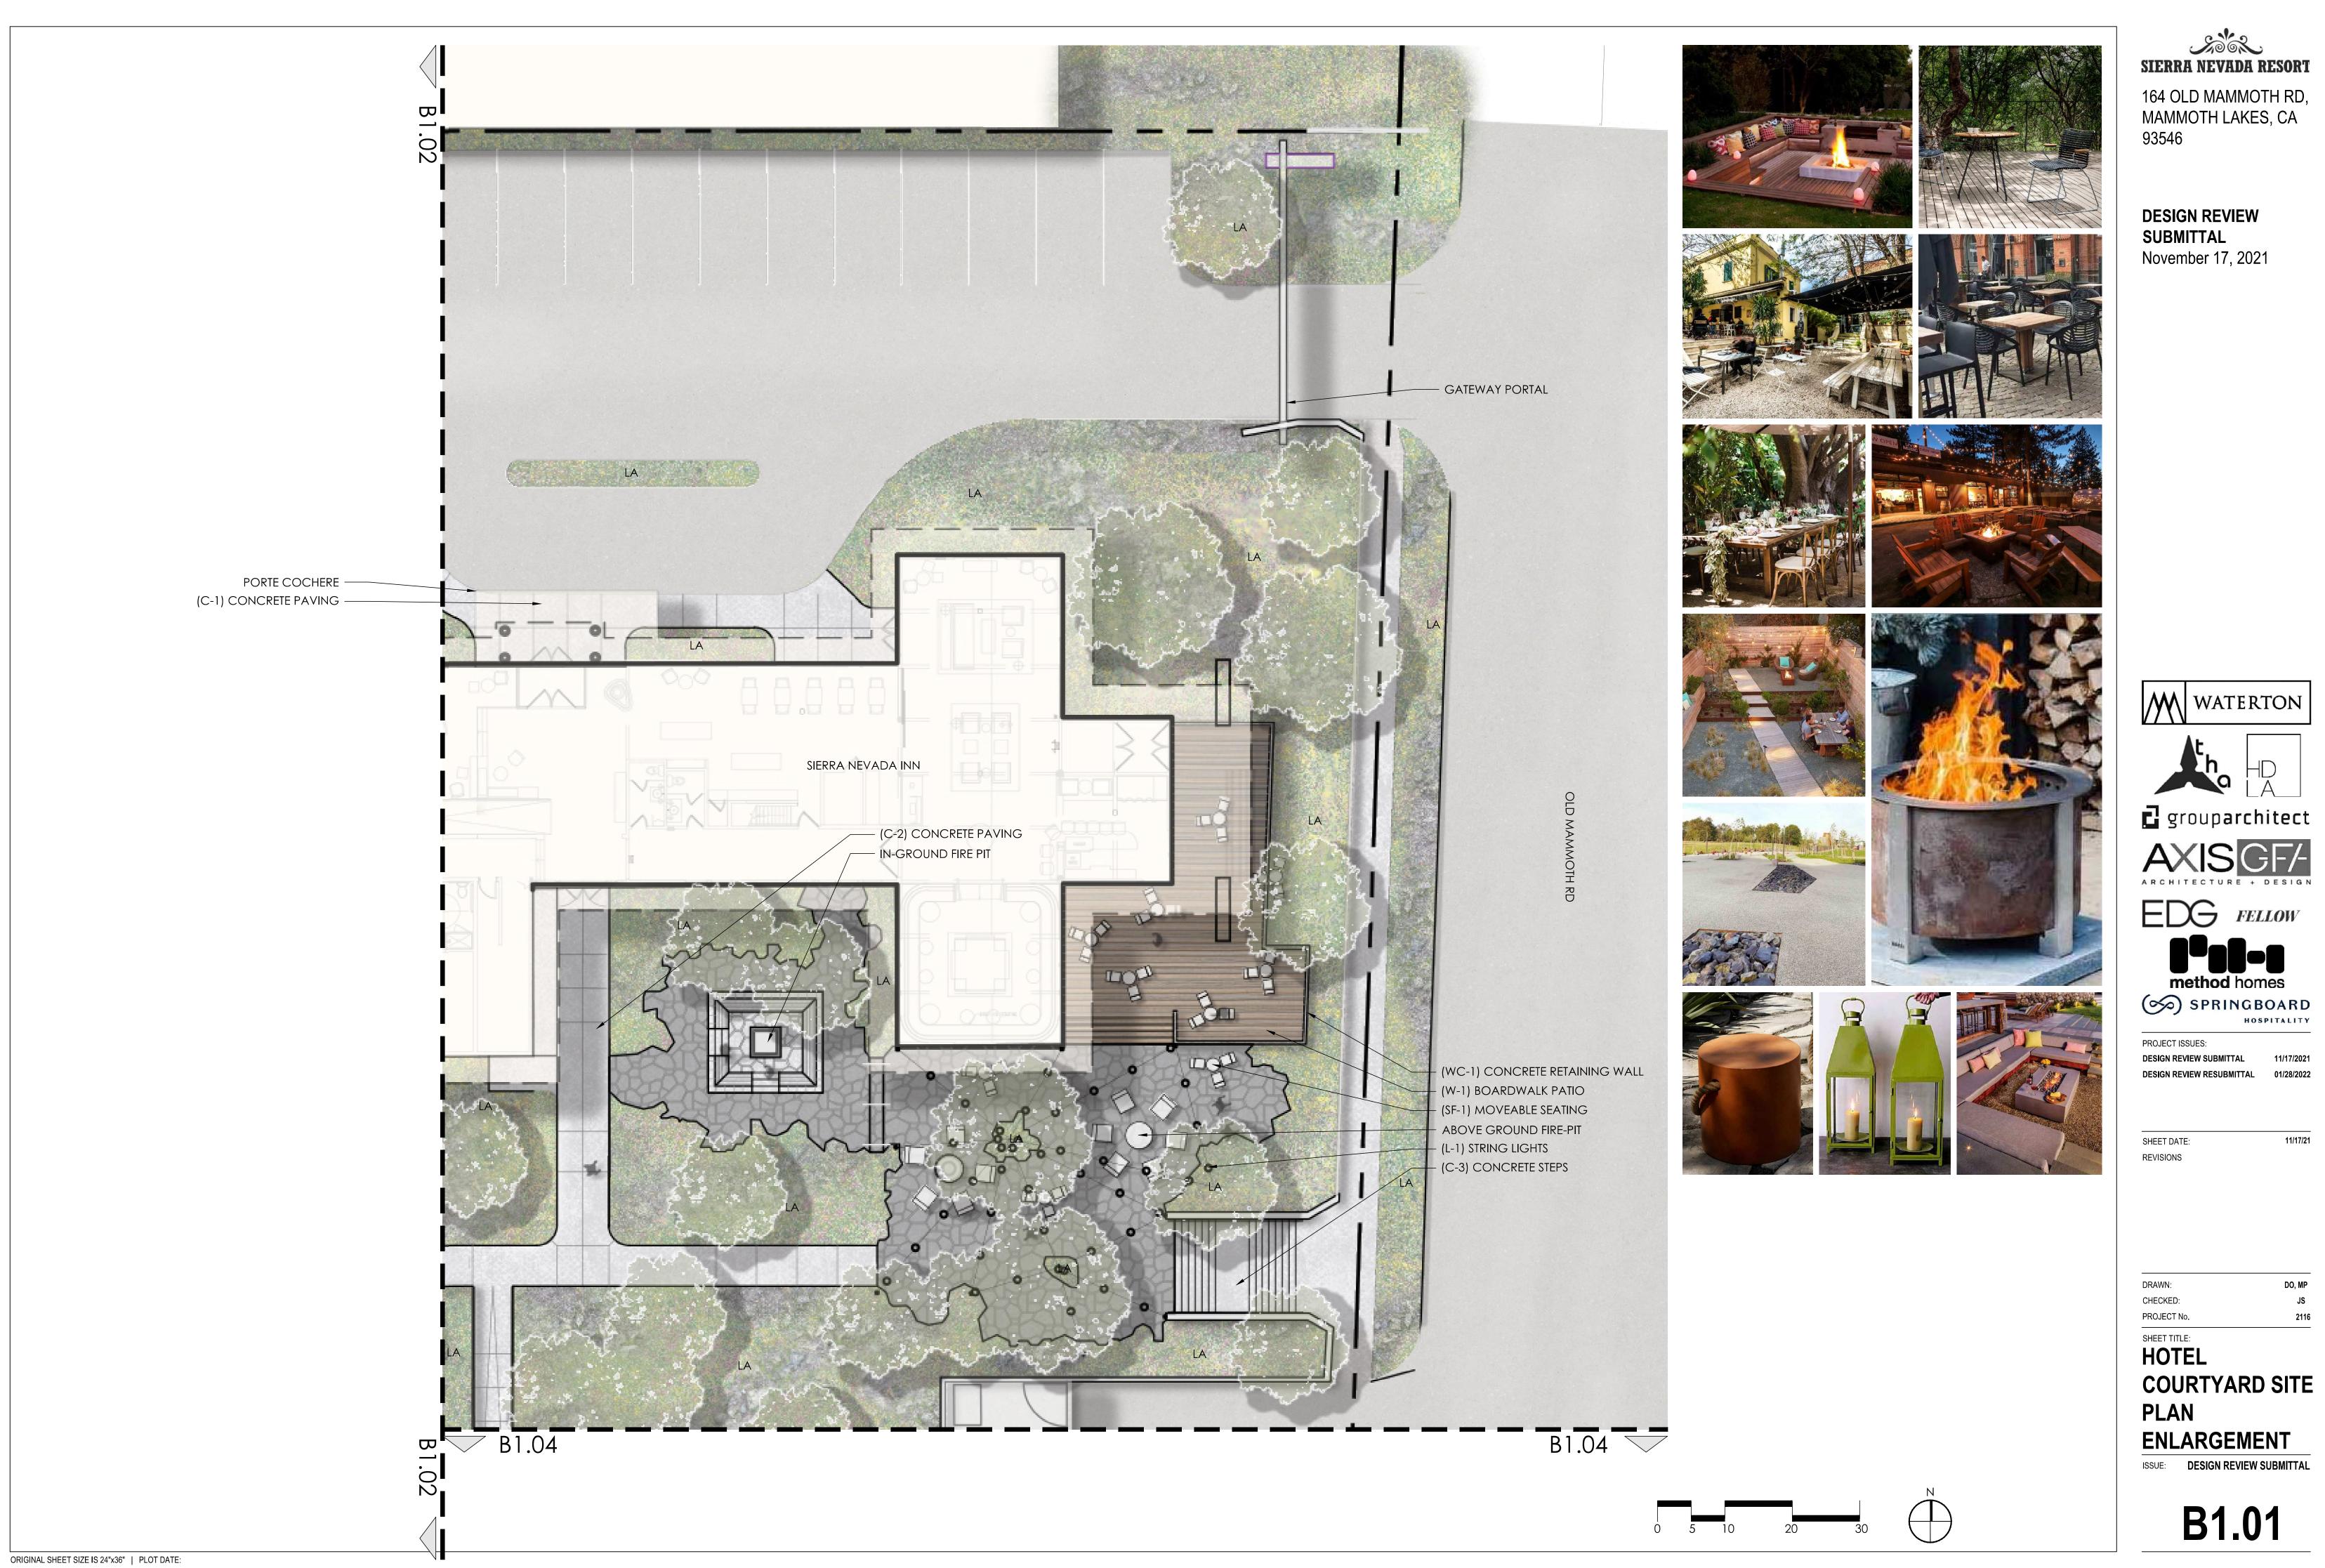

method homes




164 OLD MAMMOTH RD, MAMMOTH LAKES, CA 93546

DESIGN REVIEW SUBMITTAL November 17, 2021

WATERTON WATERTON grouparchitect AXIS GF-EDG FELLOW method homes SPRINGBOARD
HOSPITALITY PROJECT ISSUES: **DESIGN REVIEW SUBMITTAL**

CHECKED: PROJECT No.

SHEET TITLE: **COURTYARD SITE PLAN ENLARGEMENT**

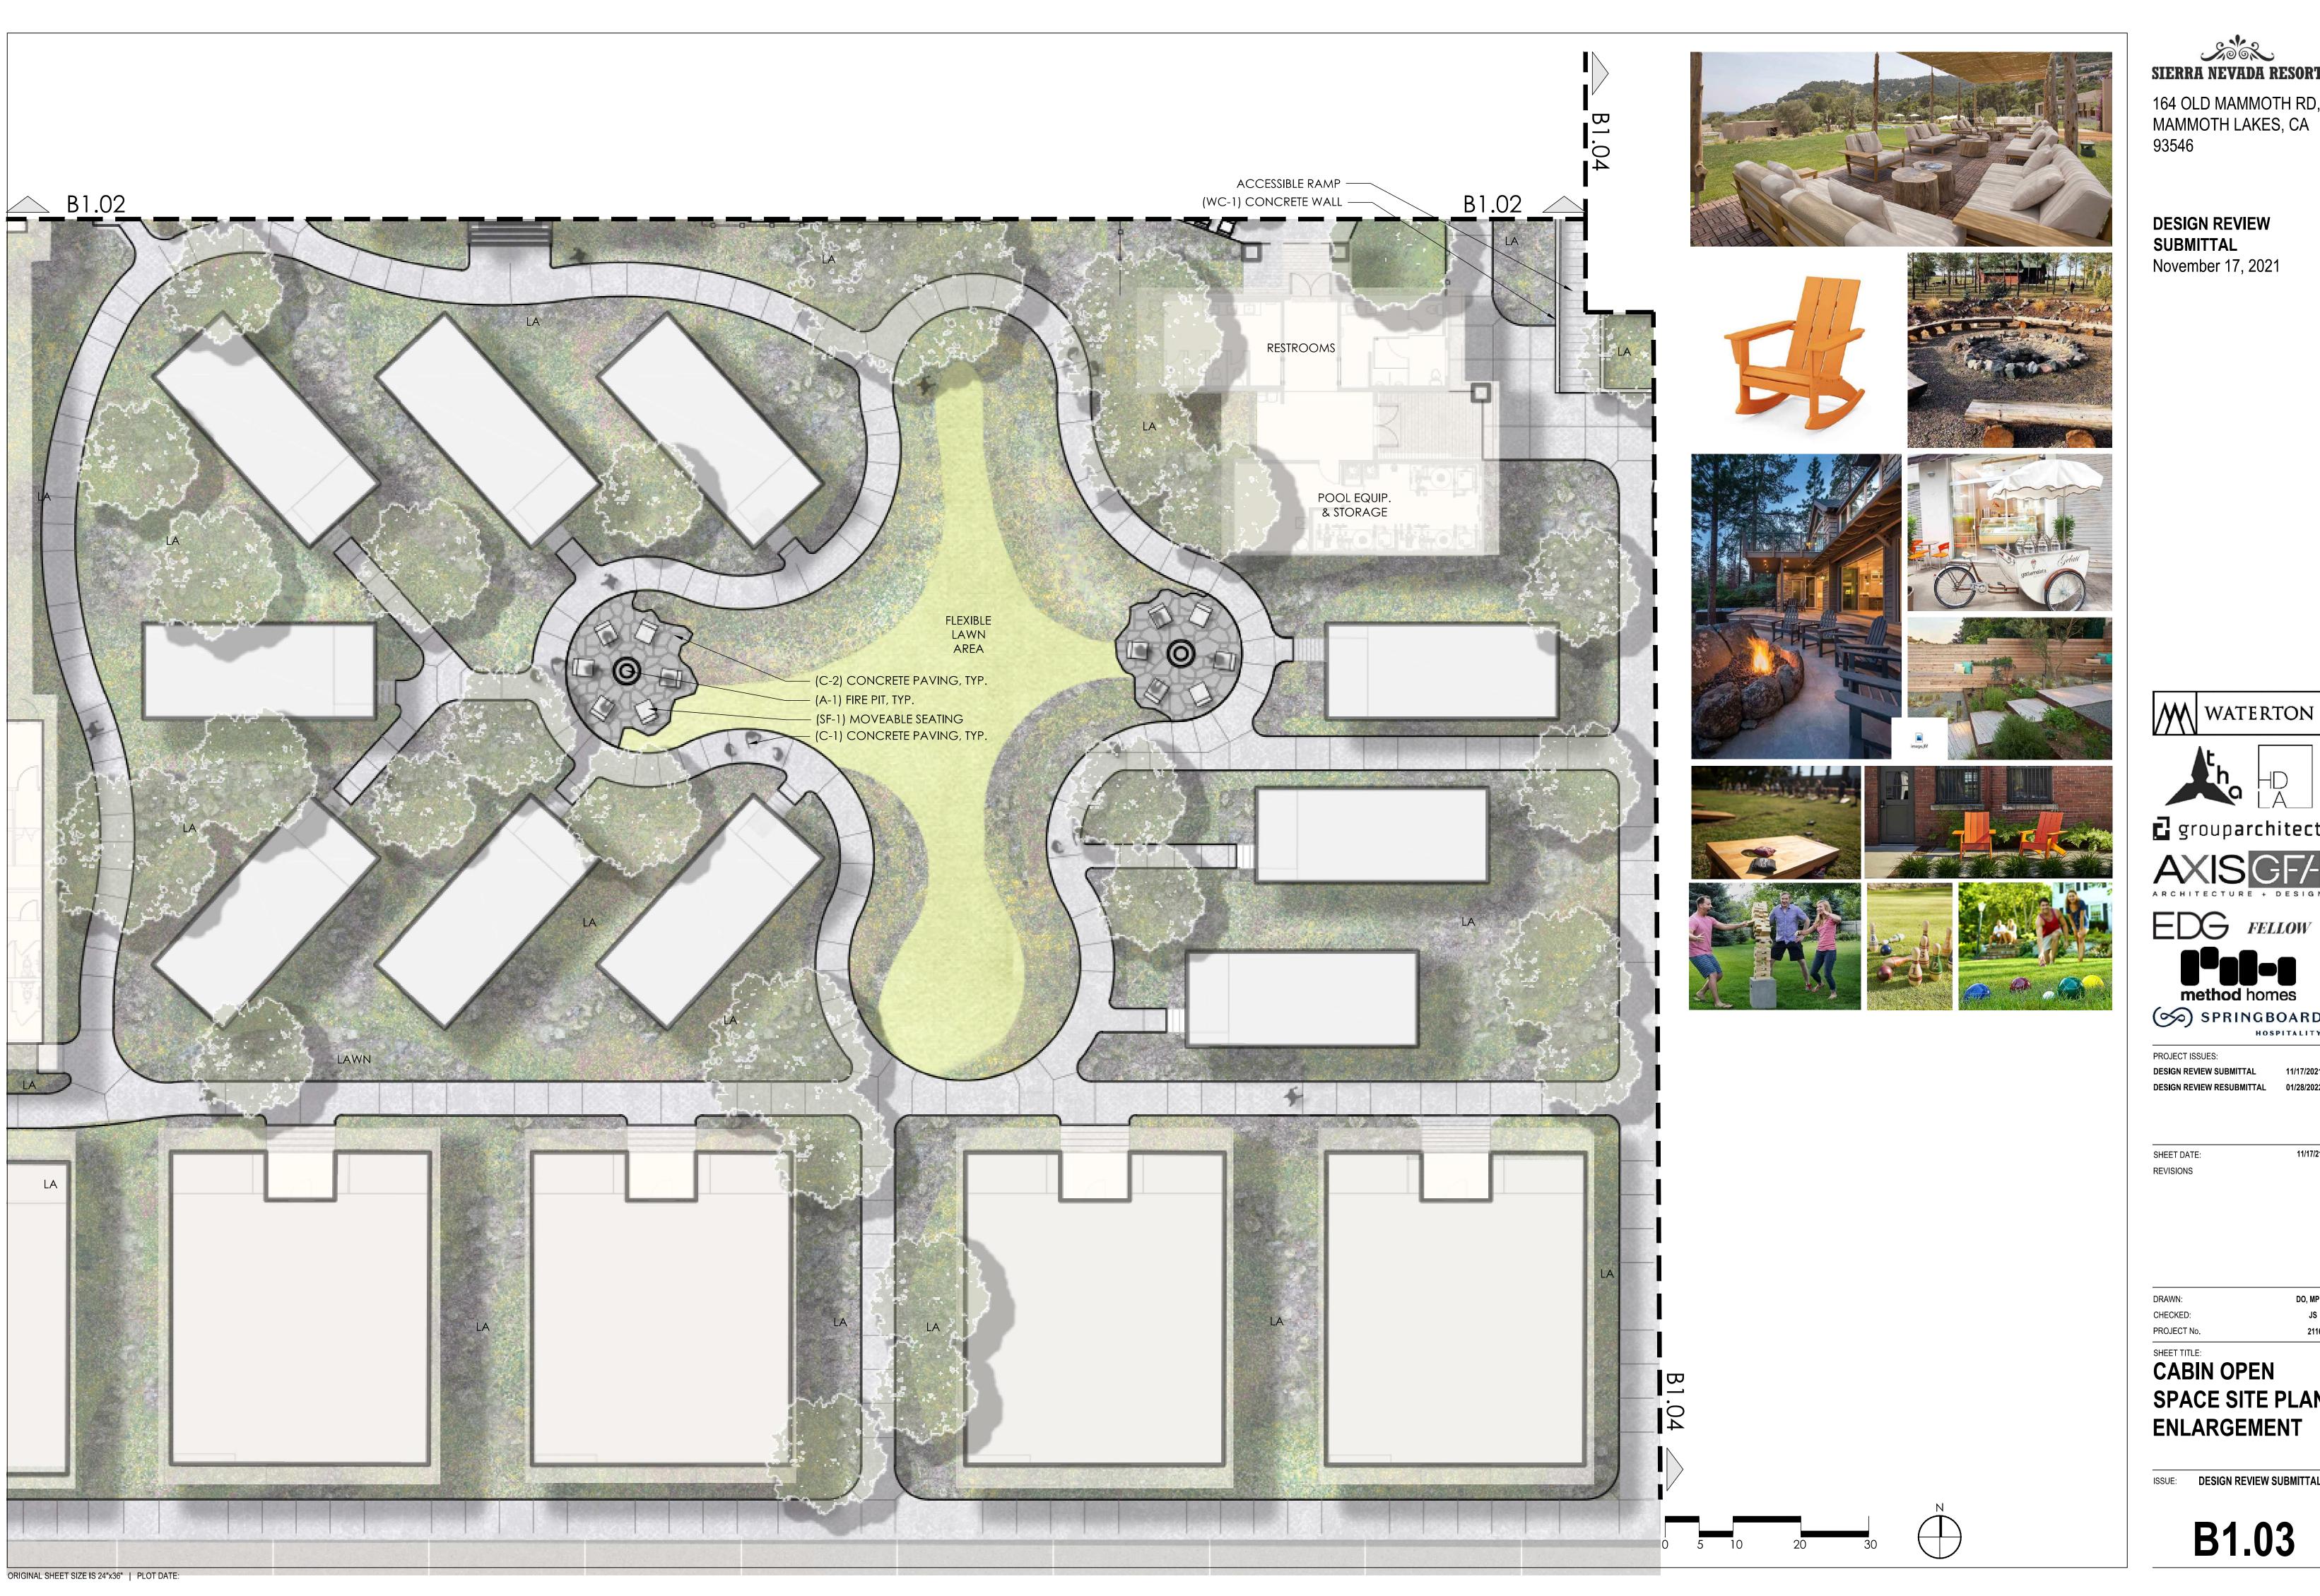

164 OLD MAMMOTH RD, MAMMOTH LAKES, CA 93546

DESIGN REVIEW SUBMITTAL November 17, 2021

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grouparchitect

AXIS GF-

method homes

SPRINGBOARD
HOSPITALITY PROJECT ISSUES:

DESIGN REVIEW SUBMITTAL DESIGN REVIEW RESUBMITTAL 01/28/2022

SHEET DATE: **REVISIONS**

CHECKED: PROJECT No.

CABIN OPEN SPACE SITE PLAN **ENLARGEMENT**

ISSUE: DESIGN REVIEW SUBMITTAL



164 OLD MAMMOTH RD, MAMMOTH LAKES, CA

DESIGN REVIEW SUBMITTAL November 17, 2021




EDG FELLOW

(S) SPRINGBOARD PROJECT ISSUES: DESIGN REVIEW SUBMITTAL

SHEET DATE:

FOOD COURTYARD SITE PLAN **ENLARGEMENT**

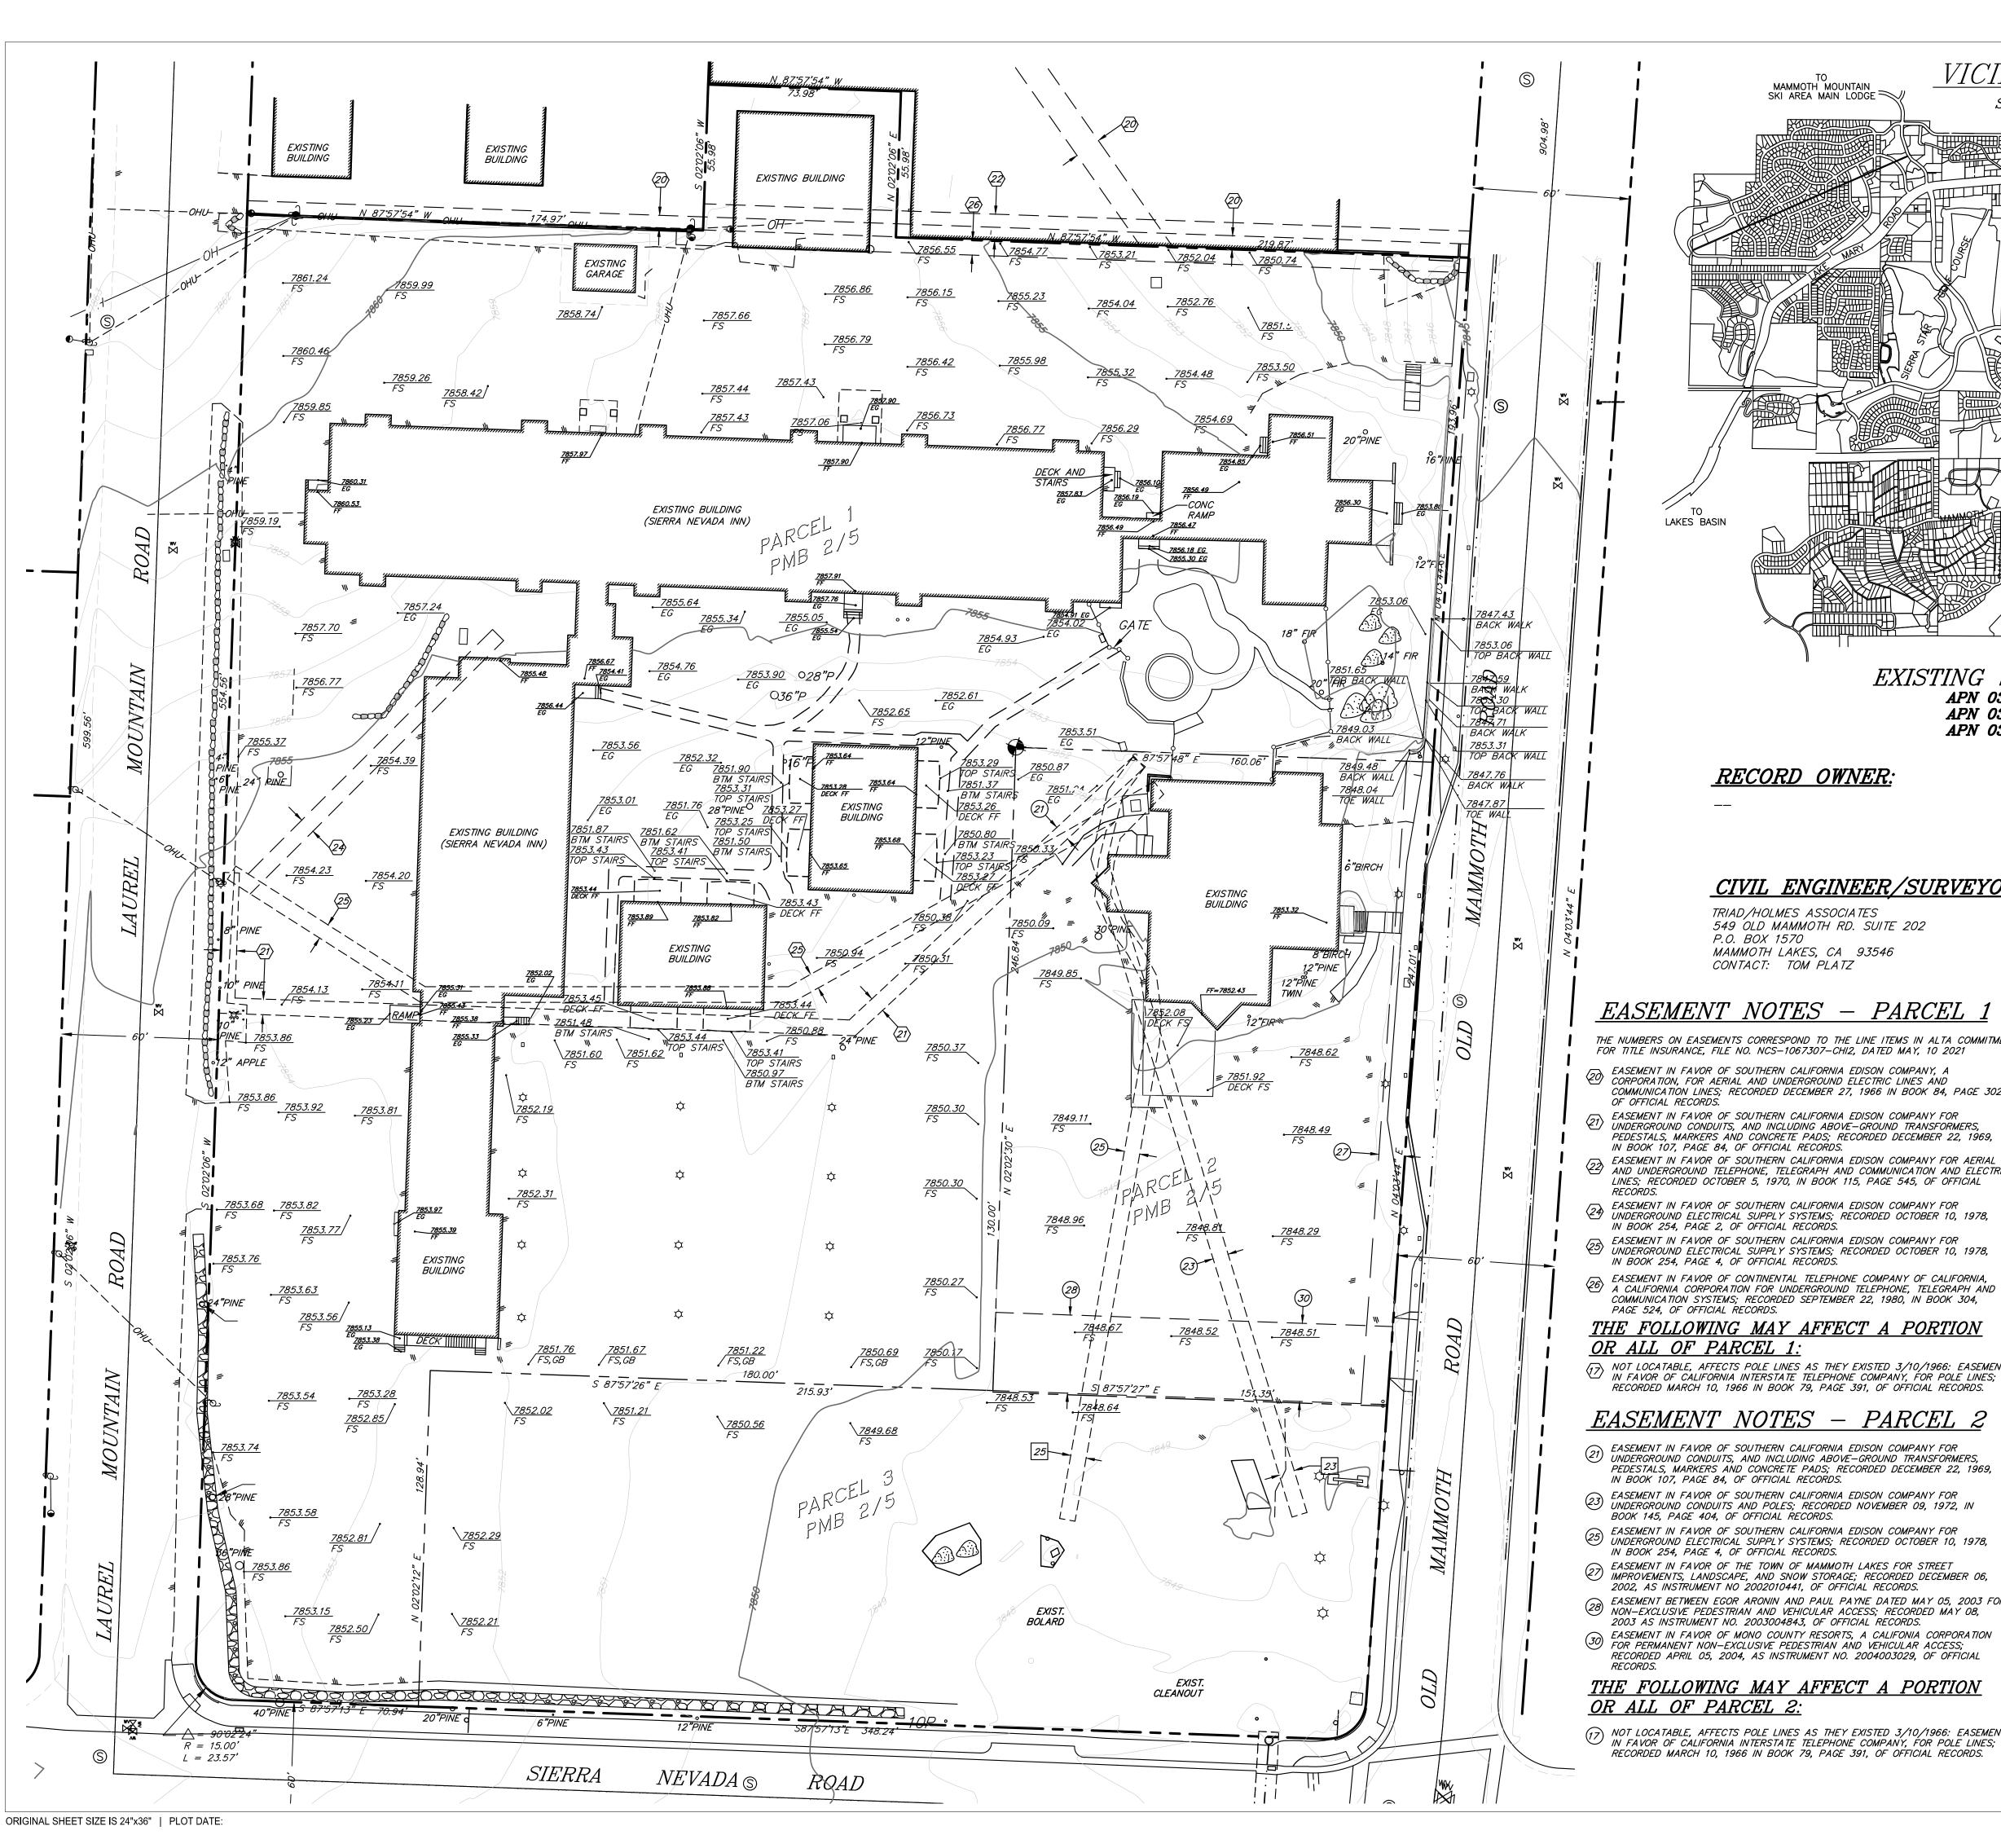

VICINITY MAP — PROJECT LOCATION SCALE: NTS 164 OLD MAMMOTH RD. MAMMOTH LAKES, CA 93546 **DESIGN REVIEW** SUBMITTAL November 1, 2021 EXISTING SITE CONDITIONS

APN 035-230-005-000 APN 035-230-006-000 APN 035-230-007-000

CIVIL ENGINEER/SURVEYOR:

TRIAD/HOLMES ASSOCIATES 549 OLD MAMMOTH RD. SUITE 202 P.O. BOX 1570 MAMMOTH LAKES, CA 93546 CONTACT: TOM PLATZ

EASEMENT NOTES - PARCEL 1

THE NUMBERS ON EASEMENTS CORRESPOND TO THE LINE ITEMS IN ALTA COMMITMENT FOR TITLE INSURANCE, FILE NO. NCS-1067307-CHI2, DATED MAY, 10 2021

- EASEMENT IN FAVOR OF SOUTHERN CALIFORNIA EDISON COMPANY, A CORPORATION, FOR AERIAL AND UNDERGROUND ELECTRIC LINES AND COMMUNICATION TO ELECTRICAL PROCESS: RECORDED DECEMBER 27, 1966 IN BOOK 84, PAGE 302,
- EASEMENT IN FAVOR OF SOUTHERN CALIFORNIA EDISON COMPANY FOR UNDERGROUND CONDUITS, AND INCLUDING ABOVE-GROUND TRANSFORMERS, PEDESTALS, MARKERS AND CONCRETE PADS; RECORDED DECEMBER 22, 1969, IN BOOK 107, PAGE 84, OF OFFICIAL RECORDS.
- EASEMENT IN FAVOR OF SOUTHERN CALIFORNIA EDISON COMPANY FOR AERIAL AND UNDERGROUND TELEPHONE, TELEGRAPH AND COMMUNICATION AND ELECTRIC LINES; RECORDED OCTOBER 5, 1970, IN BOOK 115, PAGE 545, OF OFFICIAL
- EASEMENT IN FAVOR OF SOUTHERN CALIFORNIA EDISON COMPANY FOR UNDERGROUND ELECTRICAL SUPPLY SYSTEMS; RECORDED OCTOBER 10, 1978, IN BOOK 254, PAGE 2, OF OFFICIAL RECORDS.
- UNDERGROUND ELECTRICAL SUPPLY SYSTEMS; RECORDED OCTOBER 10, 1978, IN BOOK 254, PAGE 4, OF OFFICIAL RECORDS.
- COMMUNICATION SYSTEMS; RECORDED SEPTEMBER 22, 1980, IN BOOK 304,

THE FOLLOWING MAY AFFECT A PORTION

NOT LOCATABLE, AFFECTS POLE LINES AS THEY EXISTED 3/10/1966: EASEMENT IN FAVOR OF CALIFORNIA INTERSTATE TELEPHONE COMPANY, FOR POLE LINES; RECORDED MARCH 10, 1966 IN BOOK 79, PAGE 391, OF OFFICIAL RECORDS.

EASEMENT NOTES - PARCEL 2

- 21) EASEMENT IN FAVOR OF SOUTHERN CALIFORNIA EDISON COMPANY FOR UNDERGROUND COMPANY FOR UNDERGROUND CONDUITS, AND INCLUDING ABOVE—GROUND TRANSFORMERS, PEDESTALS, MARKERS AND CONCRETE PADS; RECORDED DECEMBER 22, 1969,
- EASEMENT IN FAVOR OF SOUTHERN CALIFORNIA EDISON COMPANY FOR UNDERGROUND CONDUITS AND POLES; RECORDED NOVEMBER 09, 1972, IN
- EASEMENT IN FAVOR OF SOUTHERN CALIFORNIA EDISON COMPANY FOR UNDERGROUND ELECTRICAL SUPPLY SYSTEMS; RECORDED OCTOBER 10, 1978,
- IMPROVEMENTS, LANDSCAPE, AND SNOW STORAGE; RECORDED DECEMBER 06, 2002, AS INSTRUMENT NO 2002010441, OF OFFICIAL RECORDS.
- 28 EASEMENT BETWEEN EGOR ARONIN AND PAUL PAYNE DATED MAY 05, 2003 FOR NON-EXCLUSIVE PEDESTRIAN AND VEHICULAR ACCESS; RECORDED MAY 08,
- EASEMENT IN FAVOR OF MONO COUNTY RESORTS, A CALIFONIA CORPORATION FOR PERMANENT NON-EXCLUSIVE PEDESTRIAN AND VEHICULAR ACCESS; RECORDED APRIL 05, 2004, AS INSTRUMENT NO. 2004003029, OF OFFICIAL

THE FOLLOWING MAY AFFECT A PORTION

NOT LOCATABLE, AFFECTS POLE LINES AS THEY EXISTED 3/10/1966: EASEMENT IN FAVOR OF CALIFORNIA INTERSTATE TELEPHONE COMPANY, FOR POLE LINES; RECORDED MARCH 10, 1966 IN BOOK 79, PAGE 391, OF OFFICIAL RECORDS.

INDEX TO SHEETS

- C1 COVER SHEET, EXISTING SITE CONDITIONS, VICINITY MAP C2 GRADING PLAN - NORTH
- C3 GRADING PLAN SOUTH C4 DRAINAGE AND UTILITY PLAN C5 EROSION CONTROL PLAN
- C6 SNOW STORAGE PLAN C7 SITE COVERAGE PLAN

EASEMENT NOTES - PARCEL 3

- 23 EASEMENT IN FAVOR OF SOUTHERN CALIFORNIA EDISON COMPANY FOR UNDERGROUND CONDUITS AND POLES; RECORDED NOVEMBER 09, 1972, IN BOOK 145, PAGE 404, OF OFFICIAL RECORDS.
- 25 EASEMENT IN FAVOR OF SOUTHERN CALIFORNIA EDISON COMPANY FOR UNDERGROUND ELECTRICAL SUPPLY SYSTEMS; RECORDED OCTOBER 10, 1978, IN BOOK 254, PAGE 4, OF OFFICIAL RECORDS.

THE FOLLOWING MAY AFFECT A PORTION OR ALL OF PARCEL 3:

- NOT LOCATABLE, AFFECTS POLE LINES AS THEY EXISTED 3/10/1966: EASEMENT IN FAVOR OF CALIFORNIA INTERSTATE TELEPHONE COMPANY FOR POLE LINES; RECORDED MARCH 10, 1966, IN BOOK 79, PAGE 391, OF OFFICIAL RECORDS.
- NOT LOCATABLE DUE TO NO BASIS OF BEARINGS. LOCATION IS NEAR EAST BOUNDARY AND IS A 20' WIDE STRIP RUNNING SOUTH TO NORTH: EASEMENT IN FAVOR OF SOUTHERN CALIFORNIA EDISON COMPANY FOR POLE LINES; RECORDED MARCH 11, 1966, IN BOOK 79, PAGE 417, OF OFFICIAL RECORDS. AS DESCRIBED
- NOT LOCATABLE: EASEMENT IN FAVOR OF UNITED STATES OF AMERICA FOR WATER TRANSMISSION PIPELINE; RECORDED APRIL 20, 1966, IN BOOK 80, PAGE 219, OF OFFICIAL RECORDS.
- EASEMENT IN FAVOR OF SOUTHERN CALIFORNIA EDISON COMPANY FOR UNDERGROUND CONDUITS, AND INCLUDING ABOVE—GROUND TRANSFORMERS, PEDESTALS, MARKERS AND CONCRETE PADS; RECORDED DECEMBER 22, 1969, IN BOOK 107, PAGE 84, OF OFFICIAL RECORDS. AS DESCRIBED HEREIN. DOES NOT AFFECT PROPERTY.
- EASEMENT IN FAVOR OF SOUTHERN CALIFORNIA EDISON COMPANY FOR UNDERGROUND ELECTRICAL SUPPLY SYSTEMS; RECORDED OCTOBER 10, 1978, IN BOOK 254, PAGE 2, OF OFFICIAL RECORDS. AS DESCRIBED HEREIN. DOES

TOPOGRAPHIC SURVEY PREPARED UNDER THE DIRECTION OF:

> THOMAS A. PLATZ P.E. C 41039


PROJECT ISSUES: DESIGN REVIEW SUBMITTAL 11/01/2021

SHEET DATE: REVISIONS

DRAWN: CHECKED: PROJECT No. 1.2740.3

SHEET TITLE: **COVER SHEET**

DESIGN REVEIW SUBMITTAL

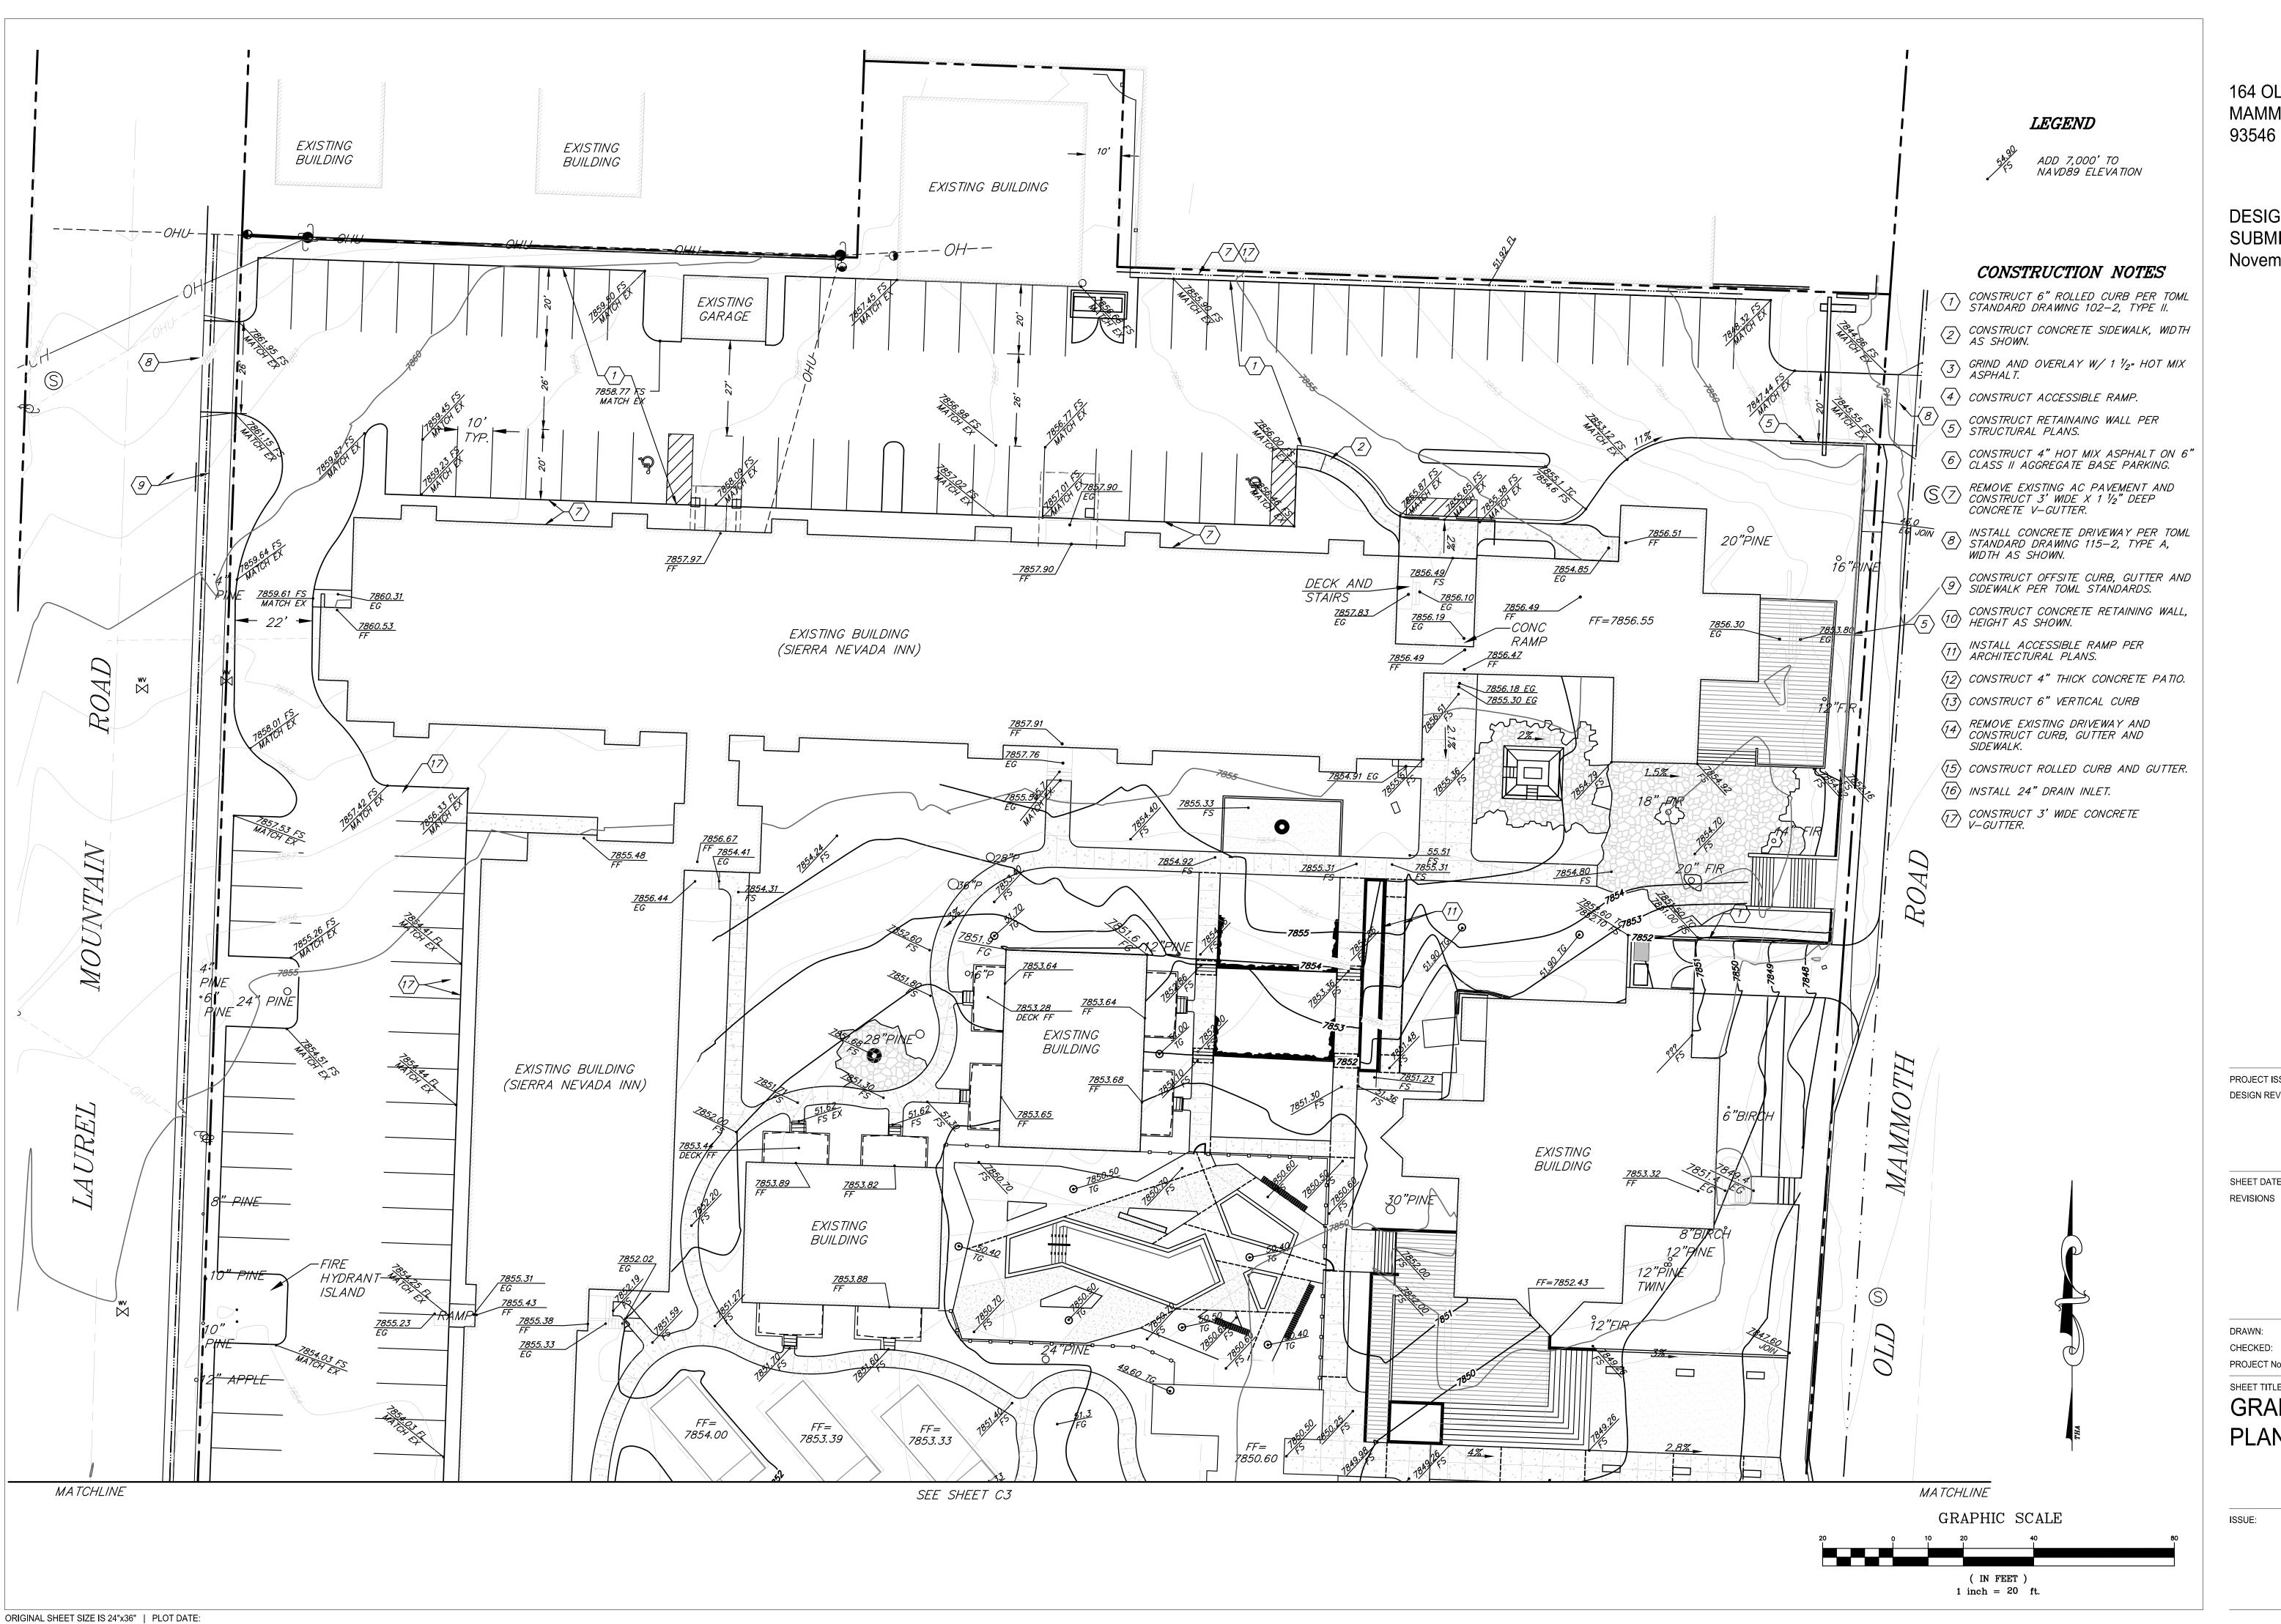

DESIGN REVIEW SUBMITTAL November 1, 2021

PROJECT ISSUES: DESIGN REVIEW SUBMITTAL 11/01/2021

SHEET DATE:


DRAWN: CHECKED: PROJECT No.

SHEET TITLE:

1.2740.3

GRADING PLAN - NORTH

ISSUE: DESIGN REVEIW SUBMITTAL

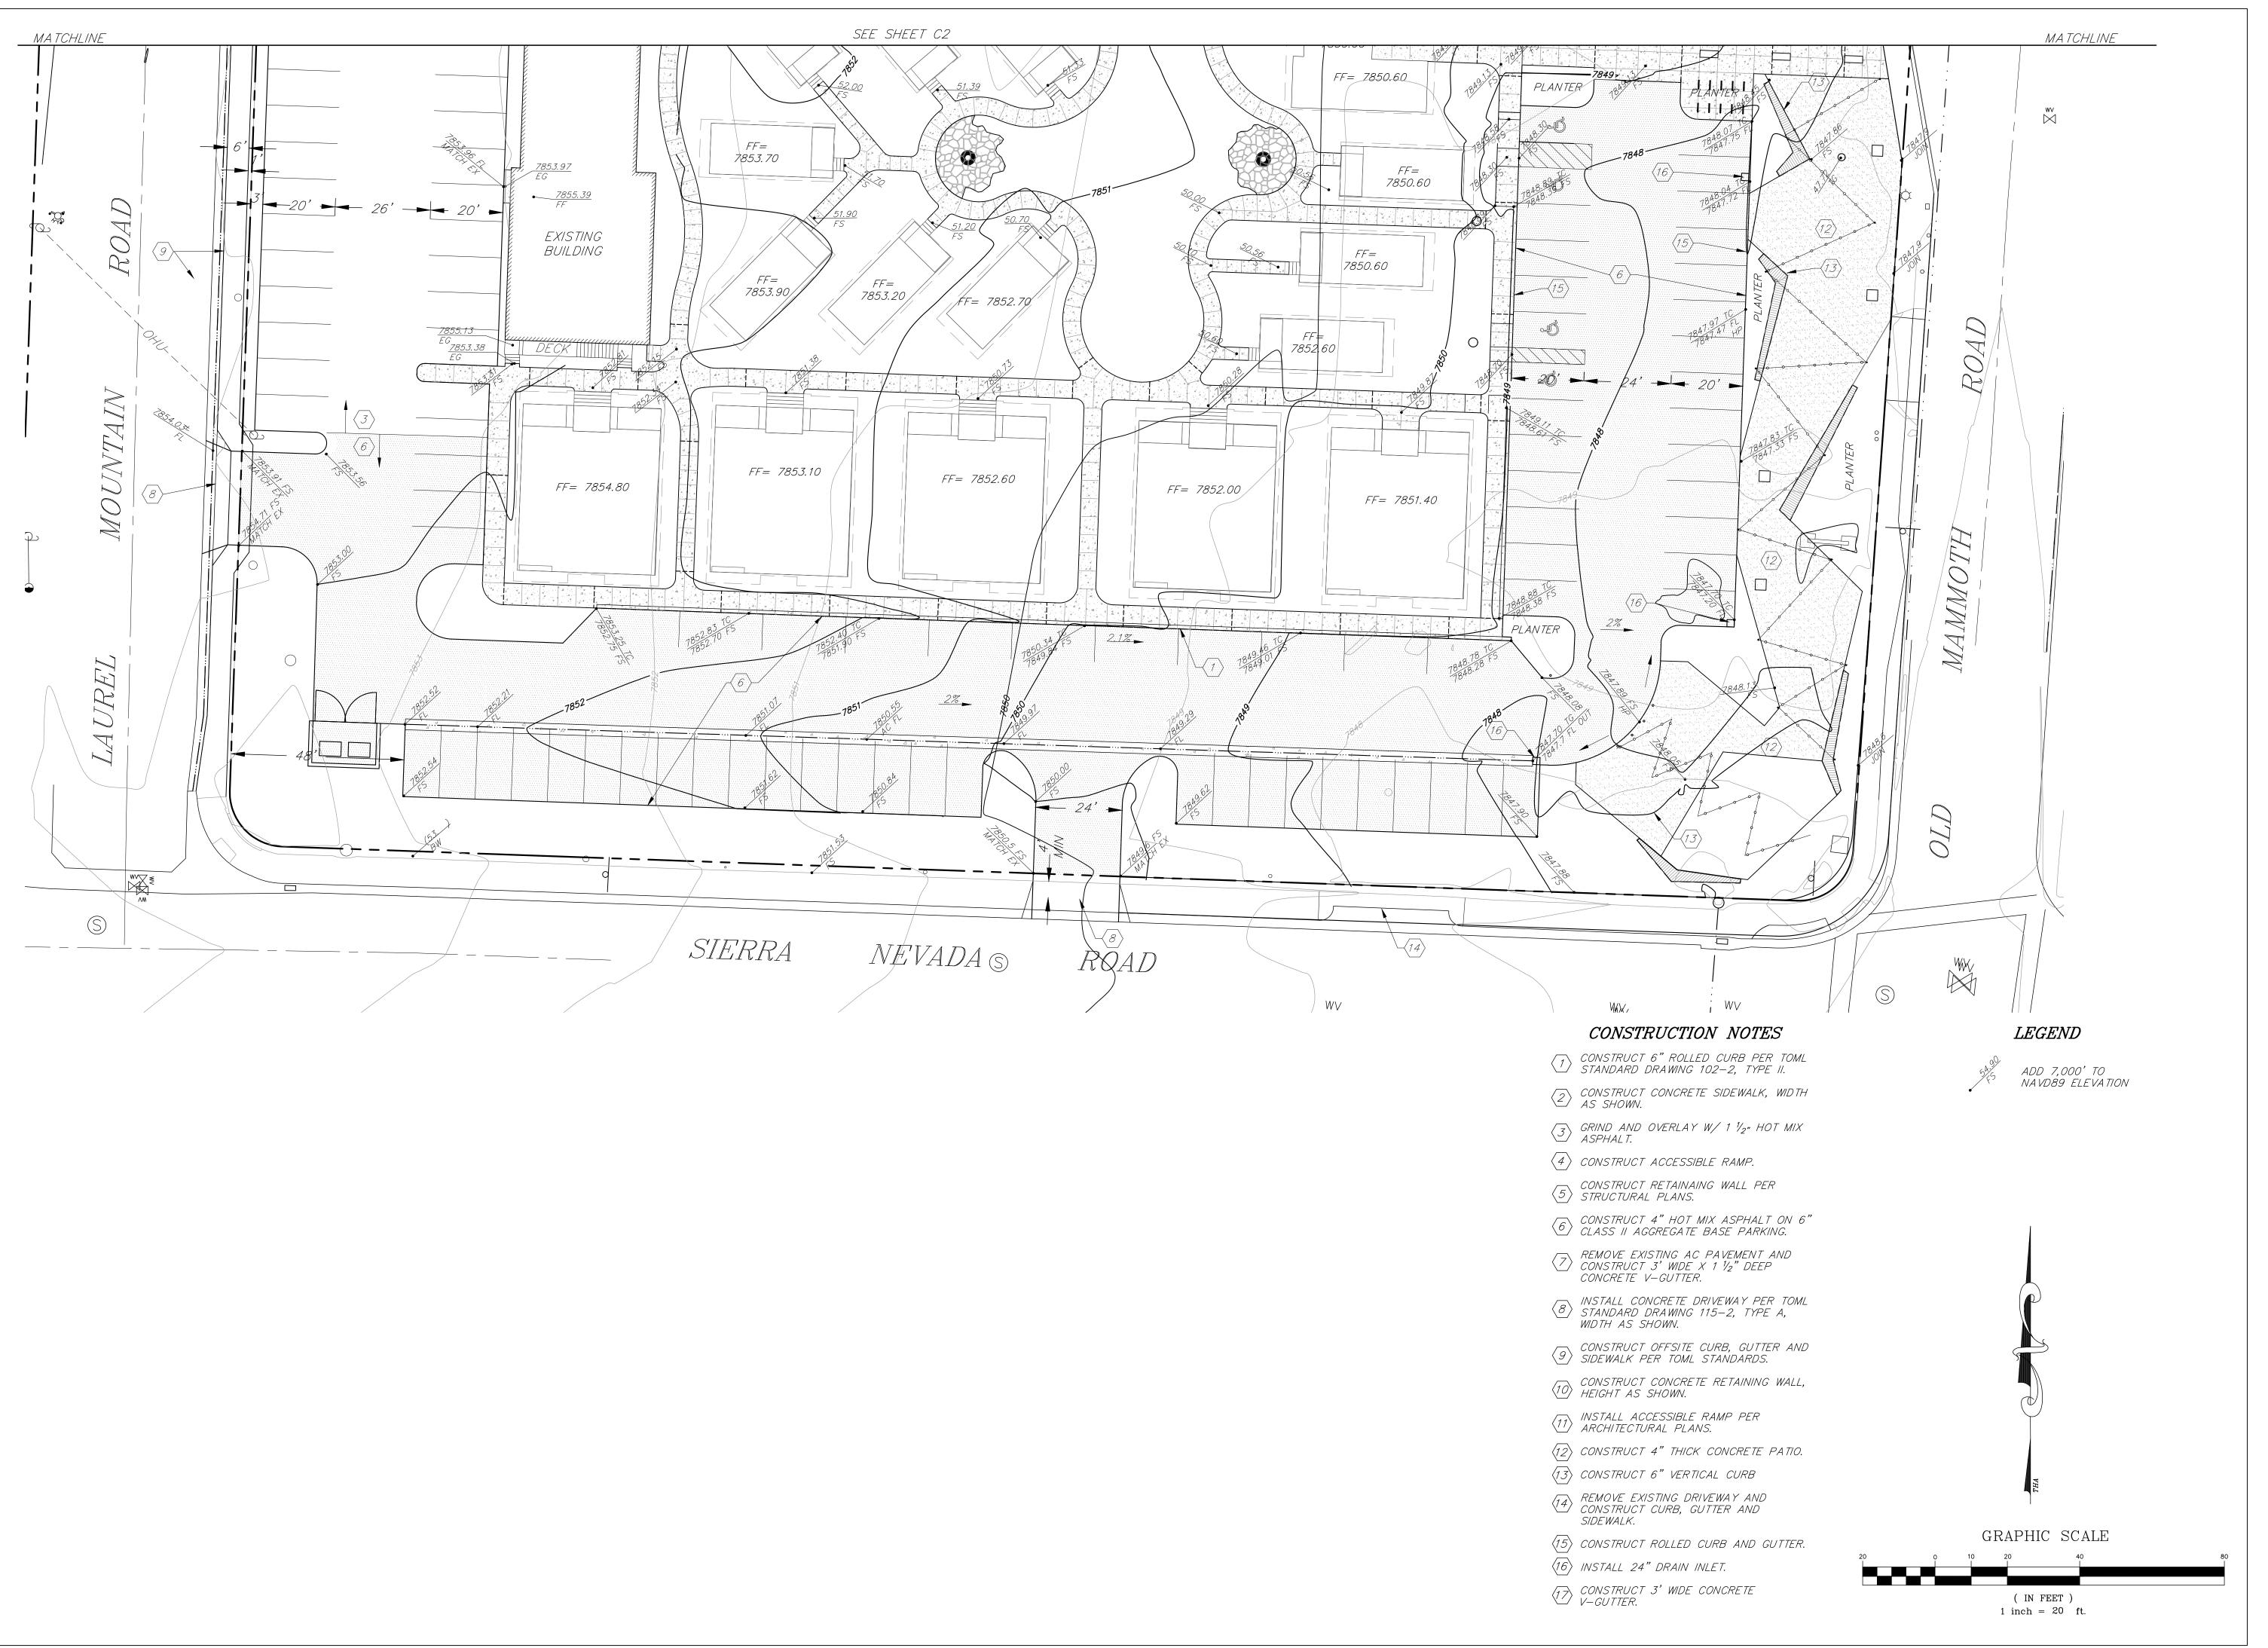

ORIGINAL SHEET SIZE IS 24"x36" | PLOT DATE:

164 OLD MAMMOTH RD, MAMMOTH LAKES, CA 93546

DESIGN REVIEW SUBMITTAL November 1, 2021

PROJECT ISSUES:
DESIGN REVIEW SUBMITTAL 11/01/2021

SHEET DATE:
REVISIONS

DRAWN: CHECKED:


CHECKED:
PROJECT No.

GRADING
PLAN - SOUTH

1.2740.3

ISSUE: DESIGN REVEIW SUBMITTAL

C3

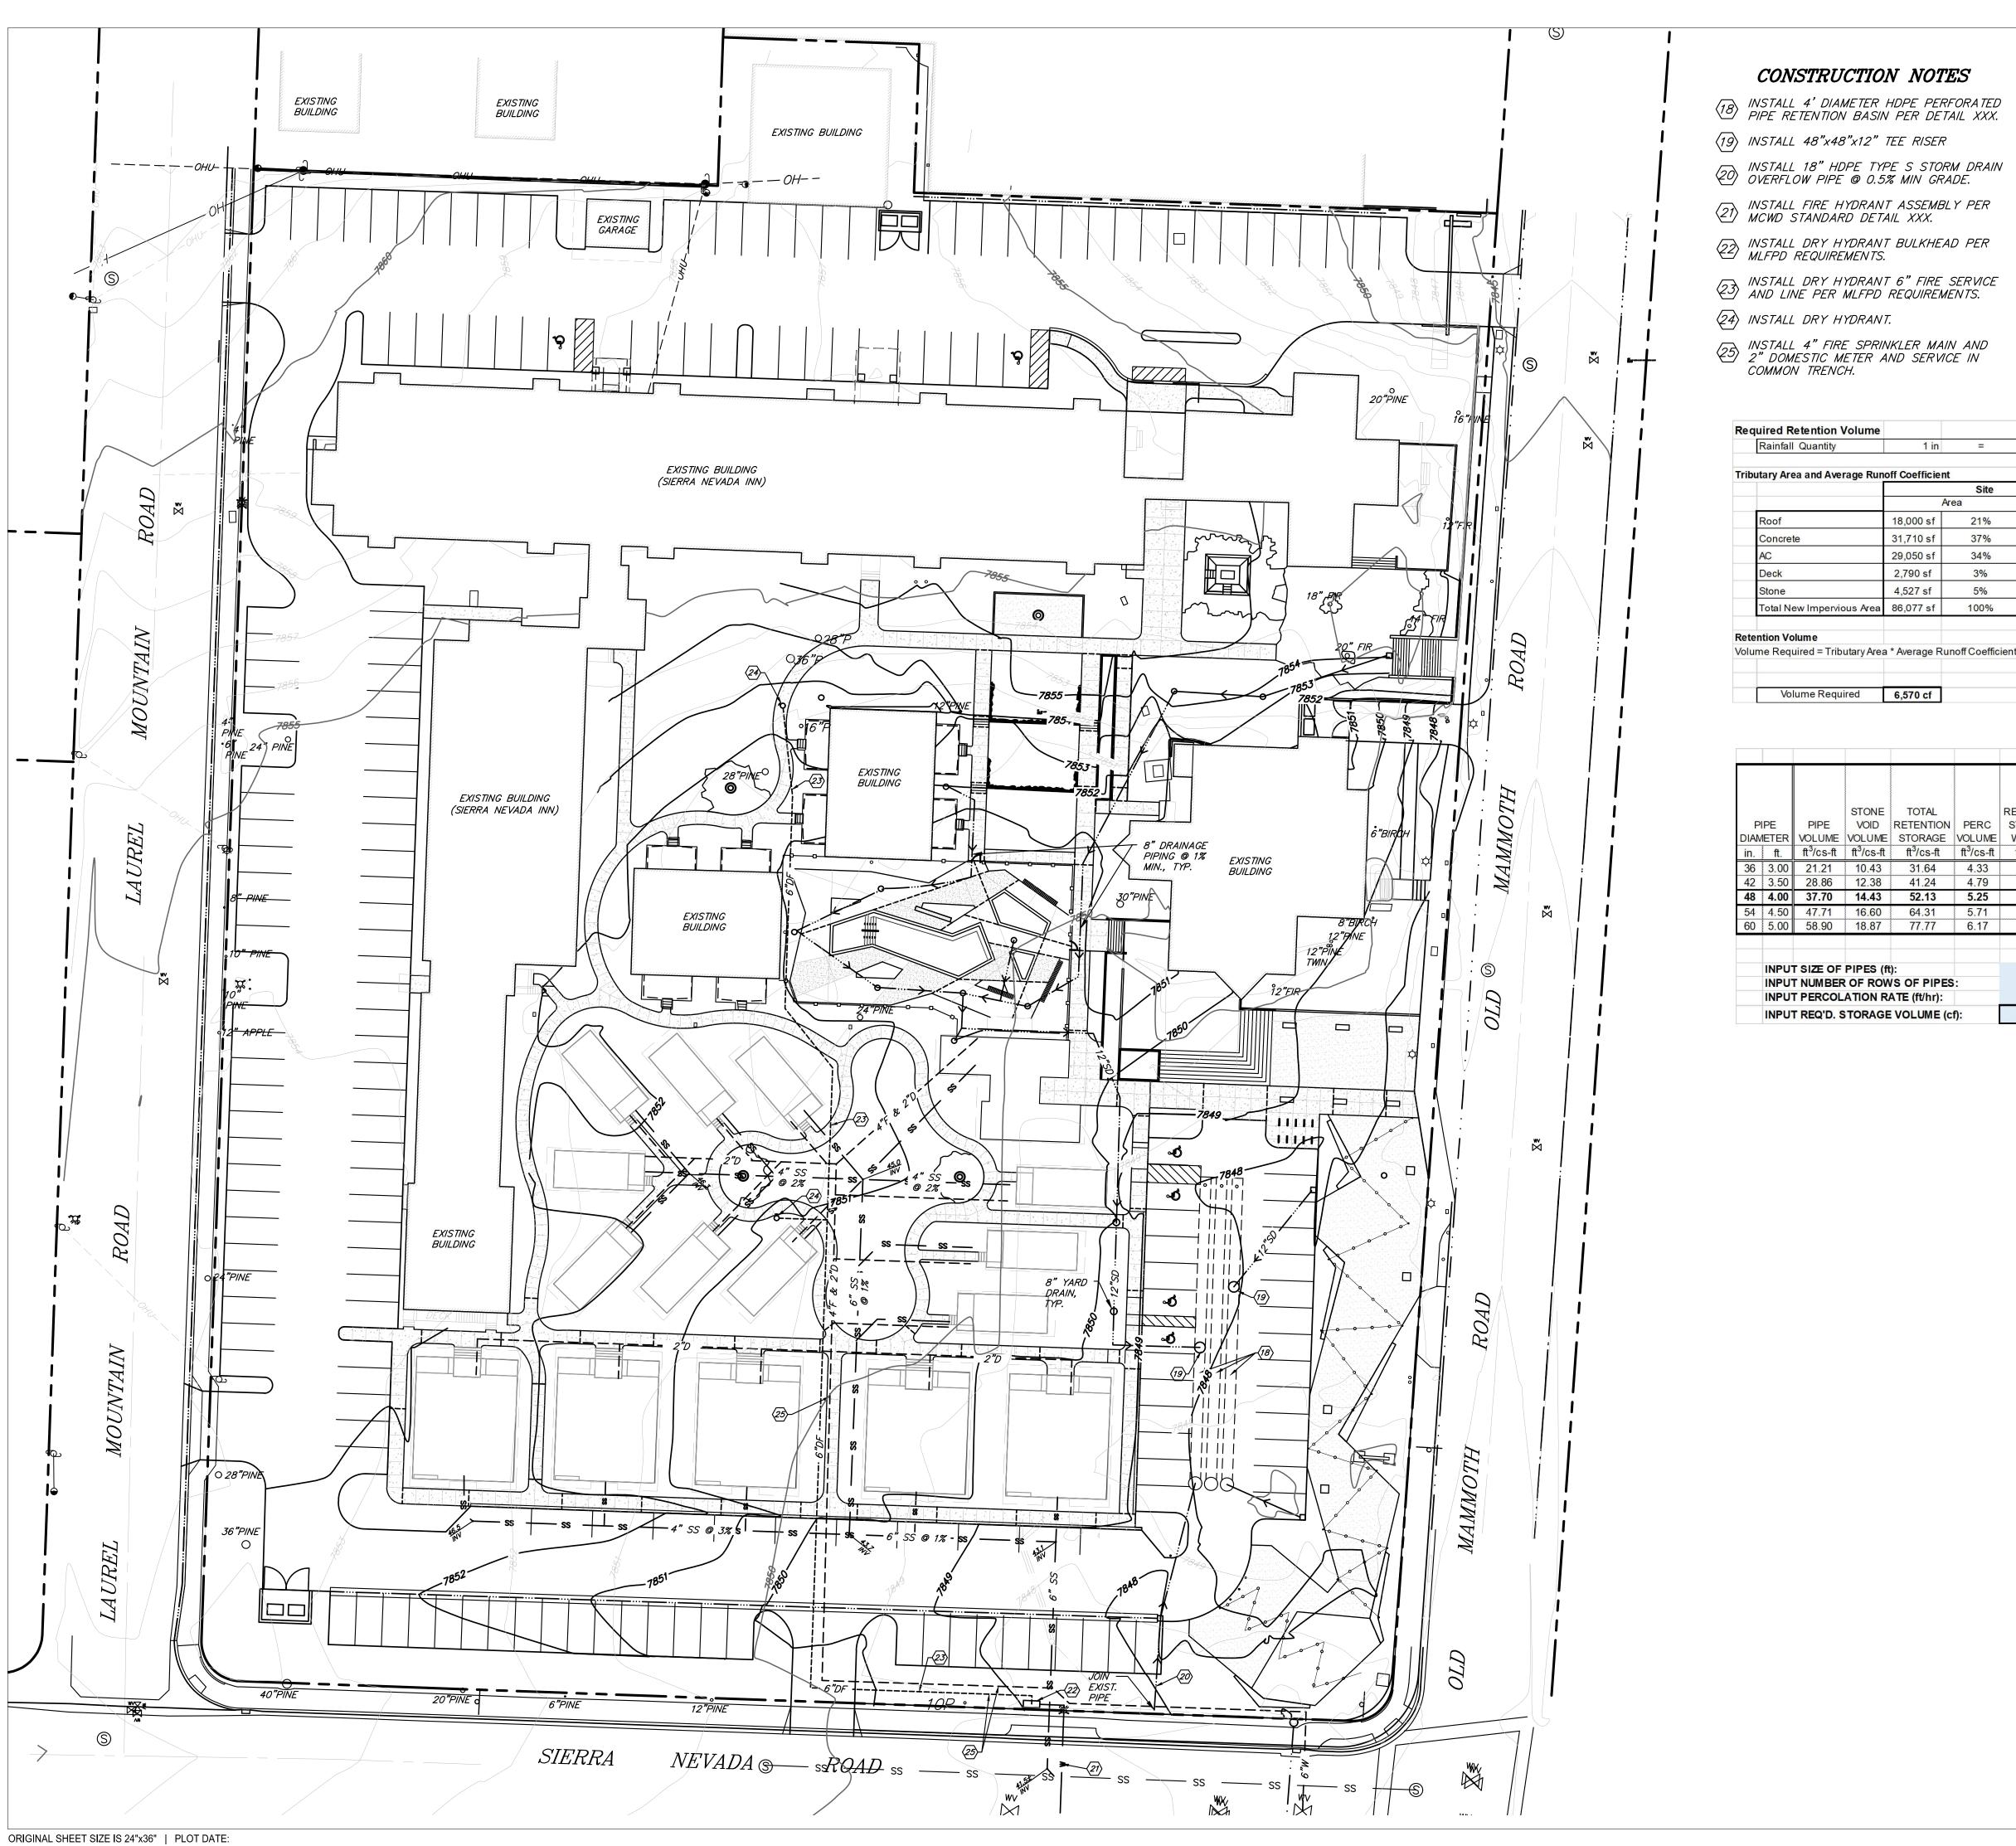

Rainfall	Quantity	1 in	=	0.083 f
Italillali	Quantity	1 111		0.0031
Tributary Are	a and Average Run	off Coefficient	t	
			Site	
		A	rea	С
Roof		18,000 sf	21%	0.95
Concret	е	31,710 sf	37%	0.95
AC		29,050 sf	34%	0.90
Deck		2,790 sf	3%	0.50
Stone		4,527 sf	5%	0.90
Total Ne	w Impervious Area	86,077 sf	100%	0.92
Retention Vo olume Requ	lume ired = Tributary Area	a * Average Ru	noff Coefficient	* Rainfall
	ume Required	6,570 cf		

21.21 28.86 37.70 47.71 58.90 T SIZE OF	10.43 12.38 14.43 16.60 18.87	31.64 41.24 52.13 64.31 77.77	4.33 4.79 5.25 5.71 6.17	35.97 46.03 57.38 70.02 83.94 4.00 3 0.25	183 143 114 94 78	189 149 121 101 86	15.00 16.50 18.00 19.50 21.00	3.50 4.00 4.50 5.00 5.50	548 428 343 281 235
21.21 28.86 37.70 47.71 58.90	10.43 12.38 14.43 16.60 18.87	41.24 52.13 64.31 77.77	4.79 5.25 5.71 6.17	46.03 57.38 70.02 83.94	143 114 94	149 121 101	16.50 18.00 19.50	4.00 4.50 5.00	428 343 281
21.21 28.86 37.70 47.71 58.90	10.43 12.38 14.43 16.60 18.87	41.24 52.13 64.31 77.77	4.79 5.25 5.71	46.03 57.38 70.02 83.94	143 114 94	149 121 101	16.50 18.00 19.50	4.00 4.50 5.00	428 343 281
21.21 28.86 37.70 47.71	10.43 12.38 14.43 16.60	41.24 52.13 64.31	4.79 5.25 5.71	46.03 57.38 70.02	143 114 94	149 121 101	16.50 18.00 19.50	4.00 4.50 5.00	428 343 281
21.21 28.86 37.70 47.71	10.43 12.38 14.43 16.60	41.24 52.13 64.31	4.79 5.25 5.71	46.03 57.38 70.02	143 114 94	149 121 101	16.50 18.00 19.50	4.00 4.50 5.00	428 343 281
21.21 28.86 37.70 47.71	10.43 12.38 14.43	41.24 52.13 64.31	4.79 5.25	46.03 57.38	143 114 94	149 121	16.50 18.00	4.00 4.50	428 343 281
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					}				LINEAF
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MAMMOTH LAKES, CA

DESIGN REVIEW

November 1, 2021

SUBMITTAL

93546

SHEET DATE: REVISIONS


GRAPHIC SCALE

(IN FEET) 1 inch = 30 ft.

DRAWN: CHECKED: PROJECT No. 1.2740.3

SHEET TITLE: DRAINAGE & UTILITY PLAN

ISSUE: DESIGN REVEIW SUBMITTAL

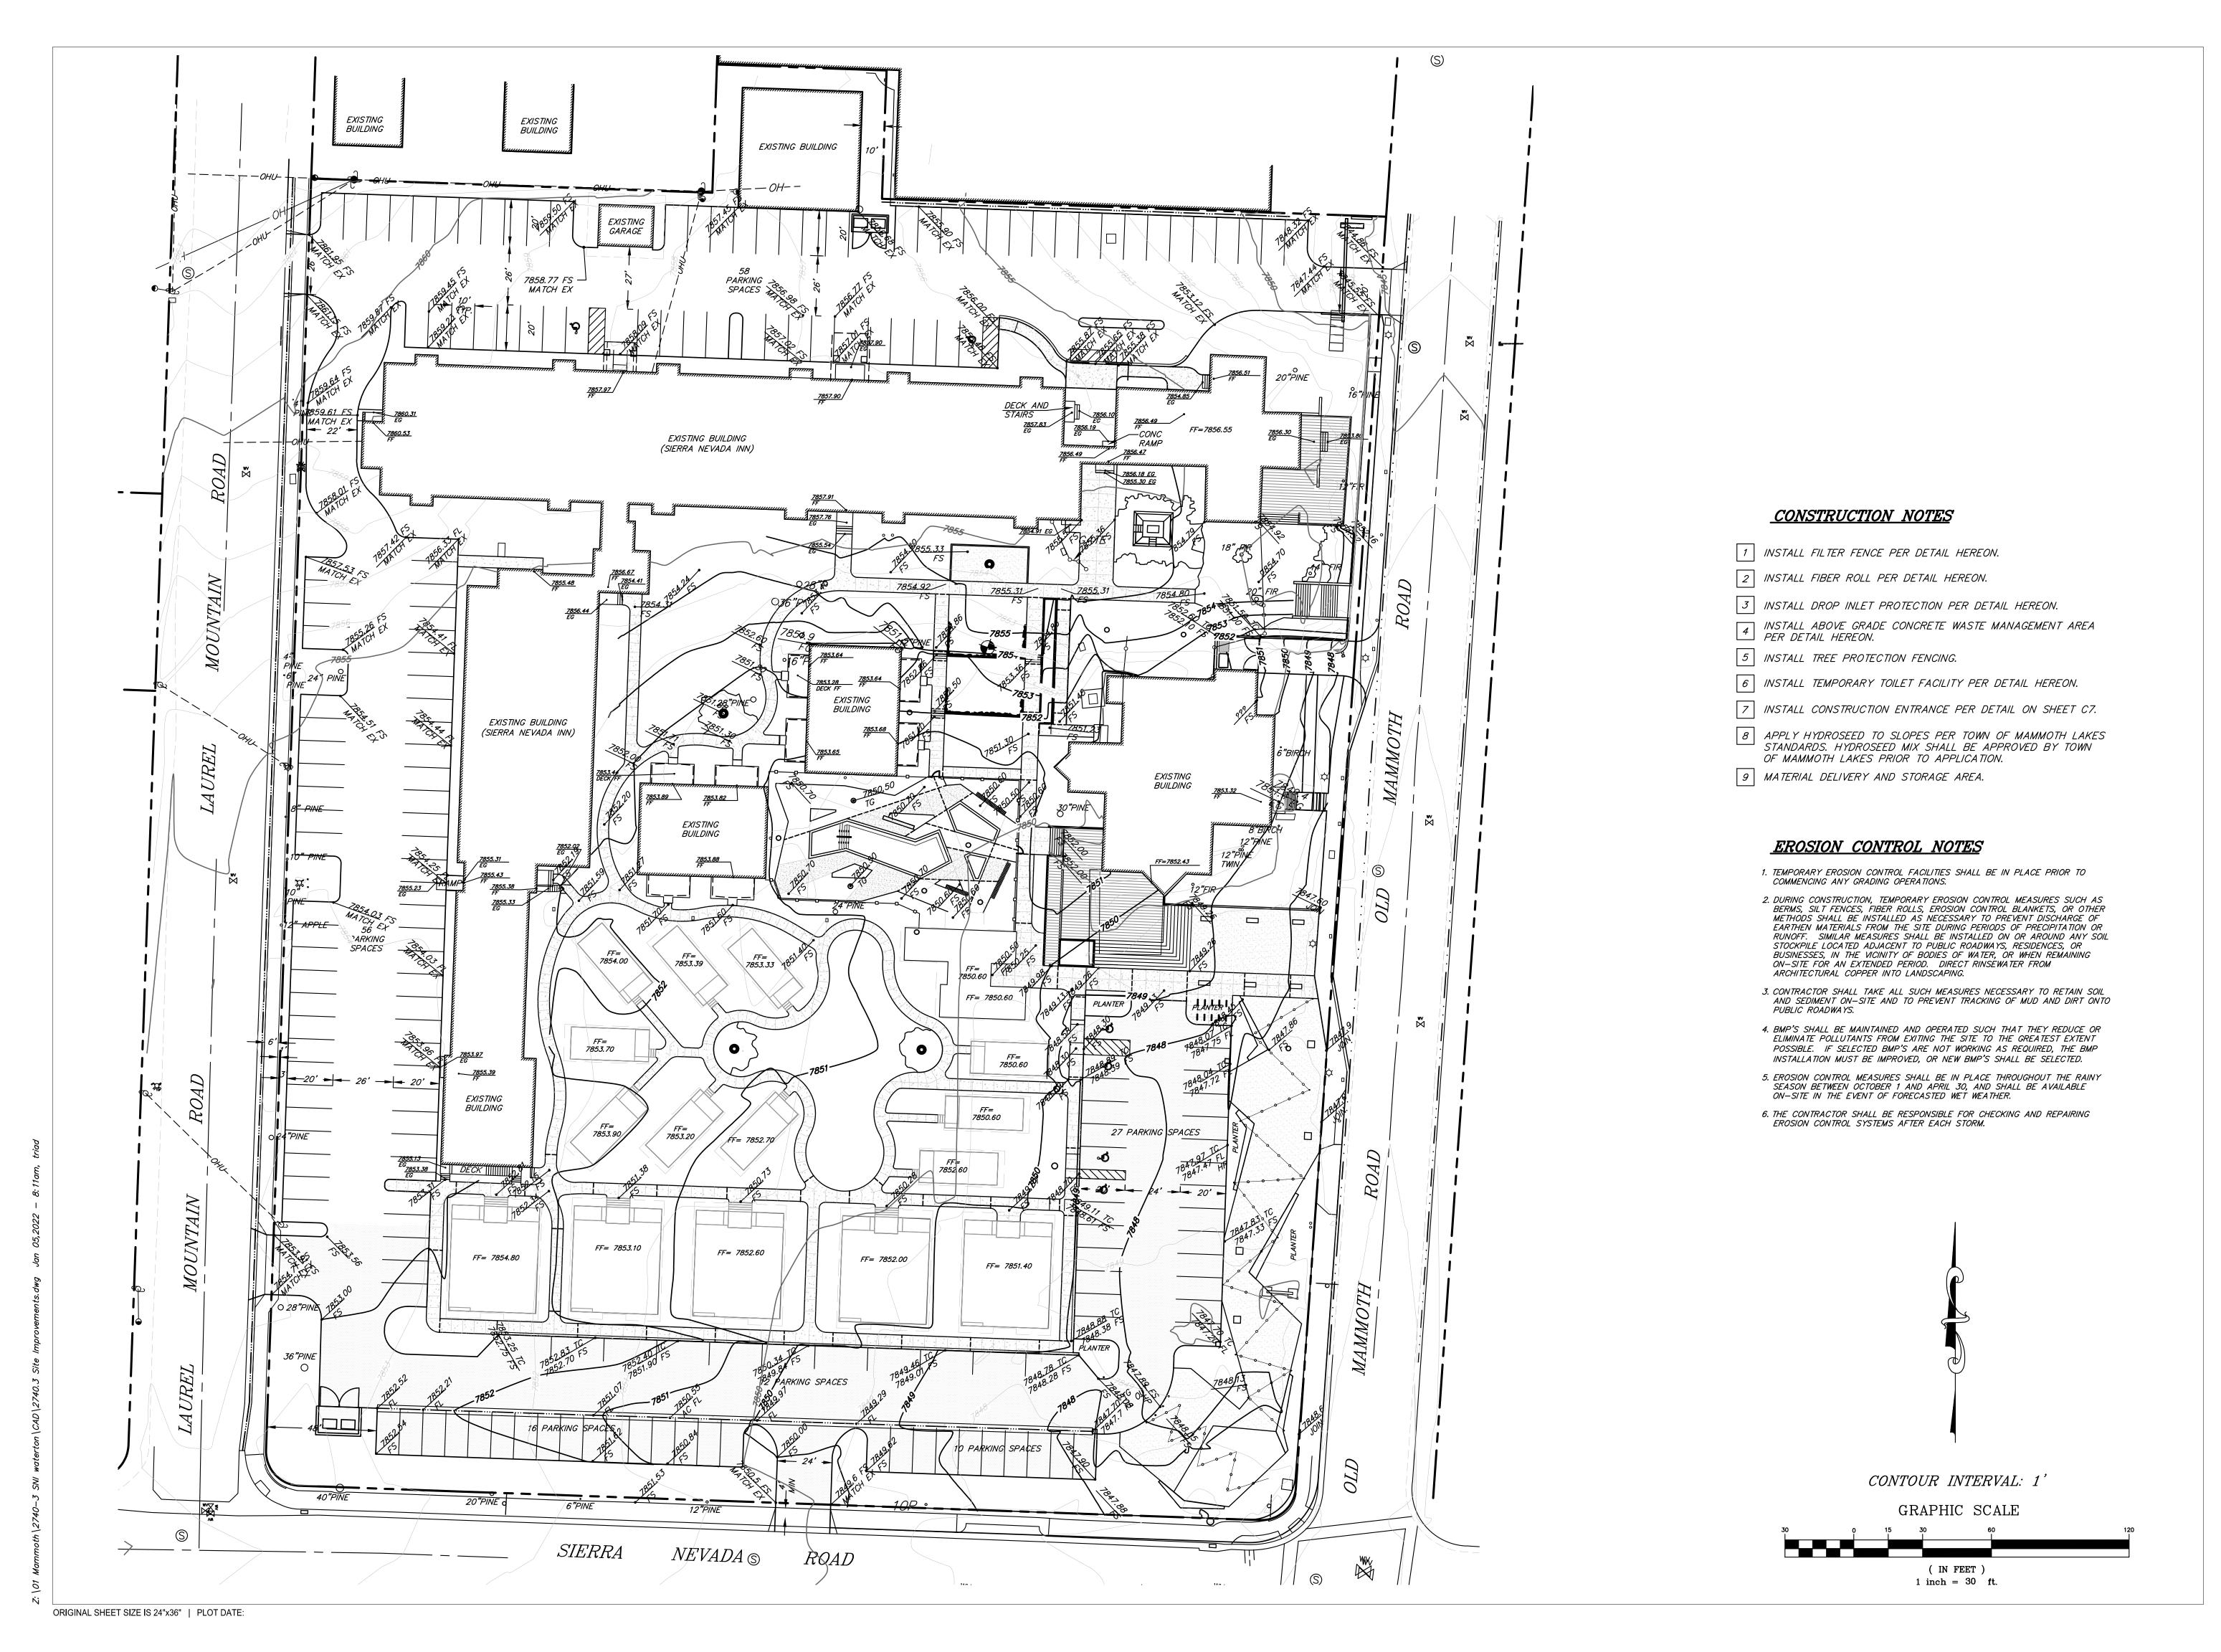

DESIGN REVIEW SUBMITTAL November 1, 2021

PROJECT ISSUES:

DESIGN REVIEW SUBMITTAL 11/01/2021

SHEET DATE:

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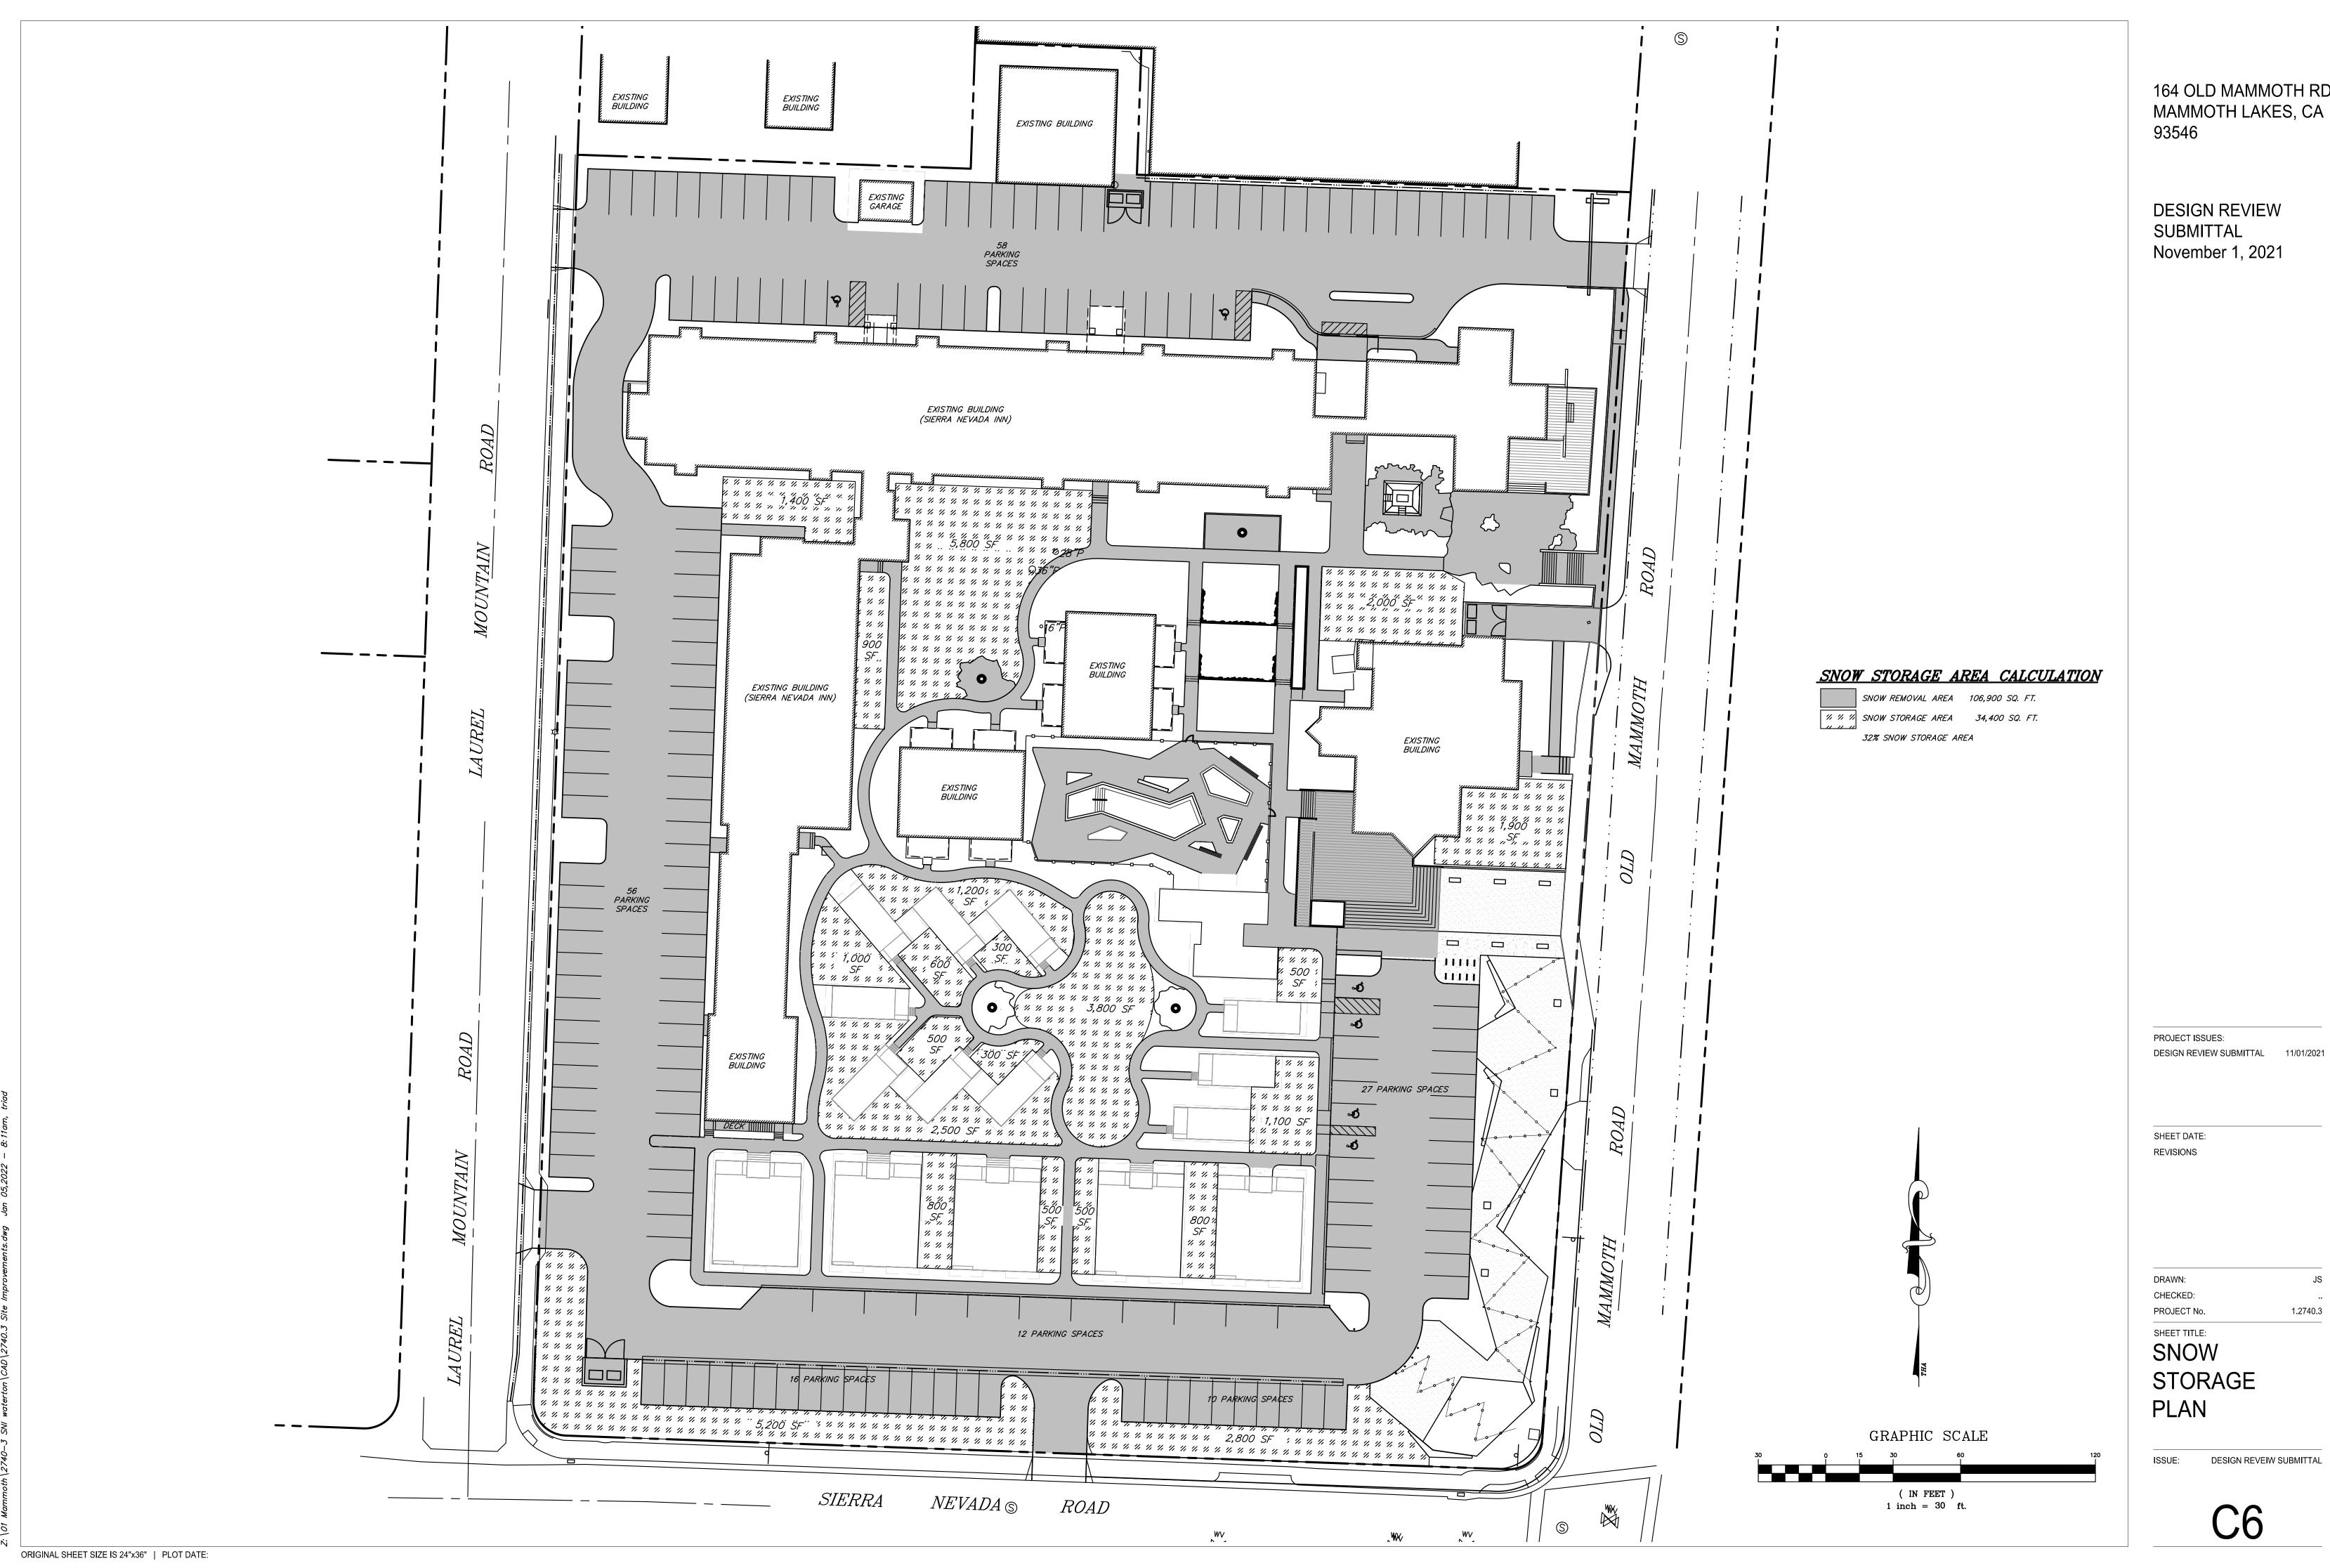
PROJECT No. 1.2740.3

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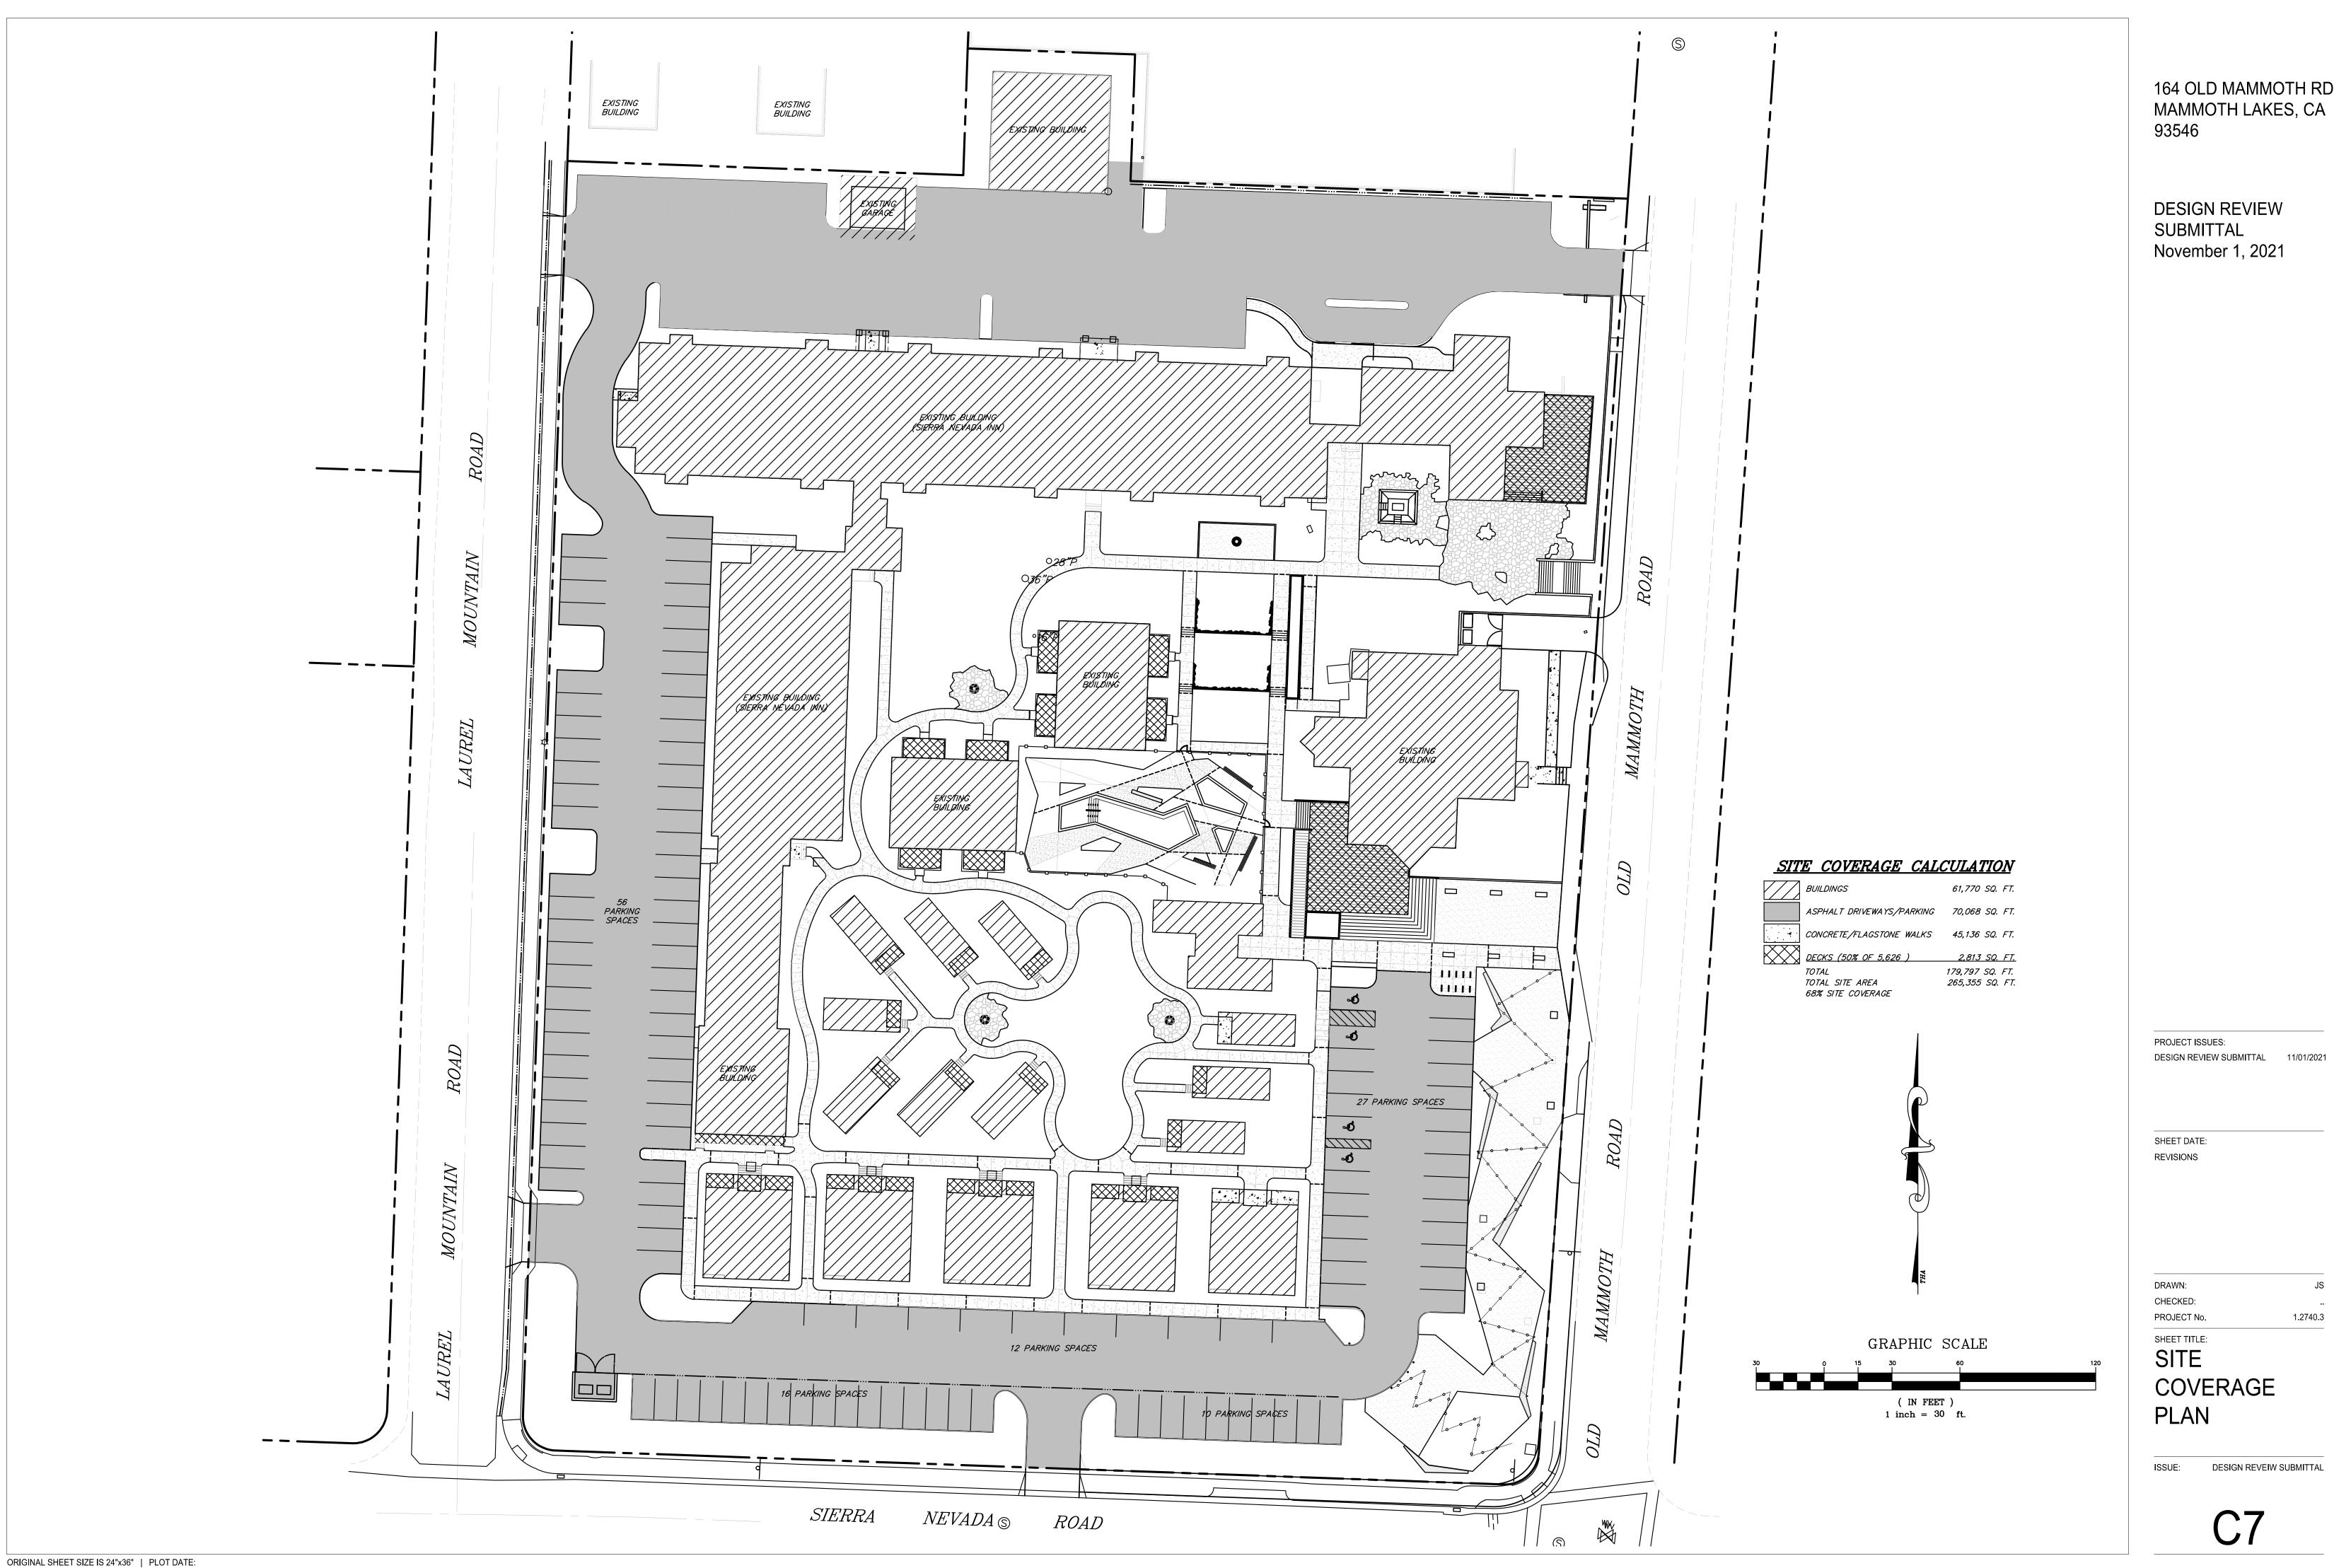
EROSION
CONTROL
PLAN

ISSUE: DESIGN REVEIW SUBMITTAL

C5



ISSUE: DESIGN REVEIW SUBMITTAL



November 1, 2021

1.2740.3

COVERAGE

ISSUE: DESIGN REVEIW SUBMITTAL

OUT NOTES MATERIAL NOTES CONT.

+ X.XX PROPOSED SPOT GRADE + TW TOP OF WALL + BW BOTTOM OF WALL + TS TOP OF STEP + BS BOTTOM OF STEP 1. THIS PLAN IS FOR THE PURPOSE OF HORIZONTAL CONTROL (STAKING) OF CONSTRUCTION FEATURES NOT LOCATED BY THE CIVIL ENGINEERING AND ARCHITECTURAL DRAWINGS; AND FOR THE CONSTRUCTION REFERENCE OF SITE FEATURES. 2. EXISTING DRAWINGS & SITE VISITATION: IT IS THE RESPONSIBILITY OF THE CONTRA TO VISIT THE SITE, EXAMINE THE EXISTING CONDITIONS OF THE NEW CONSTRUCTION.

- 2. EXISTING DRAWINGS & SITE VISITATION: IT IS THE RESPONSIBILITY OF THE CONTRACTOR TO VISIT THE SITE, EXAMINE THE EXISTING CONDITIONS OF THE NEW CONSTRUCTION & DETERMINE TO THEIR SATISFACTION THE METHODS & PROCEDURE, REMOVAL & STORAGE OF MATERIALS, SEQUENCING OF OPERATIONS AND CONDITIONS WHICH AFFECT ITS WORK & PROBLEMS ATTENDANT HERETO.
- 3. THE CONTRACTOR BARES ALL RESPONSIBILITY FOR VERIFYING ALL UNDERGROUND UTILITIES, PIPES, STRUCTURES, WALKS AND CURBS IN THE FIELD PRIOR TO CONSTRUCTION. ANY DAMAGE TO BEFORE MENTIONED INFRASTRUCTURE THAT ARE TO REMAIN SHALL BE REPAIRED IMMEDIATELY AT NO EXPENSE TO THE OWNER. HODGSON AND DOUGLAS ASSUMES NO RESPONSIBILITY FOR ANY NOT SHOWN ON PLANS.
- 4. ALL PROPOSED AND FINISHED GRADES ARE BASED ON INFORMATION PROVIDED BY THE OWNERS SURVEY AND/OR CIVIL ENGINEER. ANY DISCREPANCIES IN ACTUAL FIELD MEASUREMENTS ARE TO BE REPORTED TO THE LANDSCAPE ARCHITECT IMMEDIATELY.
- 5. EASEMENTS, BUILDING SETBACKS, CURB AND GUTTER AND UNDERGROUND UTILITIES HAVE BEEN SUPPLIED TO HODGSON AND DOUGLAS BY THE PROJECT CIVIL ENGINEER. REFER TO CIVIL DRAWINGS FOR ADDITIONAL INFORMATION.
- 6. CONTRACTOR IS RESPONSIBLE FOR REPLACEMENT OF ANY EXISTING MATERIALS THAT ARE DAMAGED DURING CONSTRUCTION THROUGH SUBSTANTIAL COMPLETION INCLUDING BUT NOT LIMITED TO HARDSCAPE, PLANTING, AND IRRIGATION.
- 7. COORDINATION: CONTRACTOR SHALL BE RESPONSIBLE FOR ALL COORDINATION WITH OTHER SUB-CONTRACTORS AS REQUIRED TO ACCOMPLISH CONSTRUCTION OPERATIONS PER DESIGN.
- 3. CONTRACTOR IS RESPONSIBLE FOR ALL QUANTITIES PER DRAWINGS AND SPECIFICATIONS. ANY QUANTITIES PROVIDED BY HODGSON AND DOUGLAS ARE PROVIDED FOR CONVENIENCE ONLY. CONTRACTORS ARE TO BID THEIR OWN QUANTITIES. NOTIFY LANDSCAPE ARCHITECT OF ANY DISCREPANCIES.
- 9. NO SUBSTITUTIONS OF ANY MATERIALS SHALL BE ALLOWED WITHOUT WRITTEN CONSENT OF LANDSCAPE ARCHITECT.
- 10. MOCKUPS ARE REQUIRED FOR THIS PROJECT. REFER TO MOCK-UPS SECTION ON L0.01.
- 11. CONTRACTOR TO VERIFY THAT A MIN. DEPTH OF 12" OF SPECIFIED TOPSOIL MIX PROVIDED FOR ALL PROPOSED PLANTING AREAS. NOTIFY LANDSCAPE ARCHITECT OF ANY DISCREPANCIES IMMEDIATELY.

- 1. THE CONTRACTOR SHALL BE RESPONSIBLE FOR OBTAINING NECESSARY PERMITS, GIVING NOTICES, AND PAYING FEES. THE CONTRACTOR SHALL COMPLY WITH ALL CITY, COUNTY AND STATE BUILDING CODES AND ORDINANCES RELATING TO THIS CONSTRUCTION PROJECT.
- 2. IN THE EVENT OF ANY DISCREPANCIES FOUND IN THE DRAWINGS, OR IF PROBLEMS ARE ENCOUNTERED DURING CONSTRUCTION, IT IS THE RESPONSIBILITY OF THE CONTRACTOR TO NOTIFY THE OWNER'S REPRESENTATIVE AND LANDSCAPE ARCHITECT BEFORE PROCEEDING WITH THE WORK. THE CONTRACTOR SHALL ASSUME FULL RESPONSIBILITY FOR ALL NECESSARY REVISIONS DUE TO FAILURE TO GIVE SUCH NOTIFICATION.
- 3. WHERE PLAN DETAILS DIFFER FROM CITY STANDARDS, THE LATTER SHALL BE SUBSTITUTED IF APPROVED IN WRITING BY THE LANDSCAPE ARCHITECT.
- 4. WRITTEN DIMENSIONS PREVAIL OVER SCALED DIMENSIONS. NOTIFY LANDSCAPE ARCHITECT OF ANY DISCREPANCIES
- 5. DO NOT SCALE DRAWINGS. IF DIMENSIONS ARE IN QUESTION, THE CONTRACTOR SHALL BE RESPONSIBLE FOR OBTAINING CLARIFICATION FROM THE ARCHITECT BEFORE CONTINUING WORK.
- 6. PROVIDE VERTICAL EXPANSION JOINTS WHERE ALL PAVEMENT ABUTS WALLS OR OTHER VERTICAL SURFACES (TYP.).
- 7. PRIOR TO COMMENCEMENT OF HARDSCAPE CONSTRUCTION, ALL PIERS, FOOTINGS, AND WALLS ARE TO BE SURVEYED, LAID OUT AND STAKED FOR REVIEW BY LANDSCAPE ARCHITECT. IT IS THE RESPONSIBILITY OF THE CONTRACTOR FOR ANY DEMOLITION, ADJUSTMENTS OR RECONSTRUCTION RESULTING FROM UNAUTHORIZED CONSTRUCTION ACTIVITIES.
- 8. CONTRACTOR TO LAYOUT ALL **PROPOSED WALKS, STEPS, PAVERS, WALLS, FENCING, HANDRAILS AND LIGHTING** AND RECEIVE LANDSCAPE ARCHITECTS APPROVAL PRIOR TO CONSTRUCTION.

FENCE NOTES:

- COORDINATION: CARD READER ACCESS TO BE PROVIDED AT GATE LOCATIONS NOTED ON L7.00 SERIES AND ELECTRICAL ENGINEERS PLANS. THIS INFORMATION IS SHOWN FOR MEF. ONLY AND SHOULD BE COORDINATED WITH ELECTRICAL ENGINEER, OWNER, AND SECURITY CONSULTANT.
- COORDINATION: ALL FOOTING POURS (WALLS, FENCE, ETC) ARE TO BE REVIEWED AND COORDINATED WITH ADJACENT UTILITY LOCATIONS, TREE LOCATIONS, AND ADJACENT WALL FOOTINGS
- 3. DESIGN: HOLD TOPS OF FENCES AND WALLS LEVEL UNLESS NOTED OTHERWISE
- 4. DESIGN: CONTRACTOR TO PROVIDE OR APPLY FACTORY PRIMED SURFACE, 2 COATS EXTERIOR GRADE PAINT FOR ALL PAINTED STEEL
- 5. SUBMITTAL: CONTRACTOR SHALL SUBMIT FENCE/GATE COLOR AND FINISH SAMPLE FOR REVIEW AND APPROVAL PRIOR TO APPLICATION
- 7. SUBMITTAL: CONTRACTOR SHALL SUBMIT SHOP DRAWINGS WITH FENCE / GATE LOCATION PLAN AND DETAILS SHOWING DIMENSIONS, MATERIALS, AND STRUCTURAL INFORMATION FOR REVIEW AND APPROVAL BY OWNER'S AUTHORIZED REPRESENTATIVE BEFORE CONSTRUCTION
- 8. ALL POOL WALLS AND FENCES 48" MIN UNCLIMABLE AND TO CONTAIN NO FOOTHOLDS ALONG EXTERIOR

WALL NOTES:

- . COORDINATION: REFER TO CIVIL ENGINEER'S GRADING PLAN TO CONFIRM ALL WALL HEIGHTS.
- 2. COORDINATION: ALL FOOTING POURS (WALLS, FENCE, ETC) ARE TO BE REVIEWED AND COORDINATED WITH ADJACENT UTILITY LOCATIONS, TREE LOCATIONS, AND WHERE WALL FOOTINGS ARE ADJACENT EACH OTHER (MONOLITHIC POURS BETWEEN ADJACENT WALLS)
- . DESIGN: KEEP WALLS VERTICALLY PLUMB UNLESS OTHERWISE NOTED
- 4. DESIGN: TOP OF WALLS TO BE CONSISTENT ELEVATION (NOT SLOPED) UNLESS OTHERWISE NOTED, OVERALL WALL HEIGHTS MAY VARY SLIGHTLY BASED ON GRADING
- 5. SUBMITTAL: CONTRACTOR SHALL SUBMIT SAMPLES OF ALL WALLS TO SHOW MATERIALS, FINISH, COLOR, AND JOINTING. ALL SAMPLES SHALL BE APPROVED BY THE OWNER'S AUTHORIZED REPRESENTATIVE BEFORE CONSTRUCTION
- 6. SUBMITTAL: CONTRACTOR SHALL SUBMIT SHOP DRAWINGS WITH WALL LOCATION PLAN AND WALL DETAILS SHOWING DIMENSIONS, MATERIALS, AND STRUCTURAL INFORMATION FOR REVIEW AND APPROVAL BY OWNER'S AUTHORIZED REPRESENTATIVE BEFORE CONSTRUCTION

UTILITY NOTES:

- 1. COORDINATION: BEFORE INSTALLING ALL UNDERGROUND HARDSCAPE FEATURES (i.e. FENCE FOOTINGS, WALL FOOTINGS, AND SERVICE LINES) VERIFY ALL LOCATIONS OF EXISTING UTILITIES AND INSTALLED UTILITIES. COORDINATE CIVIL, STRUCTURAL, ELECTRICAL, ARCHITECTURAL, AND MECHANICAL PLANS WITH THIS LANDSCAPE PACKAGE
- 2. COORDINATION: CIVIL STRUCTURES (i.e. CATCH BASINS, MANHOLES, LIFT STATIONS) ARE SHOWN FOR REFERENCE ONLY
- 3. COORDINATION: REFER TO CIVIL PLANS FOR GRADING AND DRAINAGE STRUCTURES BEFORE INSTALLATION OF WALKS, FOOTINGS, PLANTING, AND OTHER ITEMS
- 4. COORDINATION: ALL JUNCTION & VALVE BOXES SHALL BE IN PLANTING AREAS AS APPROVED BY OWNER. STAKE LOCATIONS BEFORE INSTALLATION FOR APPROVAL BY OWNER
- 5. UNDERGROUND UTILITIES:
- A. UNDERGROUND UTILITIES HAVE NOT BEEN VERIFIED BY THE OWNER, LANDSCAPE ARCHITECT, OR THEIR REPRESENTATIVES. BEFORE YOU DIG CALL TENNESSEE ONE CALL
- B. THE CONTRACTOR SHALL DETERMINE THE EXACT LOCATION OF ALL THE UTILITIES BEFORE COMMENCING WORK AND AGREES TO BE RESPONSIBLE FOR ANY AND ALL DAMAGES WHICH MIGHT RESULT FROM THE CONTRACTOR'S FAILURE TO EXACTLY LOCATE AND PRESERVE ANY UNDERGROUND UTILITIES TO REMAIN.
- C. THE CONTRACTOR SHALL VERIFY EXISTING CONDITIONS TO ENSURE THAT THE NEW WORK SHALL FIT INTO THE EXISTING SITE IN THE MANNER INTENDED AS HSOWN ON PLANS. SHOULD ANY CONDITIONS EXIST THAT ARE CONTRARY TO THOSE ON THE DRAWINGS, THE CONTRACTOR SHALL NOTIFY THE OWNERS RERESENTATIVE PRIOR TO PREFROMING ANY WORK IN THE AREA INVOLVING DIFFERENCES. NOTIFICATION SHALL BE IN THE FORM OF A DRAWING OR SKETCH INDICATING FIELD MEASUREMENTS & NOTES RELATING TO THE AREA.


PAVING NOTES:

MATERIAL NOTES

- COORDINATION: REFER TO CIVIL PLANS FOR ALL VEHICULAR PAVING DETAILS.

 VEHICULAR PAVING SHOWN IN LANDSCAPE PACKAGE IS ONLY FOR AESTHETIC AND
 JOINTING PURPOSES

 ONLY.
- 2. COORDINATION: WHERE SIDEWALK ABUTS CURB REFER TO CIVIL ENGINEER'S PLANS FOR INTEGRAL WALK/CURB DETAIL
- 3. COORDINATION: COORDINATE INSTALLATION OF SLEEVES, VAULT COVERS, ETC. W/
 OTHER TRADES PRIOR TO POURING PAVING. IN THE EVENT THAT A COVER FALLS WITHIN
 PAVING, NOTIFY
 L.A. IMMEDIATELY BEFORE FORMING HARDSCAPE.
- L.A. IMMEDIATELY BEFORE FORMING HARDSCAPE.
- 4. COORDINATION: VERIFY LAYOUT OF PAVING WITH L.A. PRIOR TO BEGINNING WORK
- 5. ADA DESIGN REQUIREMENTS: JOINTING & FINISHING TO MEET ADA REQUIREMENTS FOR SLIP RESISTANCE & JOINT WIDTH (3/16" MAX.) 0.6 SLIP RESISTANCE COEFFICIENT
- 6. DESIGN: ALL WALKS, HEADERS, BEDLINES & WALLS SHALL HAVE SMOOTH, TANGENT, CONTINUOUS CURVES, IF APPLICABLE, UNLESS NOTED OTHERWISE.
- 7. DESIGN: CONCRETE PAVING JOINTS INCLUDE THREE JOINT TYPES CONSTRUCTION, DOWELED CONSTRUCTION, AND EXPANSION SEE CONSTRUCTION DETAILS IN L4.00 SERIES. PROVIDE DOWELED CONSTRUCTION JOINTS BETWEEN DIFFERENT PAVING COLOR TYPES, CHANGES IN DIRECTION, END OF POUR OPERATIONS, OR WHERE SPECIFICALLY INDICATED ON PLANS.
- 8. MOCK-UP SUBMITTAL: CONTRACTOR SHALL MOCK-UP 4'x4' SAMPLES OF ALL PAVING ON SITE AT LOCATION DETERMINED BY OWNER TO SHOW FINISH, COLOR, JOINTING, & INTERSECTION OF PATTERNS AS REQUESTED BY OWNER. ALL SAMPLES SHALL BE APPROVED BY OWNER
- 9. MOCK-UP SUBMITTAL: PAVING WORK TO MATCH OWNER APPROVED PAVING MOCK-UPS. WORK NOT MATCHING MAY BE REJECTED BY OWNER

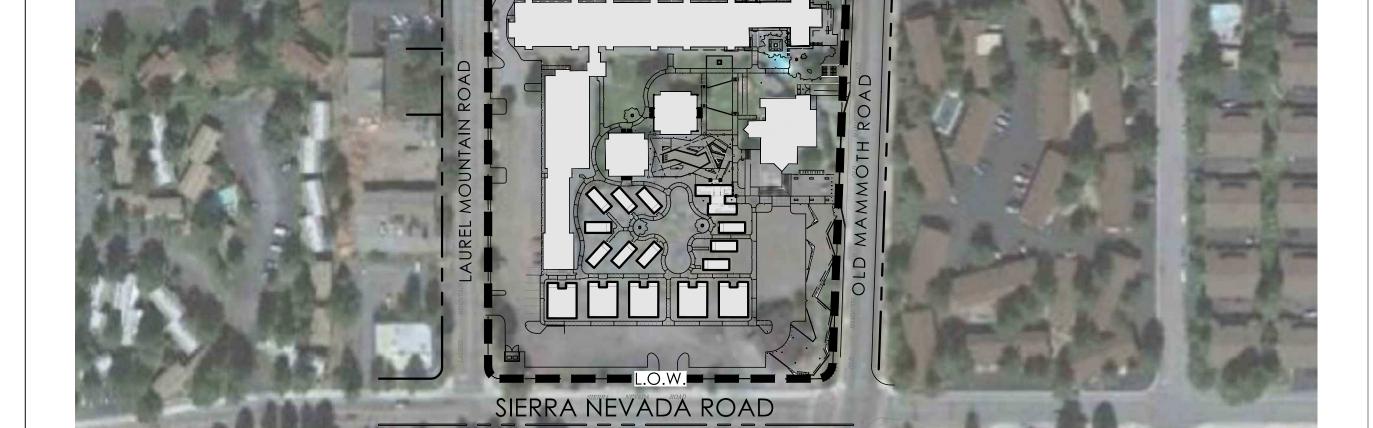

N.T.S

SIERRA NEVADA RESORT

164 OLD MAMMOTH RD MAMMOTH LAKES, CA 93546

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PROJECT ISSUES:

DESIGN REVIEW SUBMITTAL 11/17.

DESIGN REVIEW RESUBMITTAL

SHEET DATE:

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DRAWN: CHECKED:

PROJECT No.

SHEET TITLE:

GENERAL NOTES

DESIGN REVIEW SUBMITTAL

D0.00

KEY MAP

+ TC

+ BC

+ TD

FFE

LA

SPEC

LX.XX

CALLOUT

POB

SYMBOLS LEGEND

LX.XX

TOP OF CURB

TOP OF DRAIN

REFERENCE

MATCHLINE

CENTERLINE

LIMIT OF WORK

EXPANSION JOINT

CONTROL JOINT

MATERIAL CALLOUT

POINT OF BEGINNING

PLAN ENLARGEMENT

BREAK LINE

CALLOUT

SECTION


ELEVATION


BOTTOM OF CURB

LANDSCAPE AREA

SPECIFICATIONS

FINISH FLOOR ELEVATION

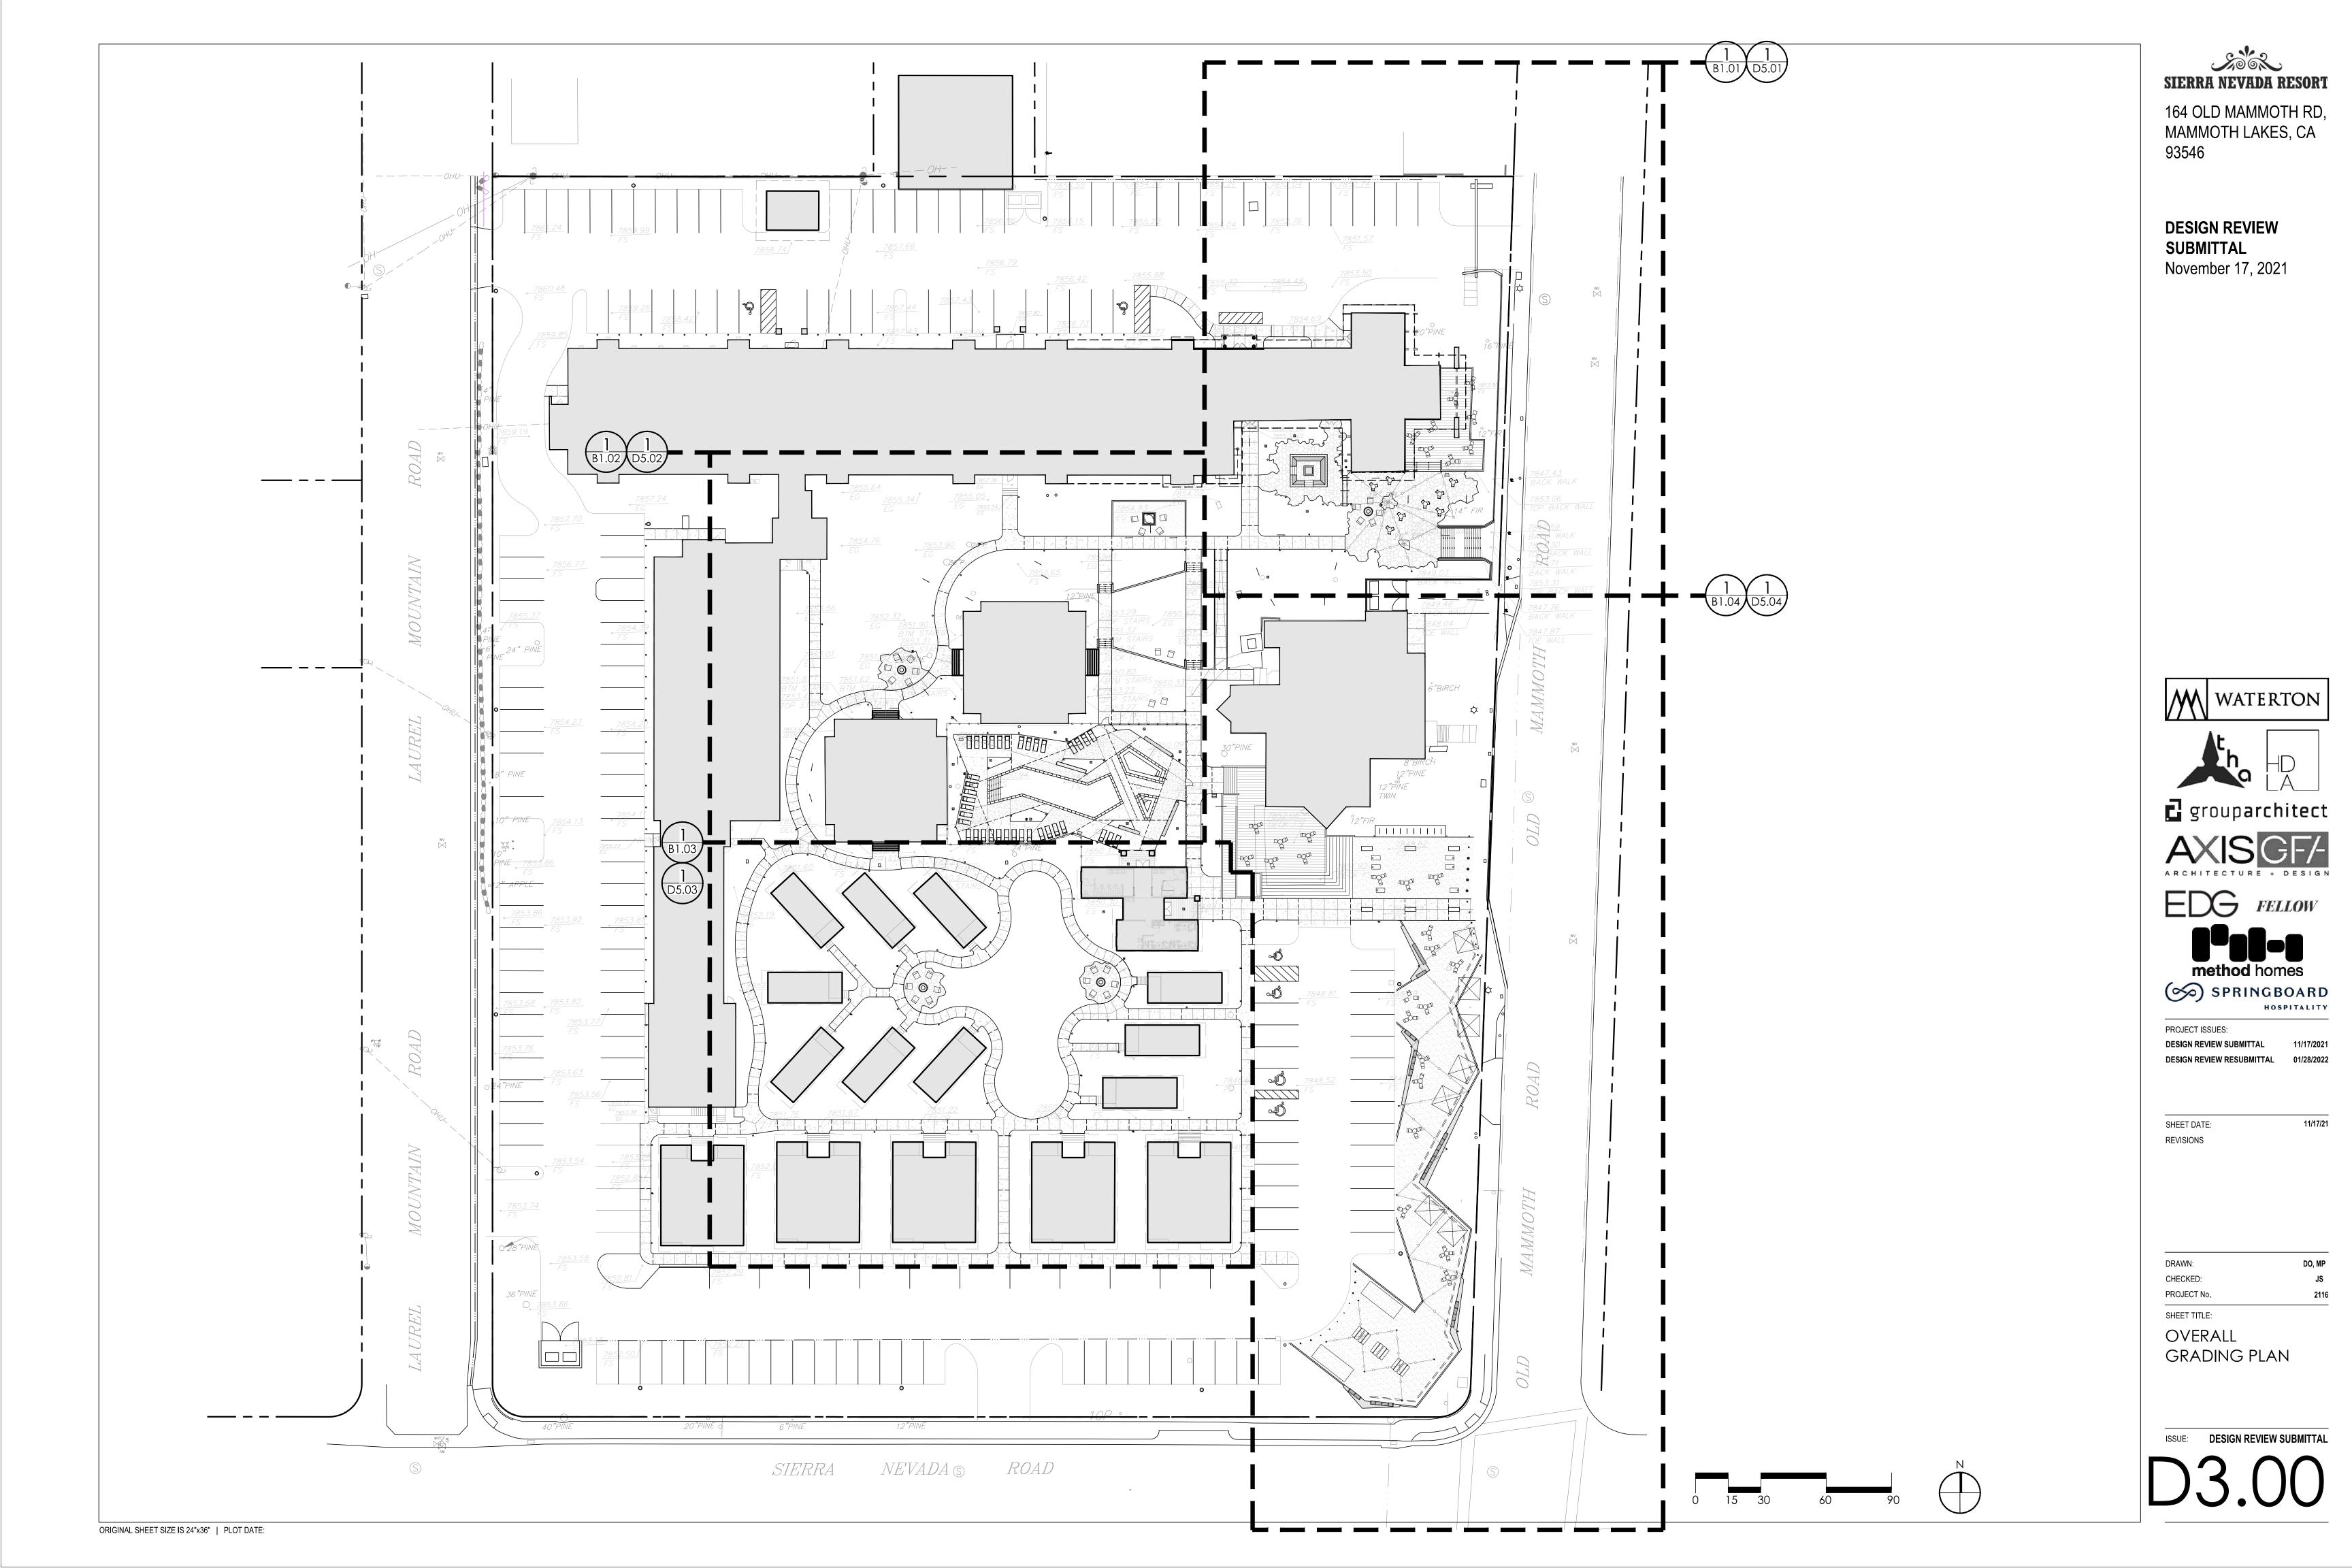

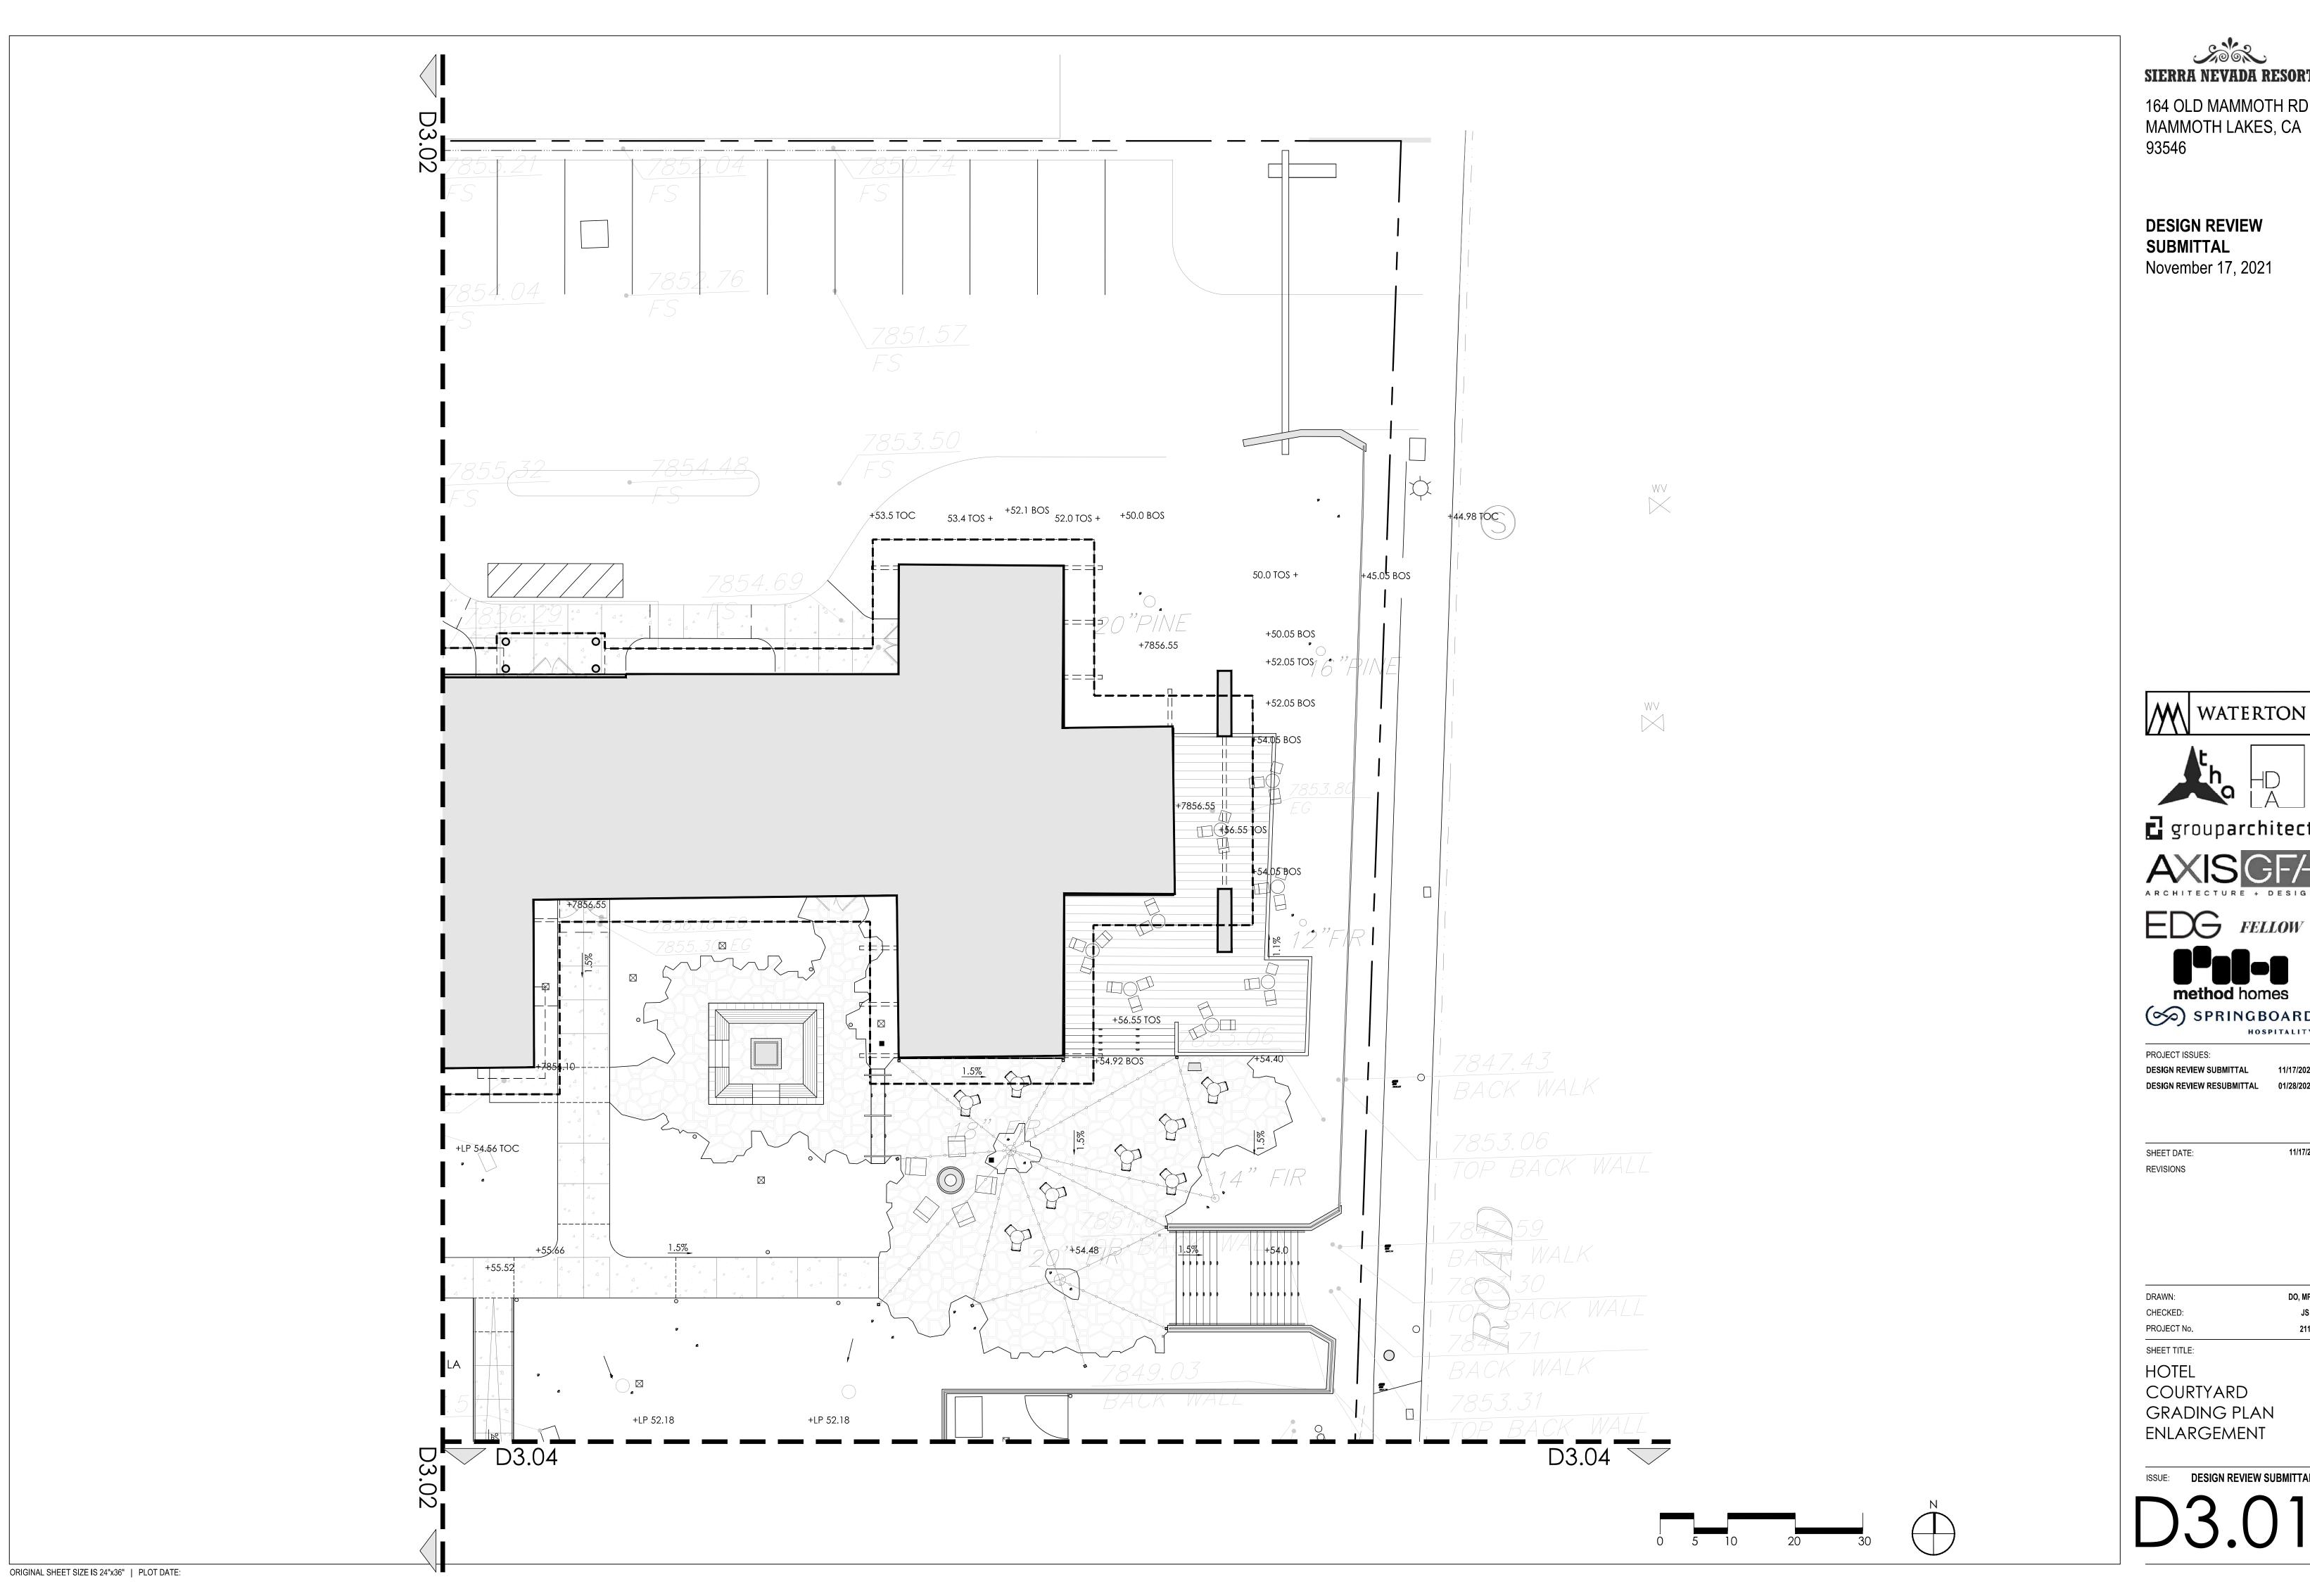

164 OLD MAMMOTH RD, MAMMOTH LAKES, CA 93546

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WATERTON grouparchitect

method homes SPRINGBOARD
HOSPITALITY PROJECT ISSUES:

DESIGN REVIEW SUBMITTAL DESIGN REVIEW RESUBMITTAL 01/28/2022

SHEET DATE:


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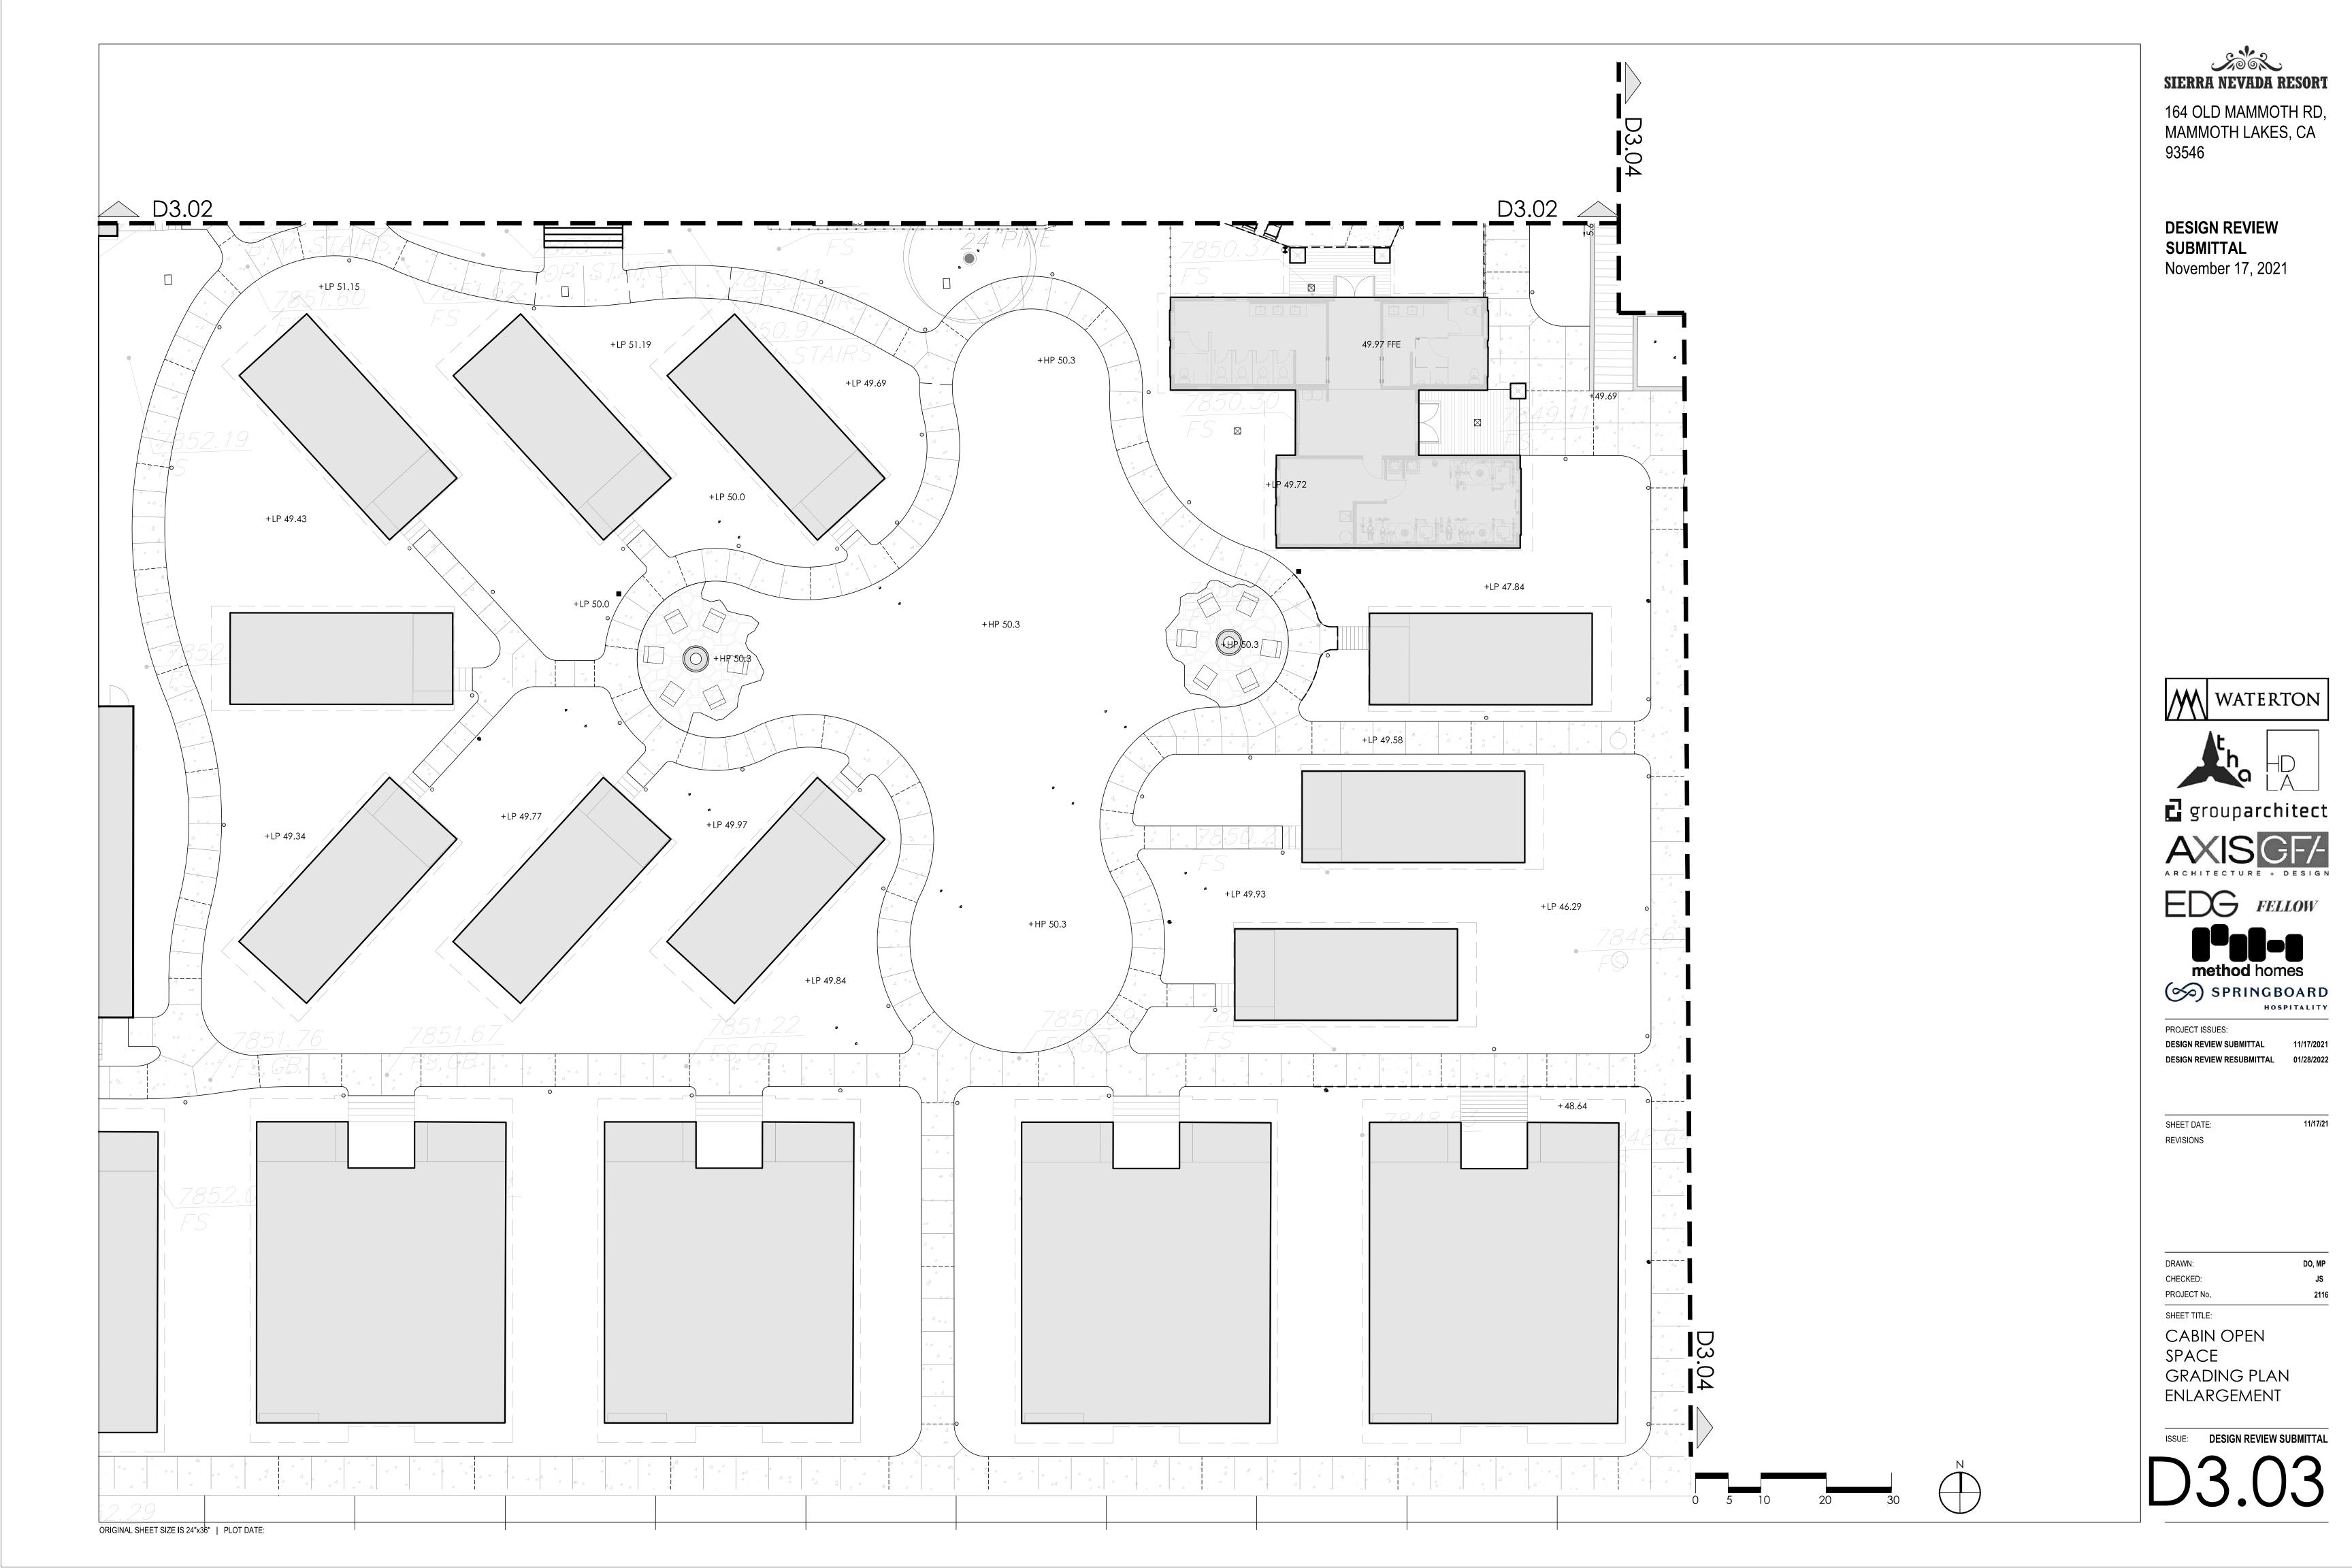
PROJECT No. SHEET TITLE:

HOTEL COURTYARD

GRADING PLAN ENLARGEMENT

ISSUE: DESIGN REVIEW SUBMITTAL



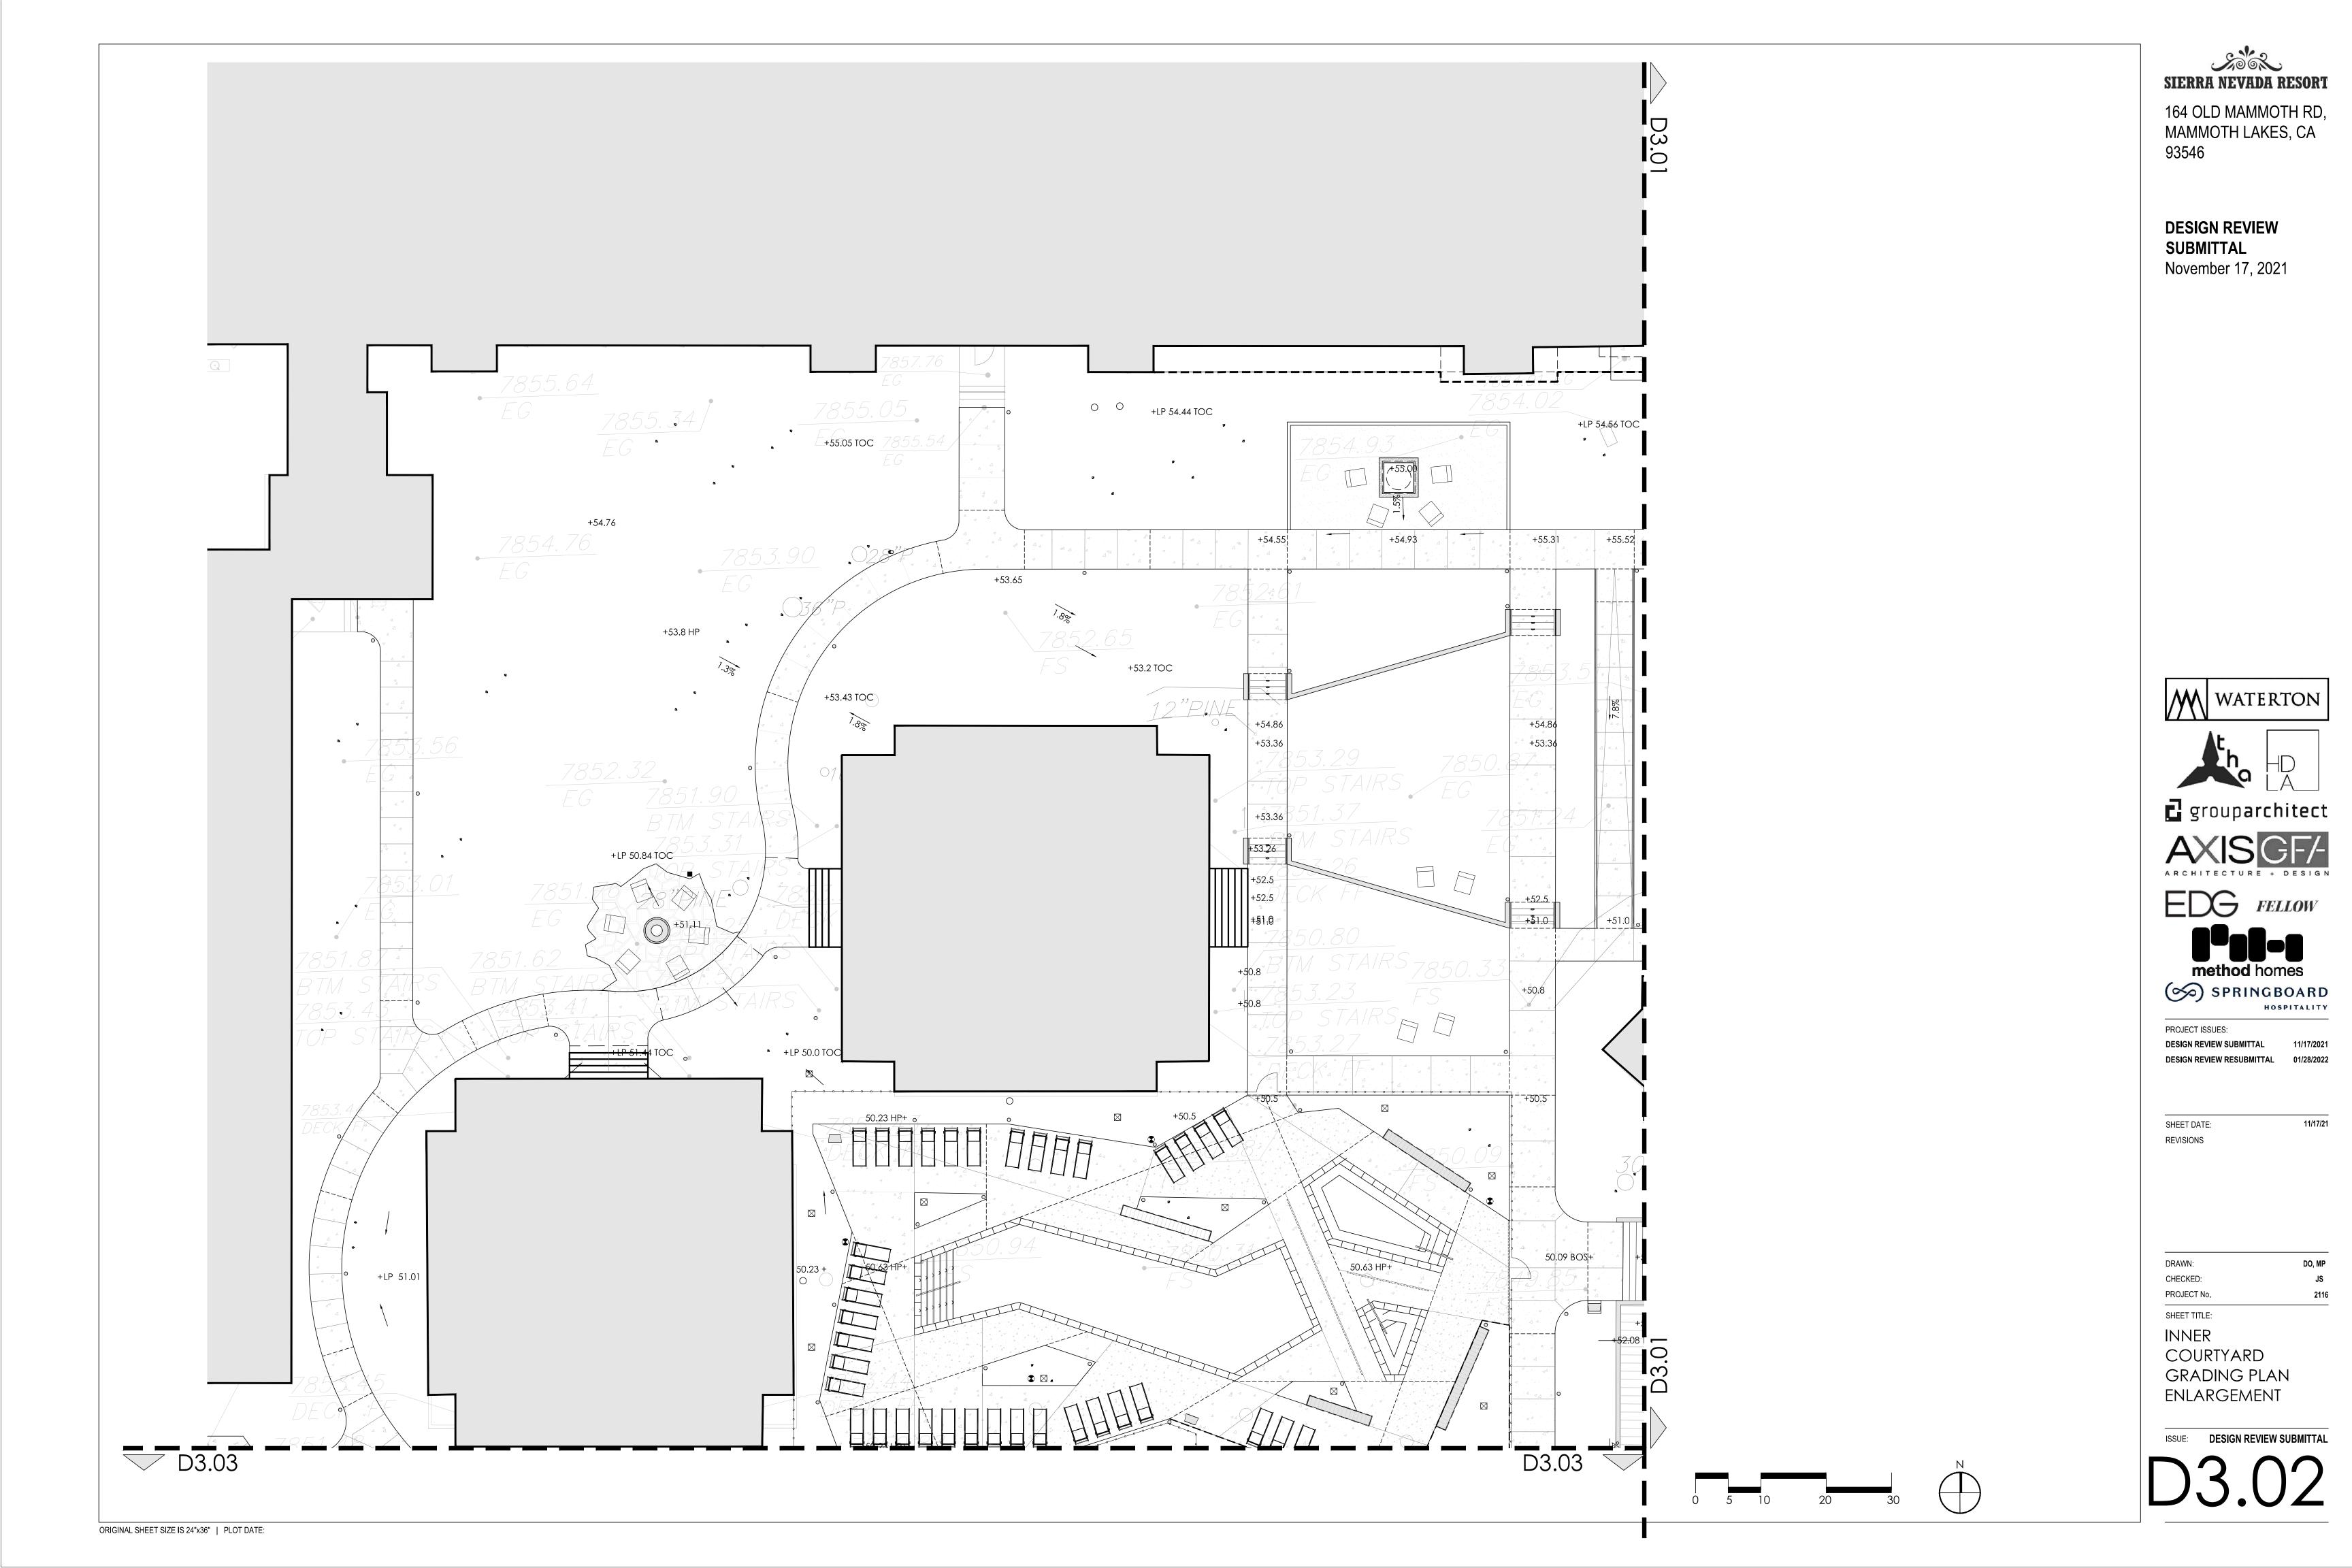



164 OLD MAMMOTH RD, MAMMOTH LAKES, CA

DESIGN REVIEW SUBMITTAL November 17, 2021

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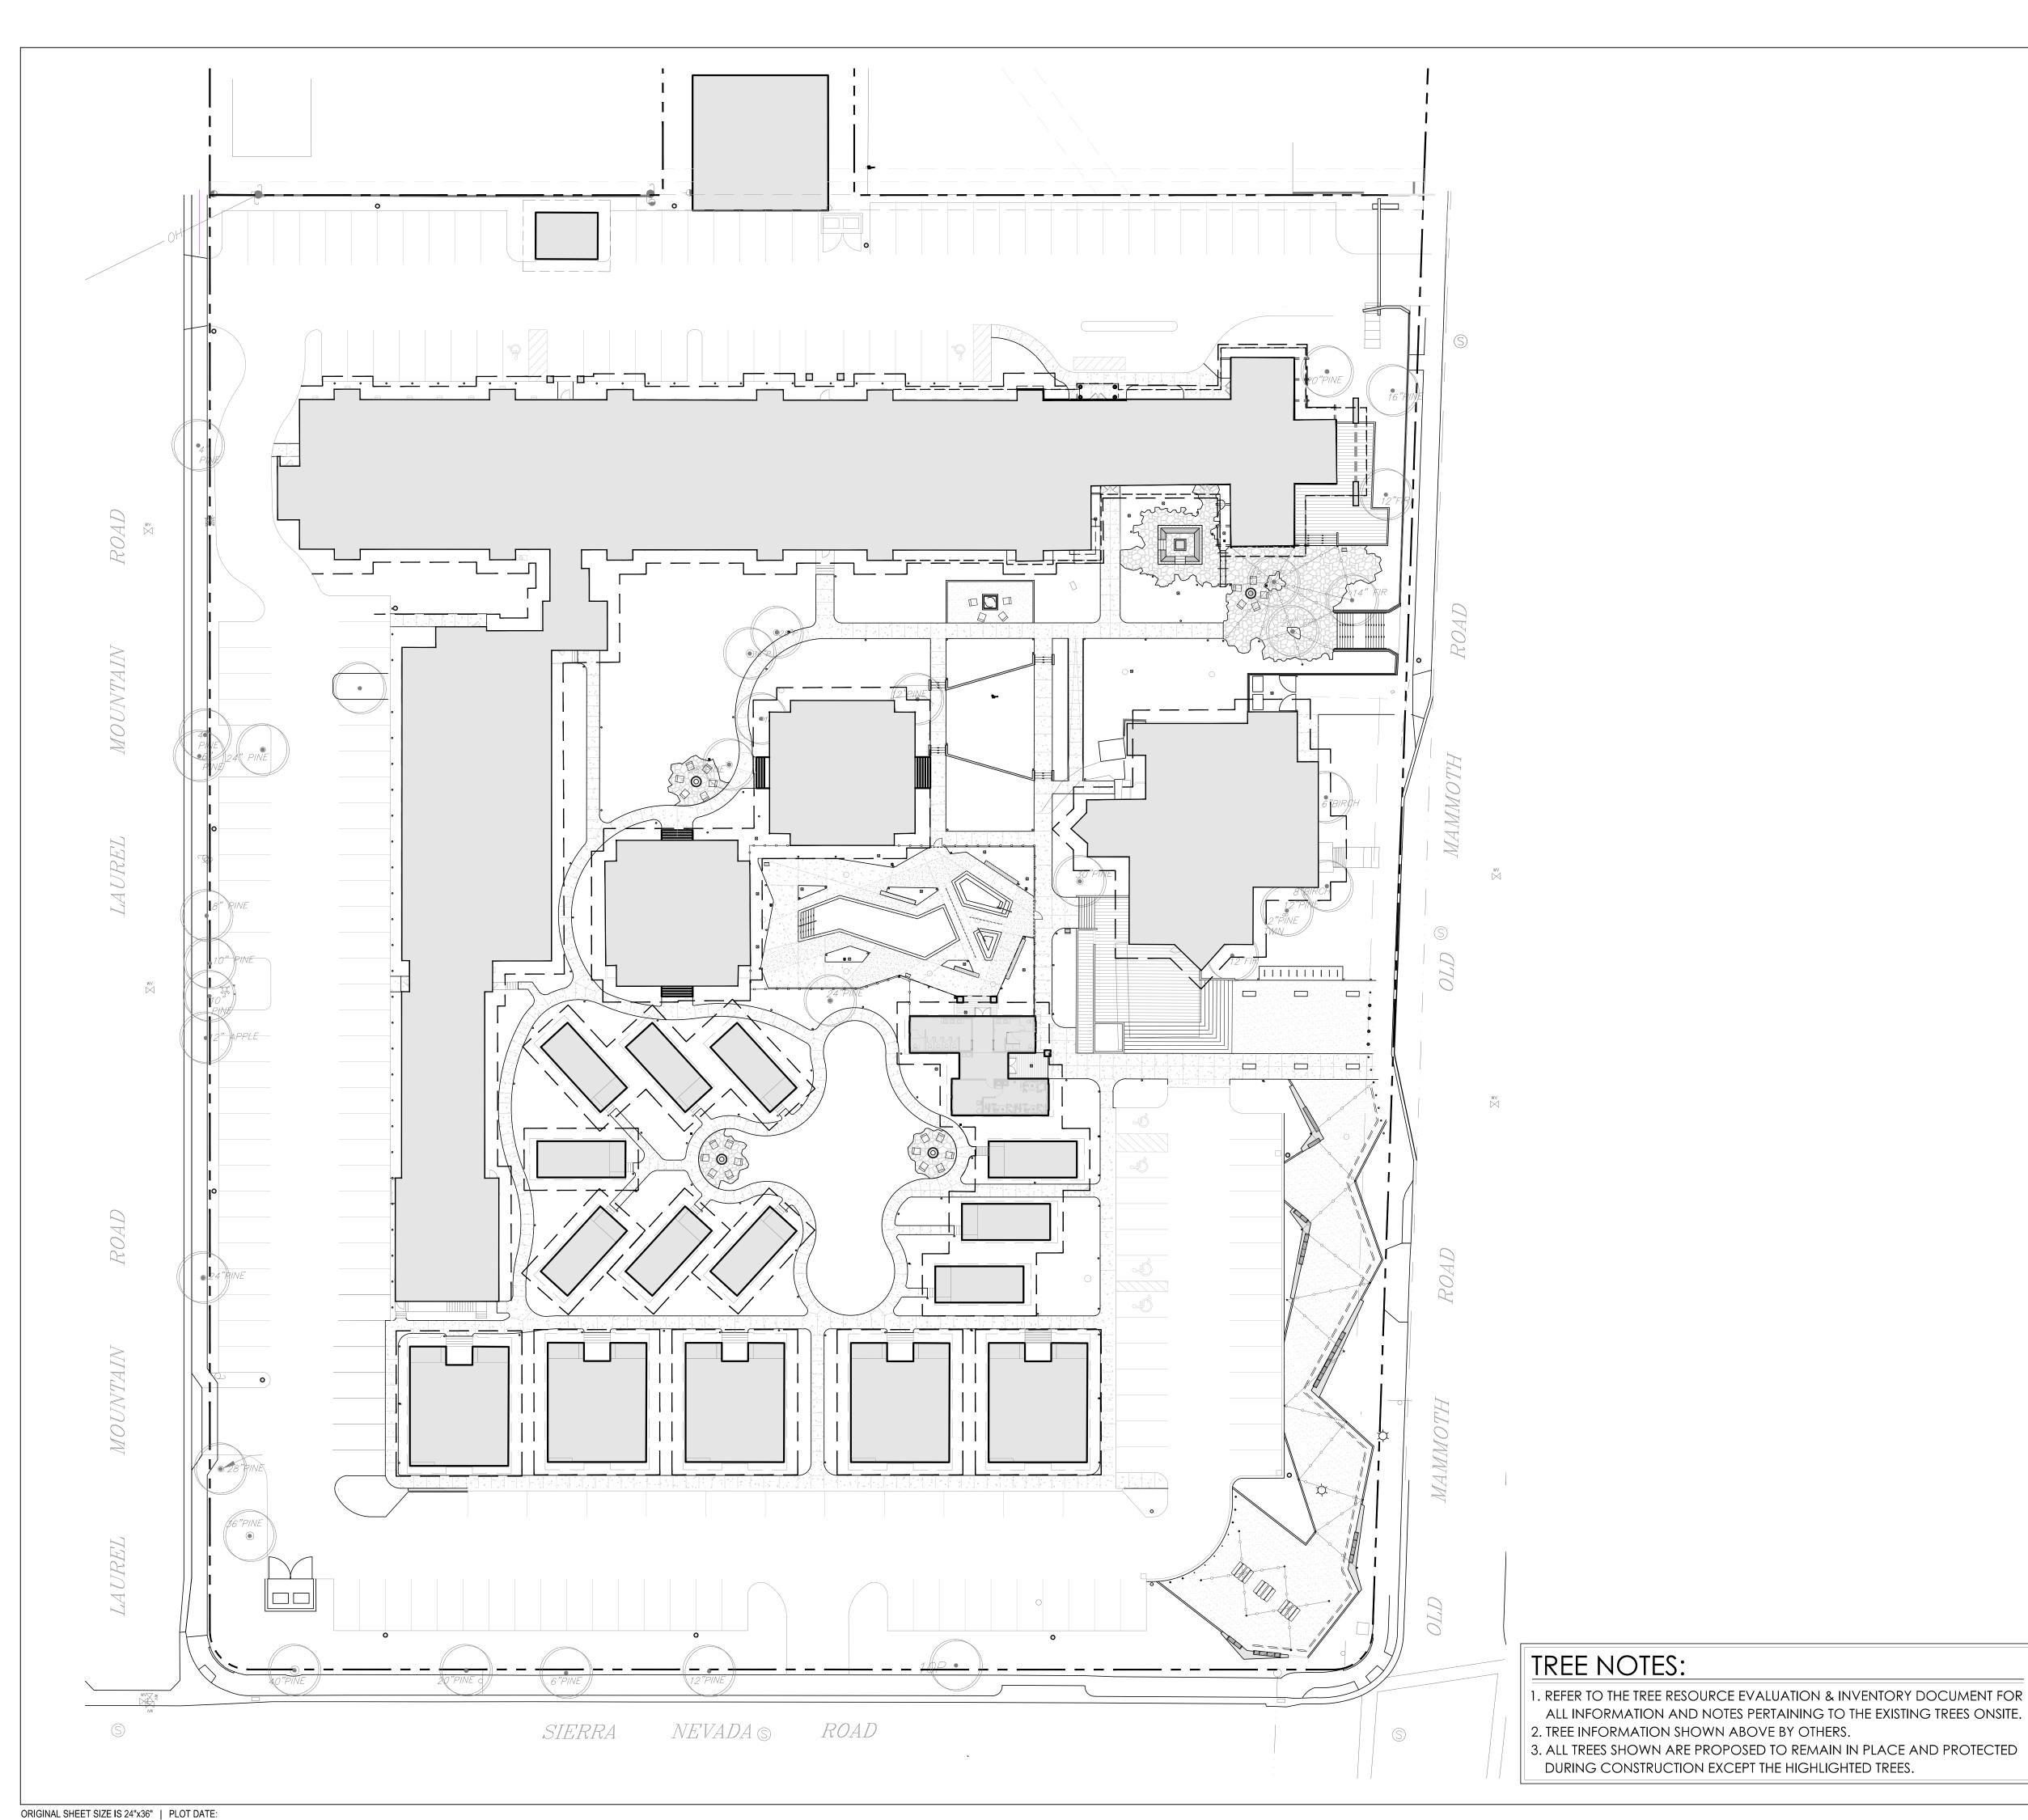


SPRINGBOARD
HOSPITALITY PROJECT ISSUES: DESIGN REVIEW SUBMITTAL

PROJECT No.

FOOD COURTYARD GRADING PLAN

ISSUE: DESIGN REVIEW SUBMITTAL



164 OLD MAMMOTH RD, MAMMOTH LAKES, CA 93546

DESIGN REVIEW SUBMITTAL

November 17, 2021

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DESIGN REVIEW SUBMITTAL DESIGN REVIEW RESUBMITTAL

SHEET DATE: REVISIONS

PROJECT No.

CHECKED:


SHEET TITLE:
EXISTING TREE PLAN

ISSUE: **DESIGN REVIEW SUBMITTAL**

D5.00

ALL INFORMATION AND NOTES PERTAINING TO THE EXISTING TREES ONSITE.

3. ALL TREES SHOWN ARE PROPOSED TO REMAIN IN PLACE AND PROTECTED

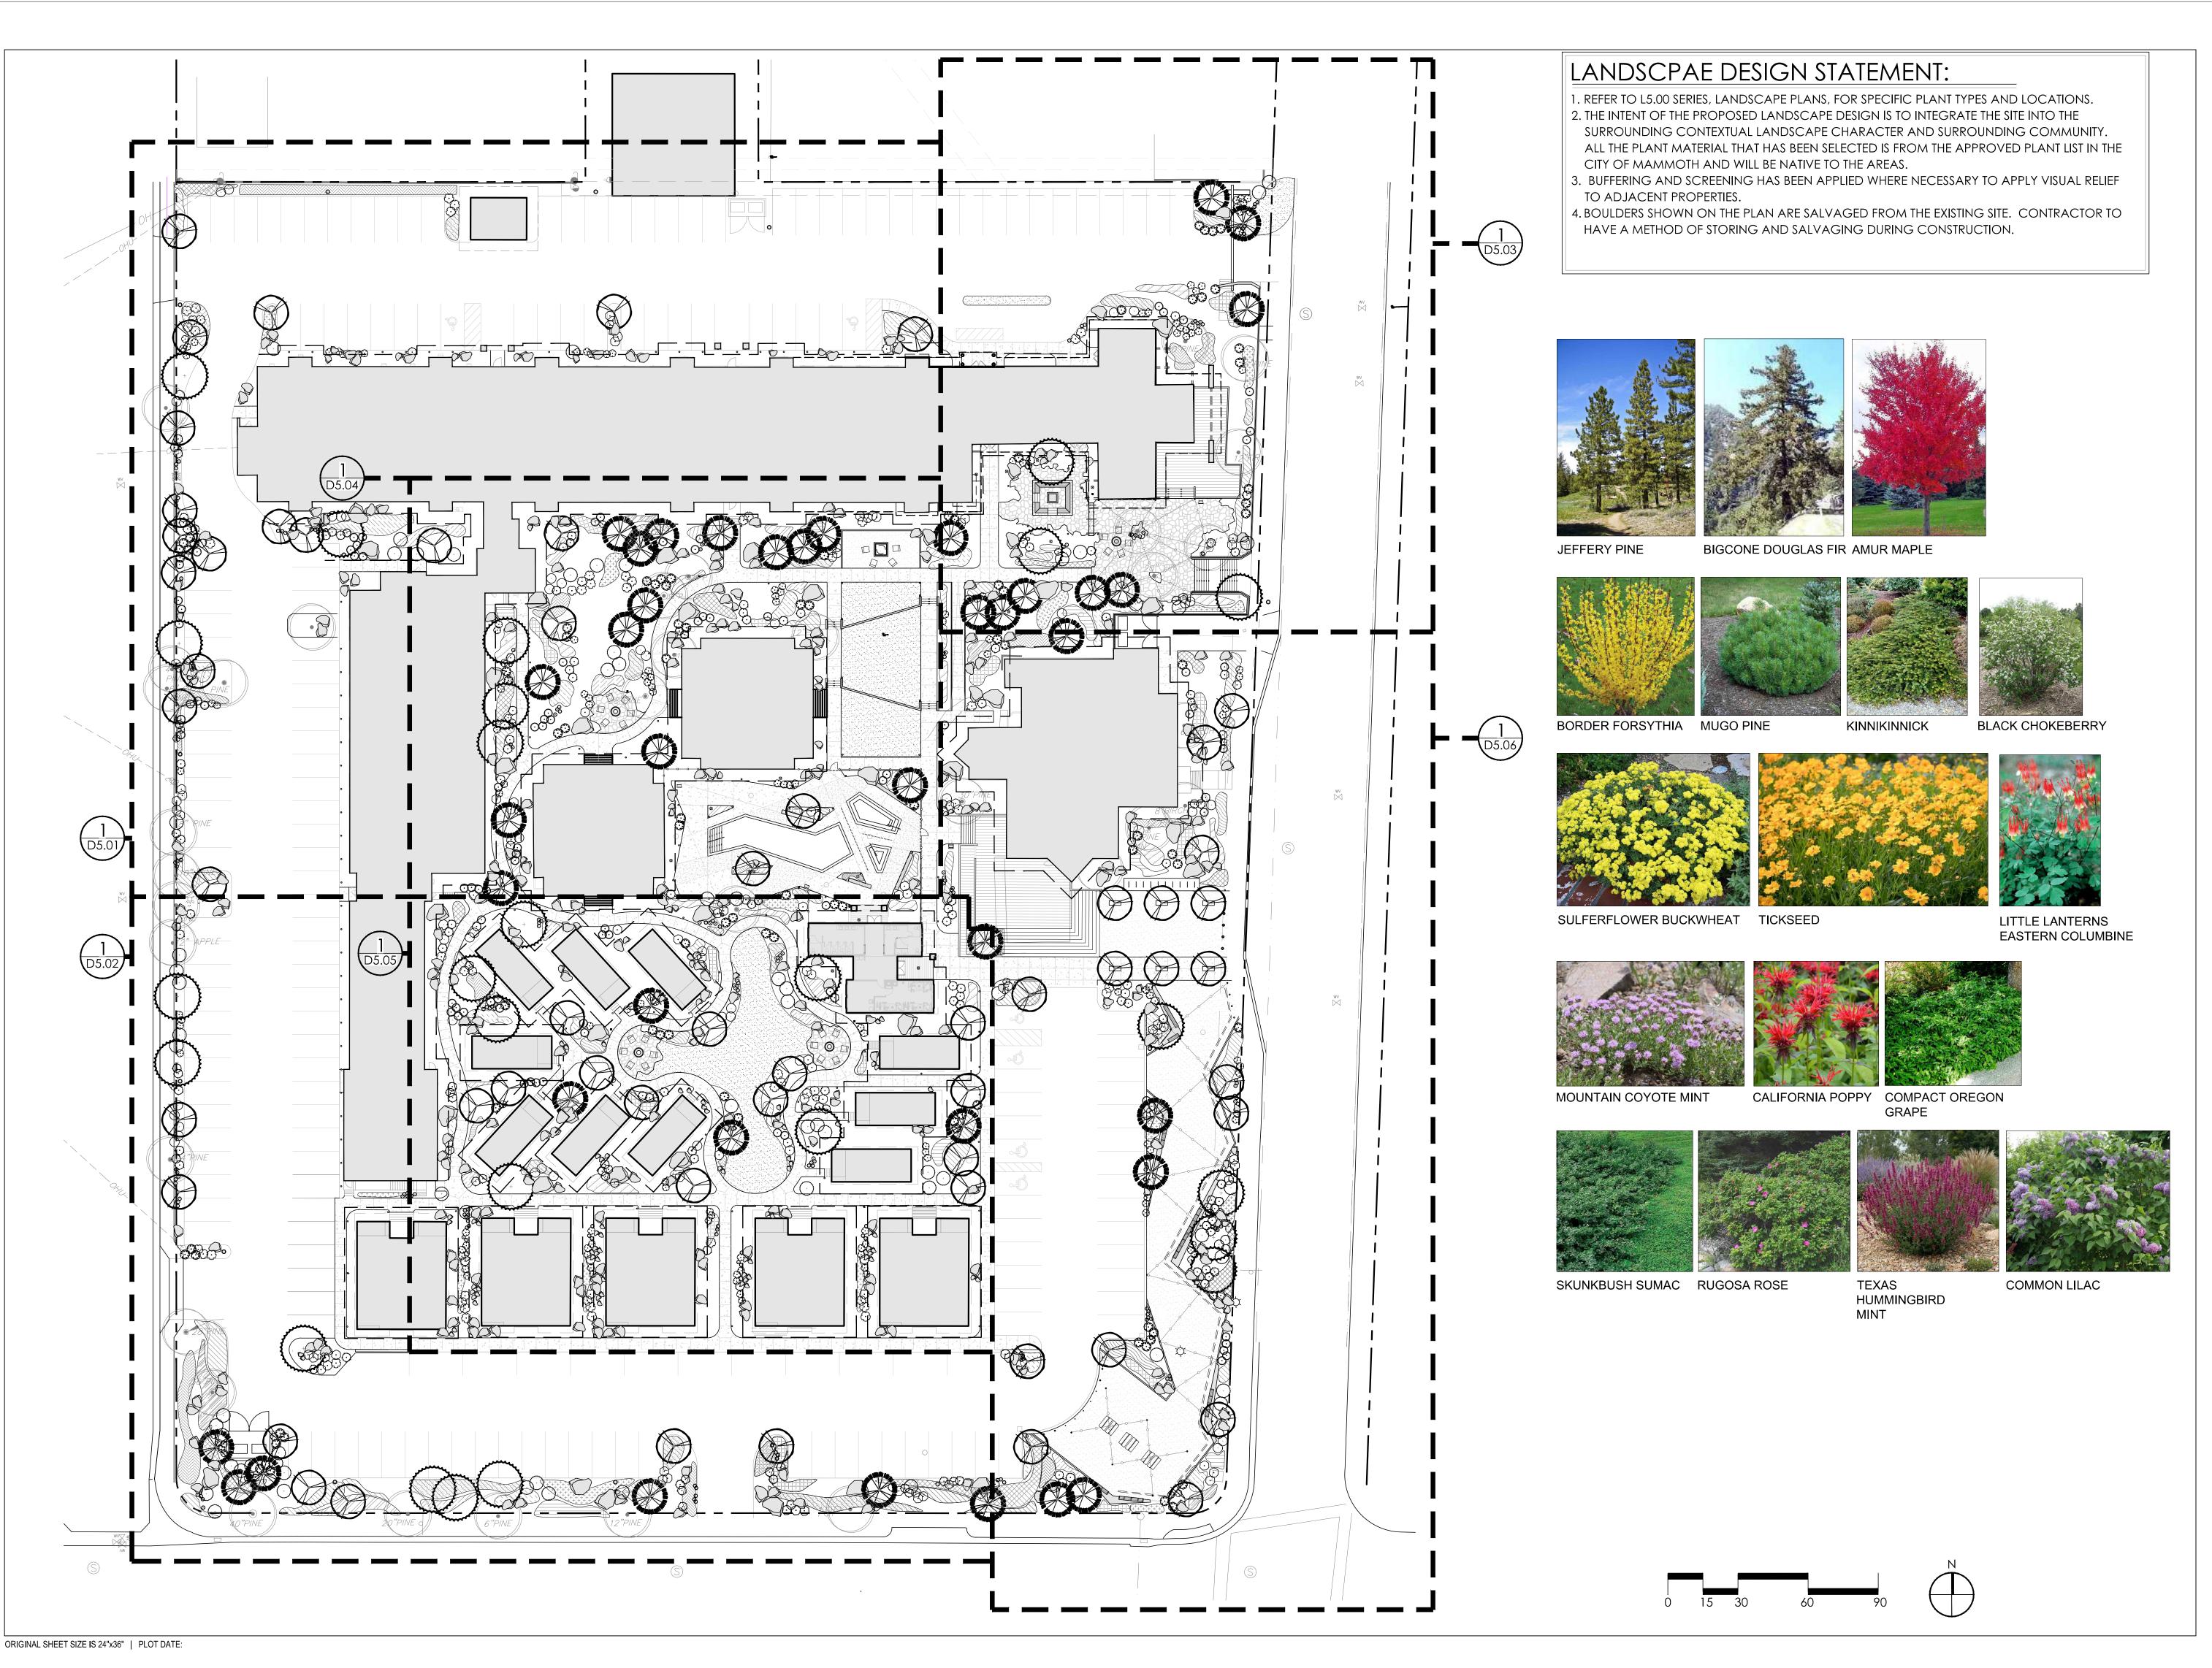

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PROJECT ISSUES:

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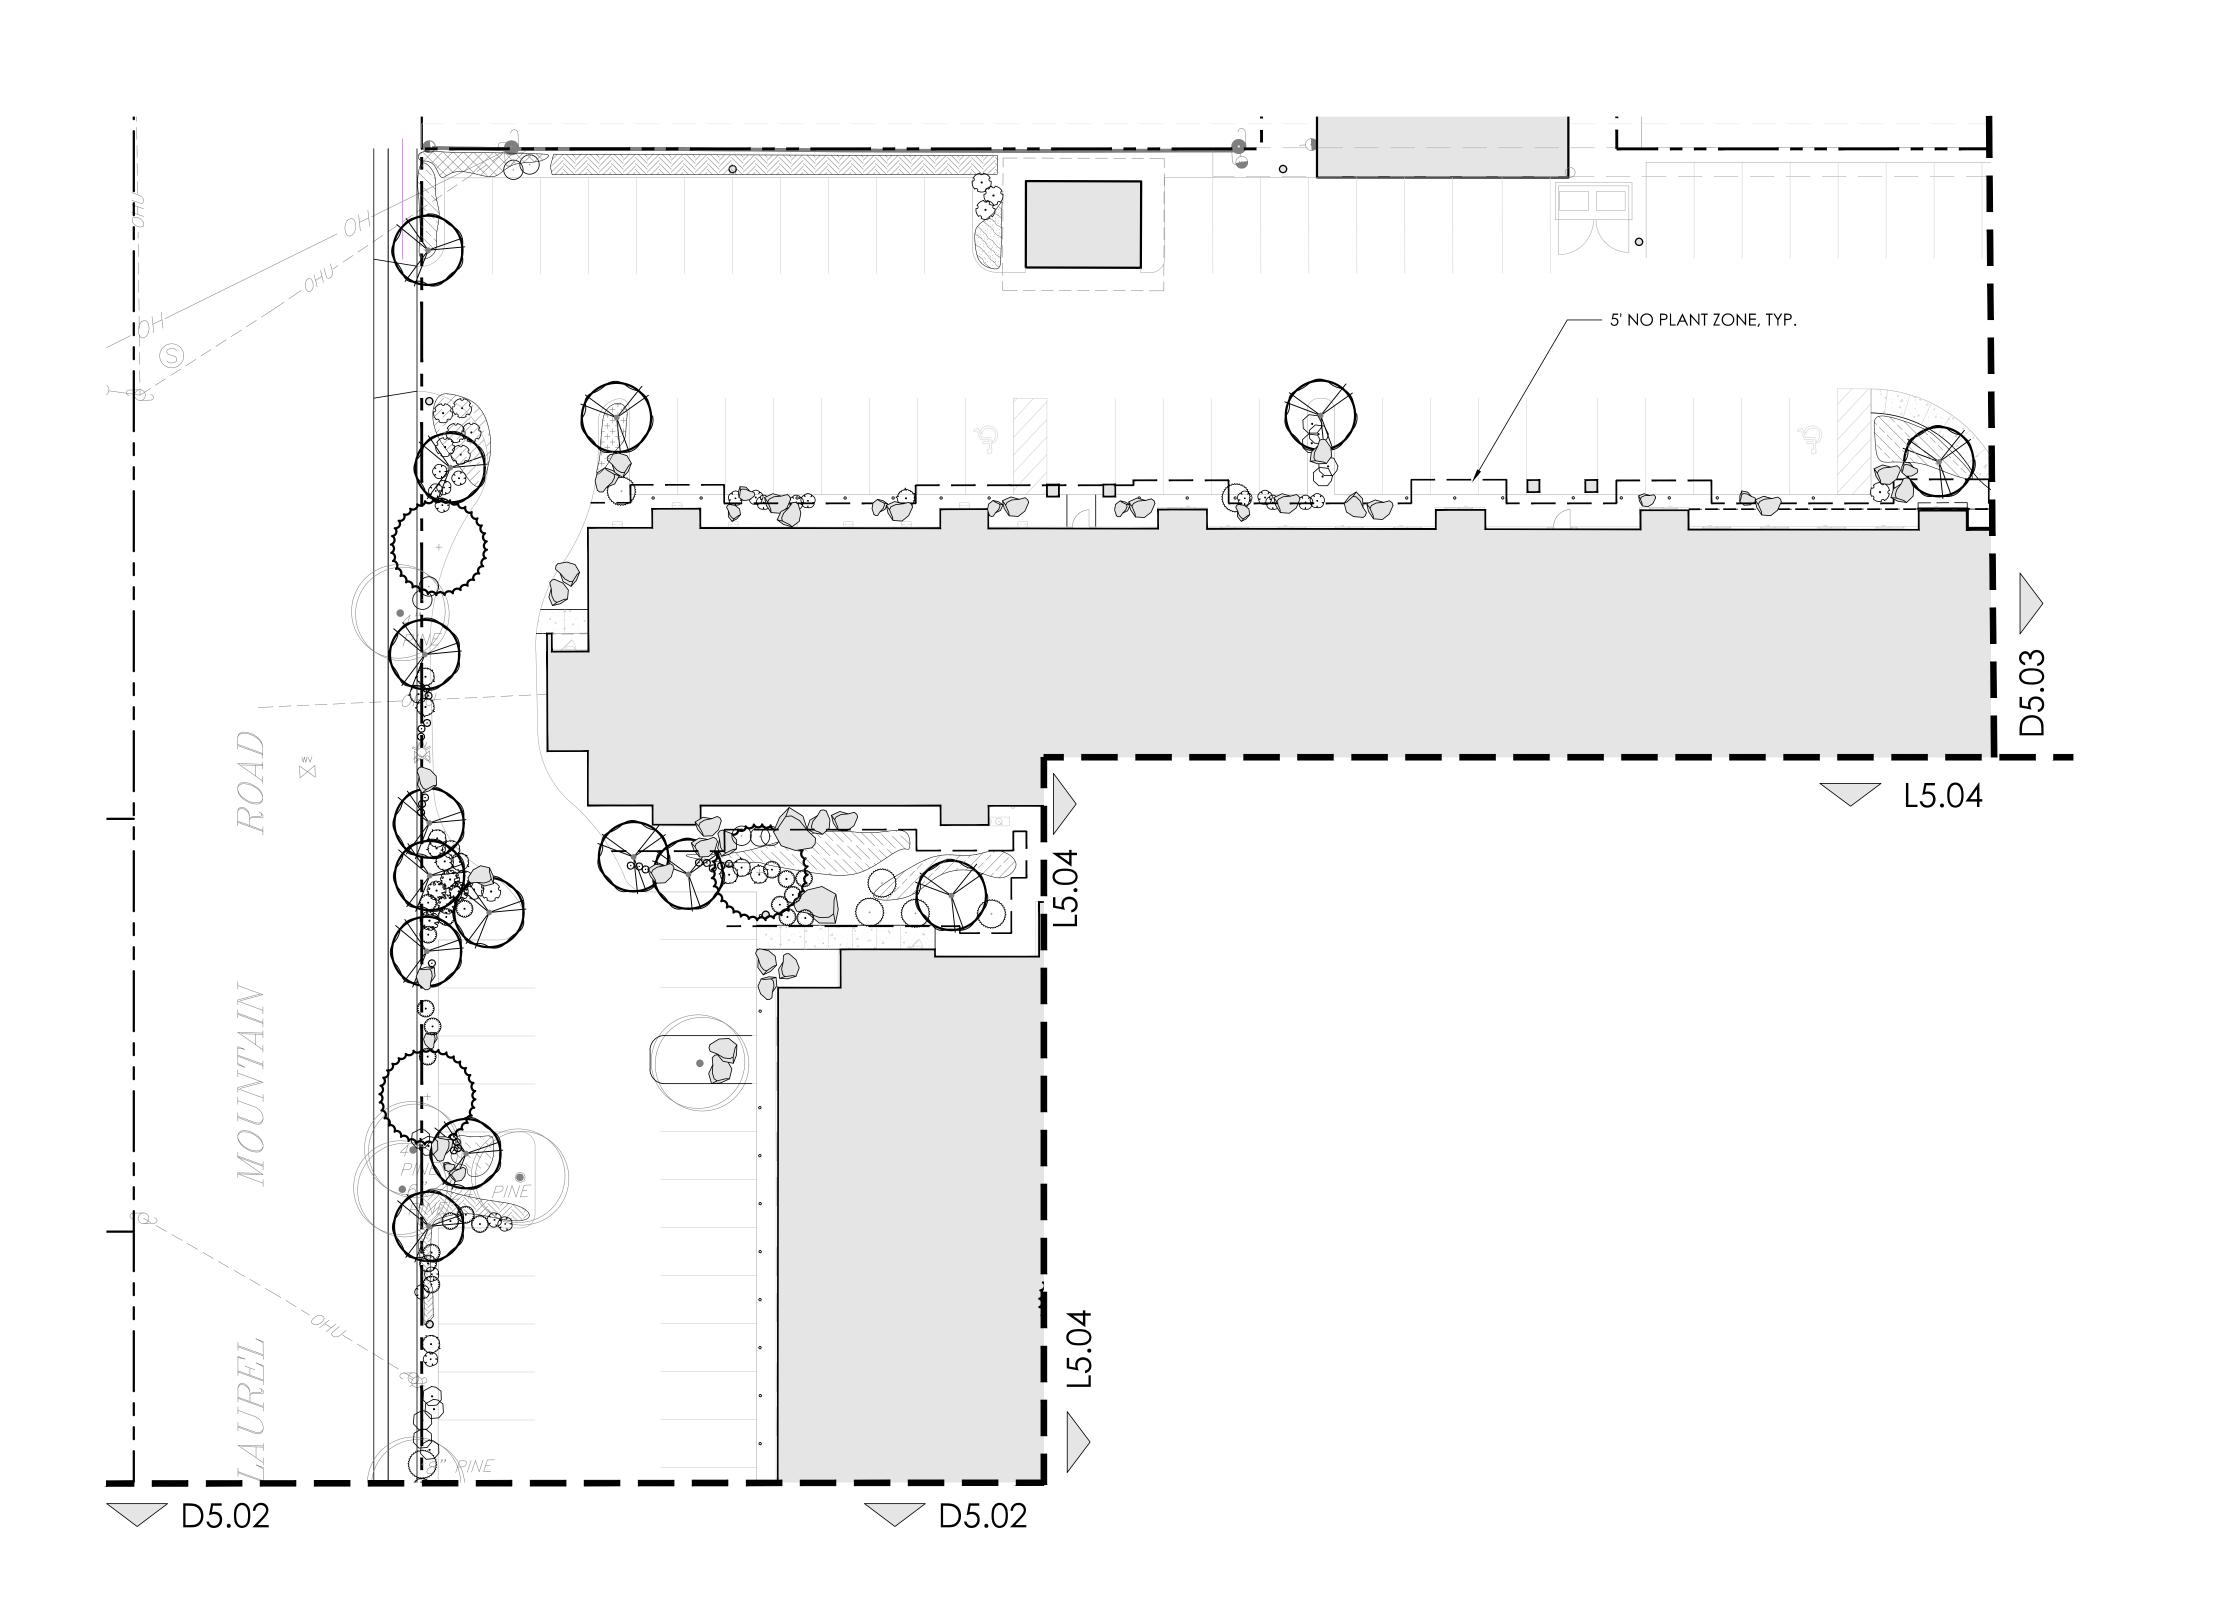
SHEET DATE: REVISIONS

PROJECT No.

OVERALL PLANTING PLAN

ISSUE: DESIGN REVIEW SUBMITTAL

D5.00A



ORIGINAL SHEET SIZE IS 24"x36" | PLOT DATE:



SIERRA NEVADA RESORT 164 OLD MAMMOTH RD, MAMMOTH LAKES, CA 93546

DESIGN REVIEW SUBMITTAL November 17, 2021



PROJECT No.


SHEET DATE:

SHEET TITLE:
NORTH LANDSCAPE PLAN **ENLARGEMENT**

ISSUE: **DESIGN REVIEW SUBMITTAL**

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D5.01



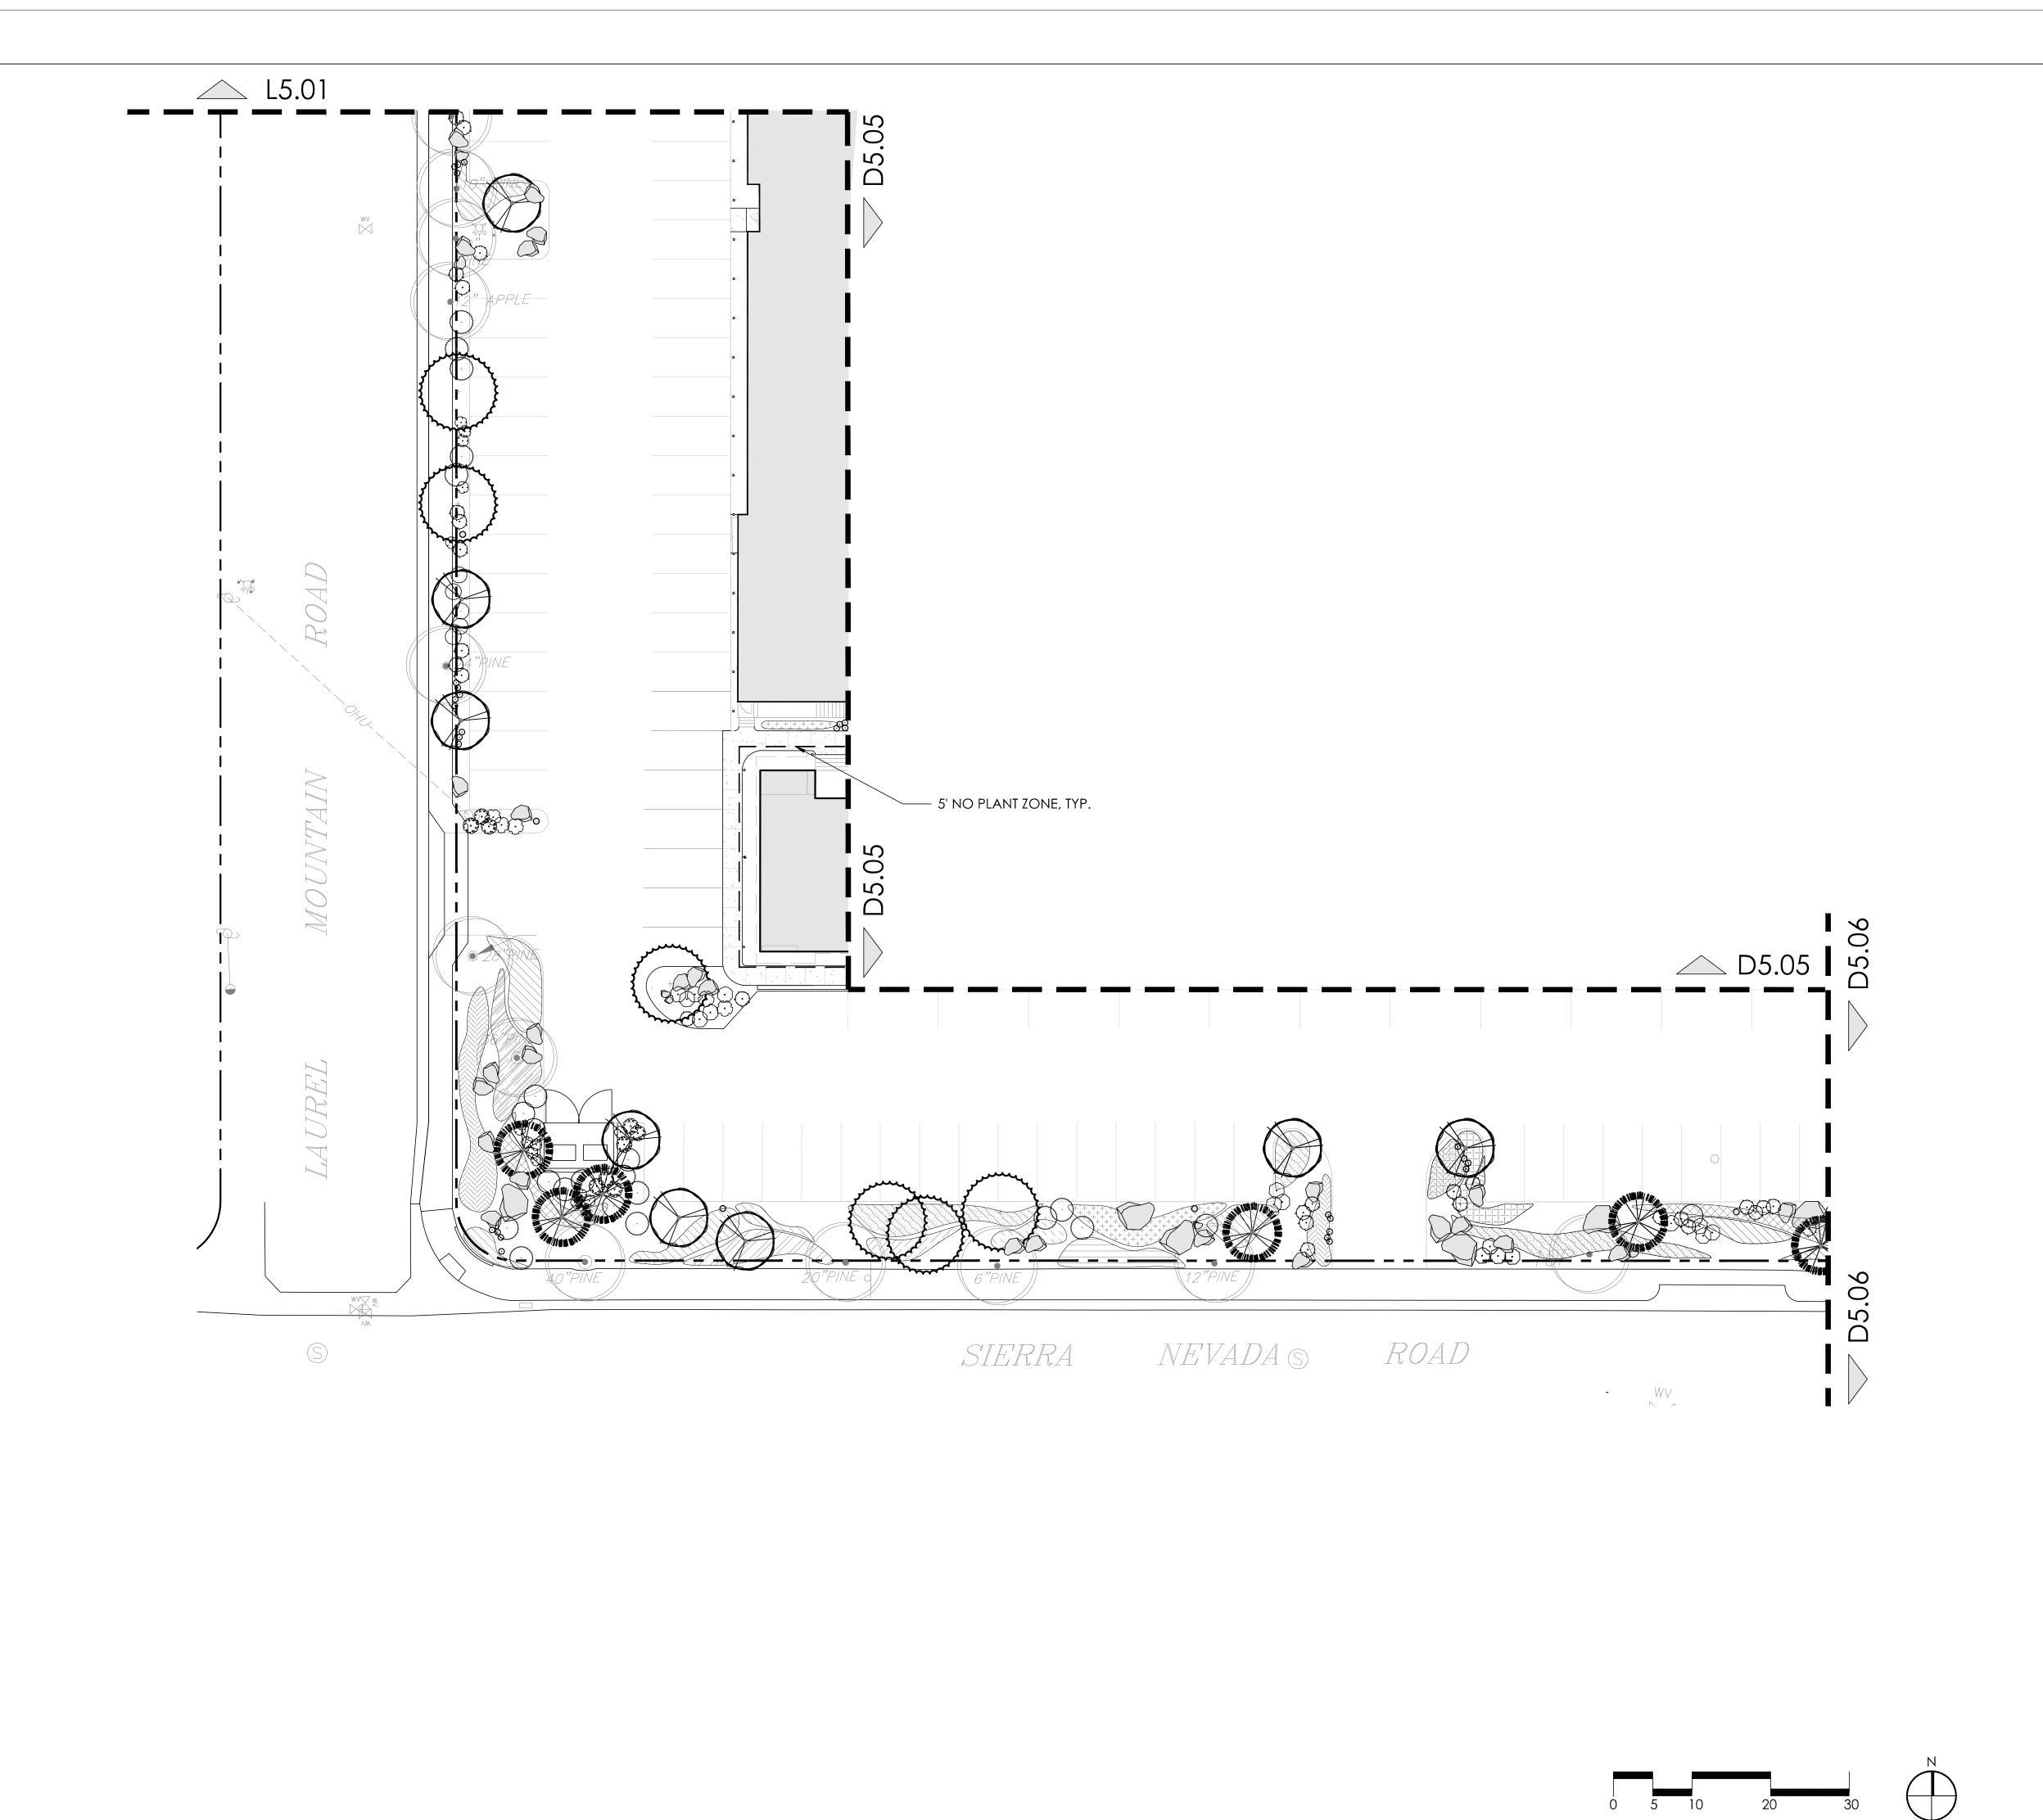

DESIGN REVIEW SUBMITTAL November 17, 2021




CHECKED:
PROJECT No.

SHEET DATE: REVISIONS

SHEET TITLE:
SOUTH LANDSCAPE PLAN
ENLARGEMENT

ISSUE: **DESIGN REVIEW SUBMITTAL**

D5.02

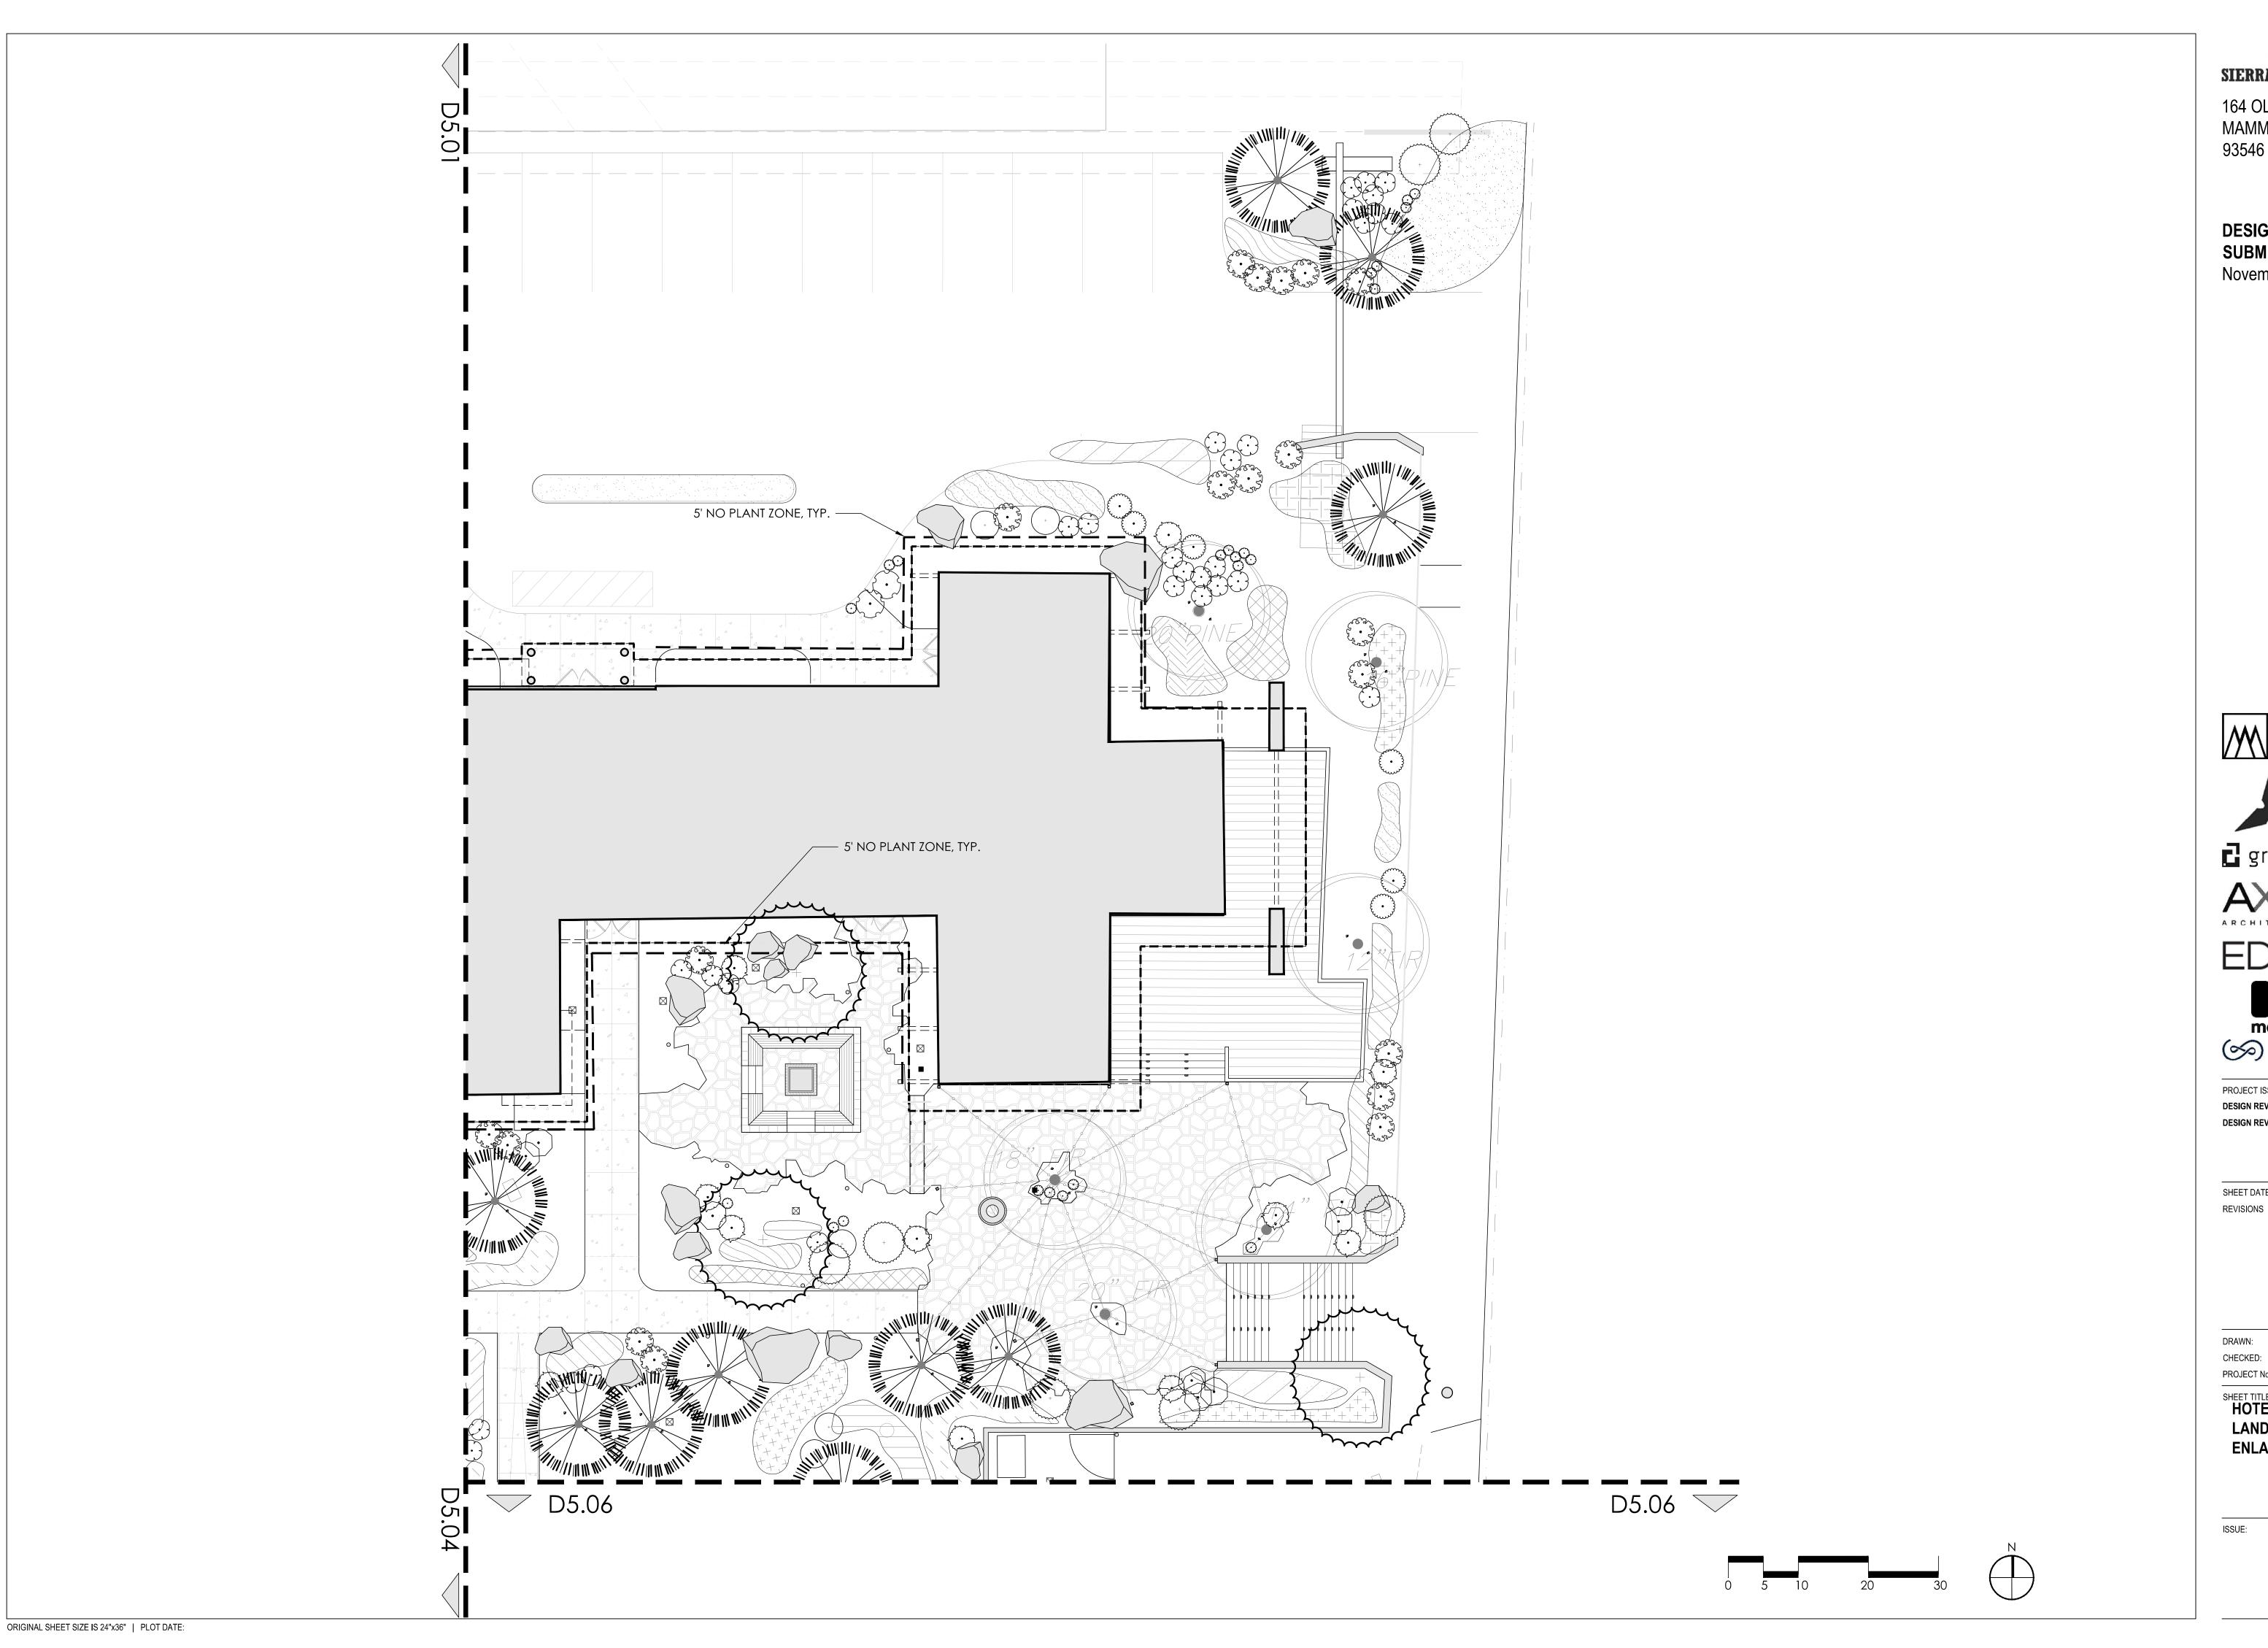



164 OLD MAMMOTH RD, MAMMOTH LAKES, CA 93546

DESIGN REVIEW SUBMITTAL November 17, 2021



PROJECT No.

DESIGN REVIEW SUBMITTAL


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DESIGN REVIEW RESUBMITTAL

SHEET TITLE:
HOTEL COURTYARD LANDSCAPE PLAN **ENLARGEMENT**

ISSUE: **DESIGN REVIEW SUBMITTAL**

D5.03

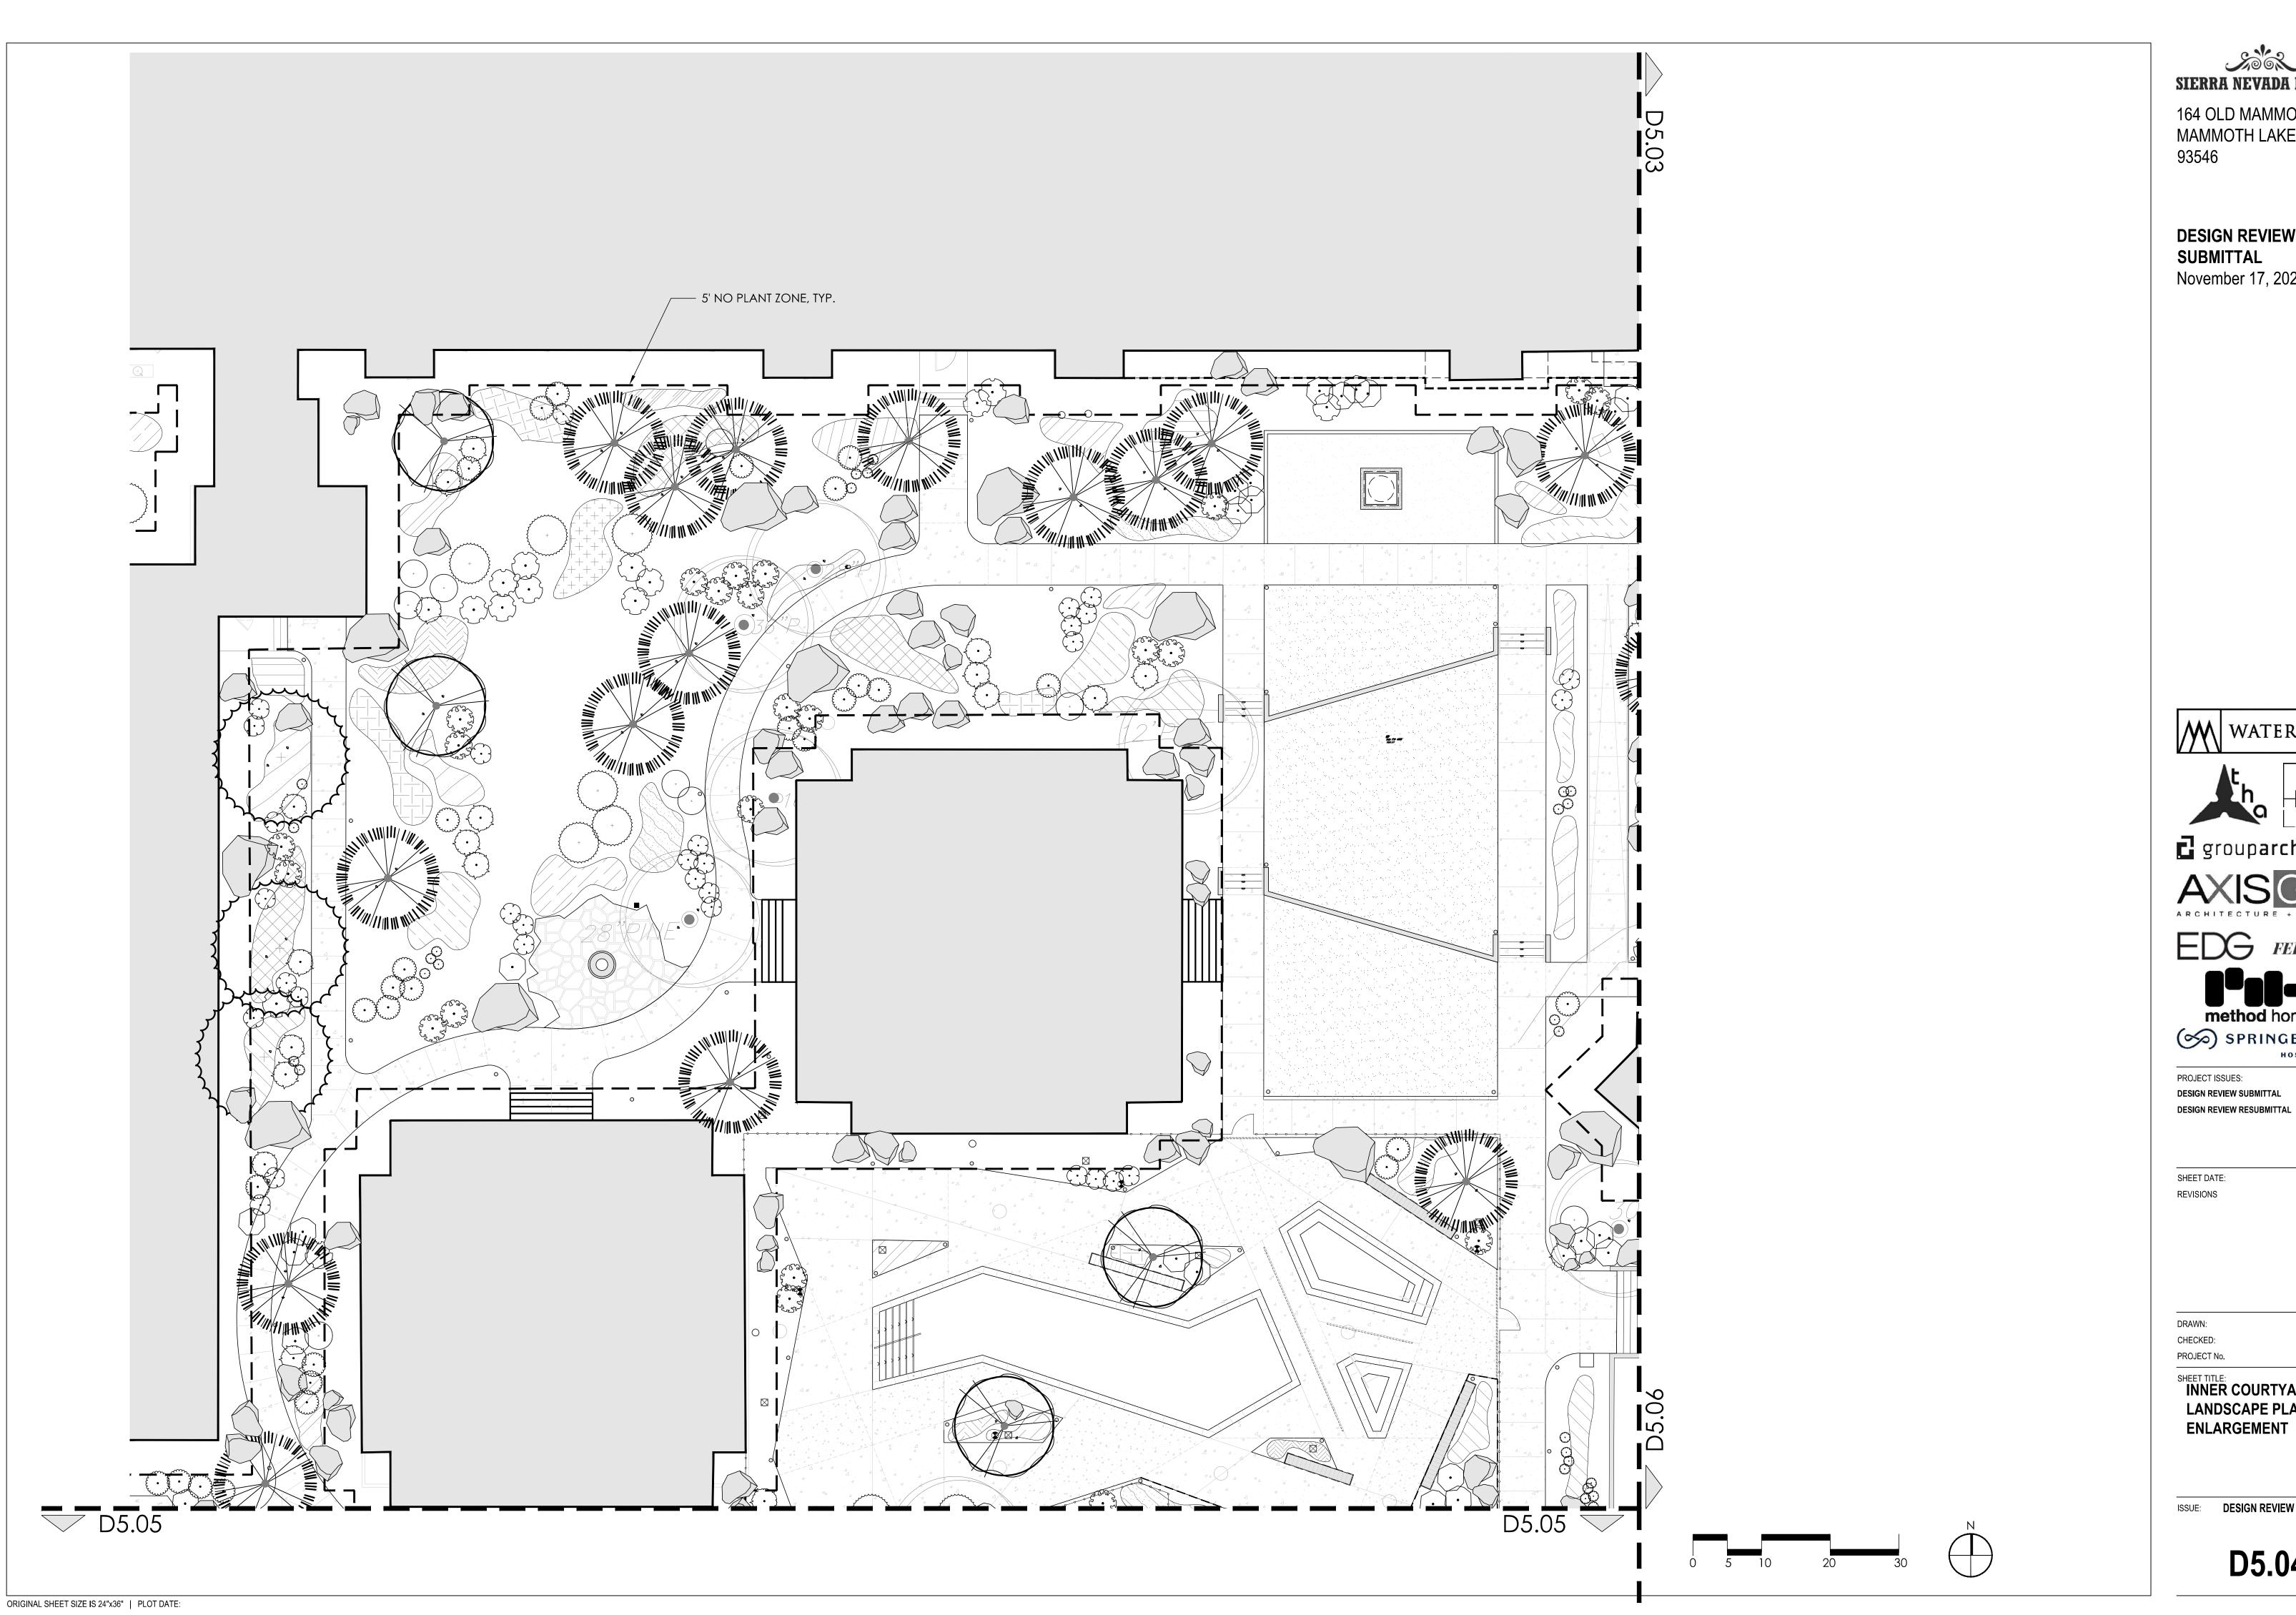

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HOSPITALITY PROJECT ISSUES:


SHEET DATE: REVISIONS

PROJECT No.

SHEET TITLE:
INNER COURTYARD LANDSCAPE PLAN **ENLARGEMENT**

ISSUE: **DESIGN REVIEW SUBMITTAL**

D5.04

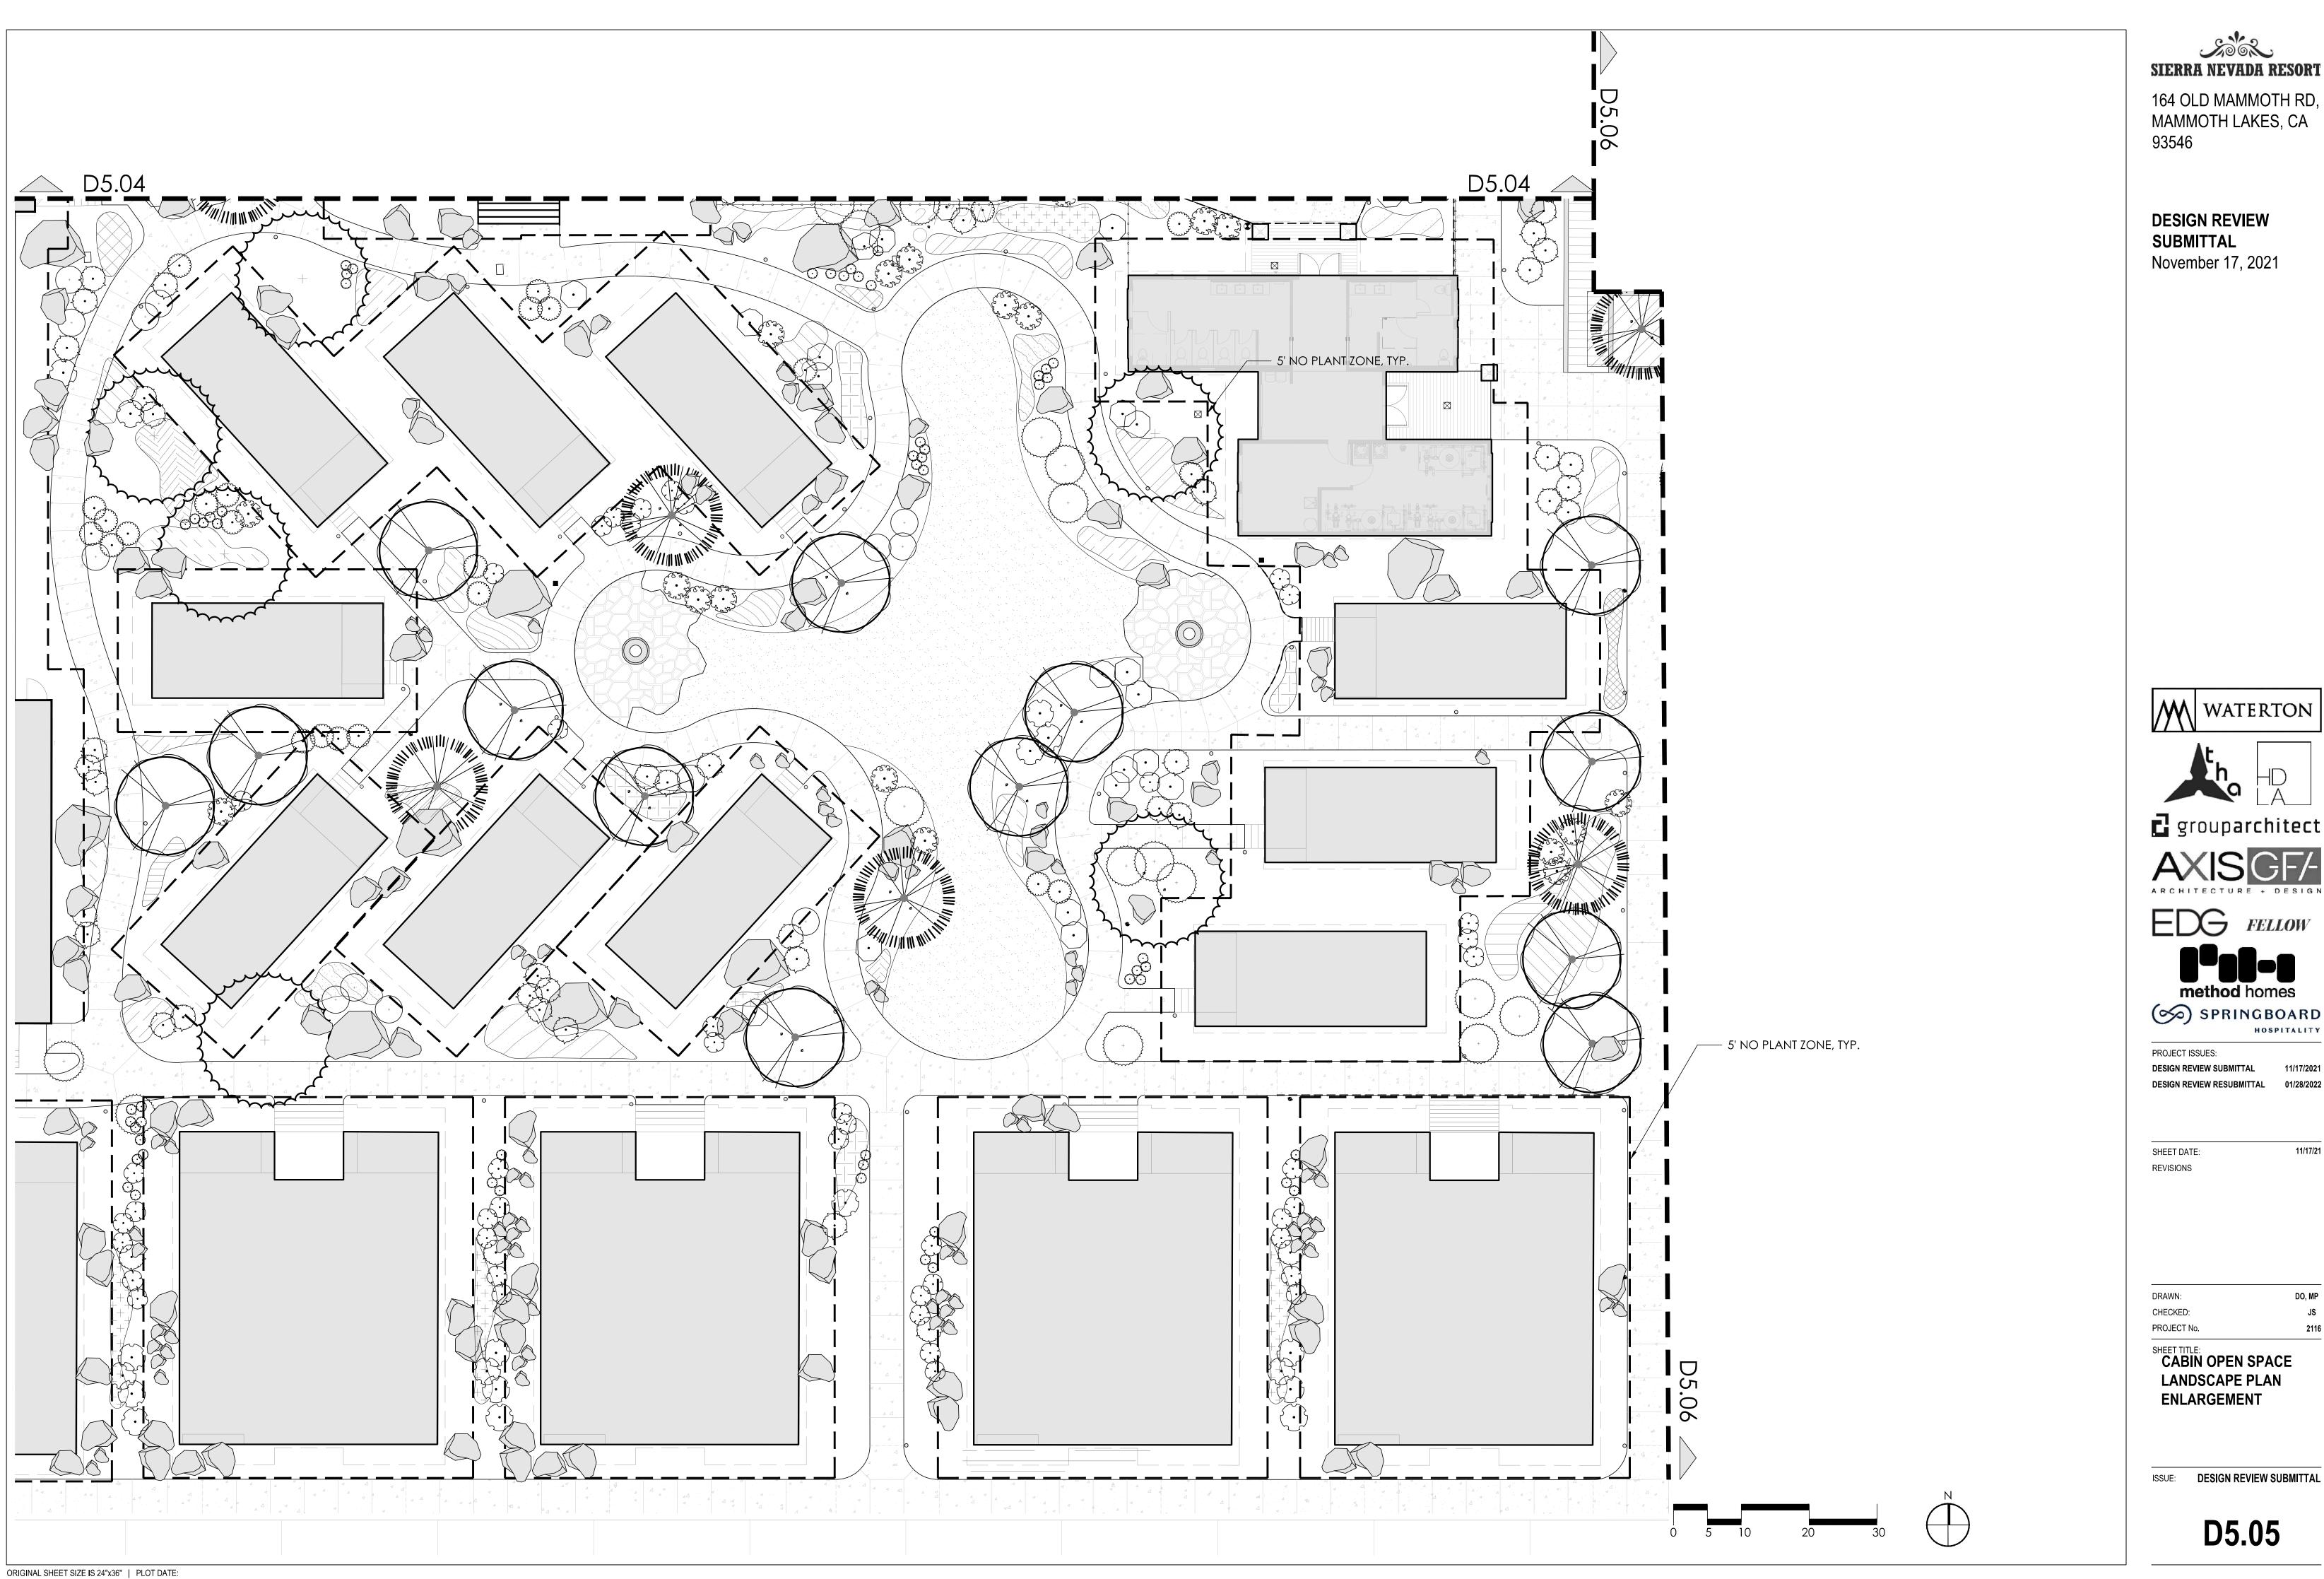

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HOSPITALITY



D5.06

SIERRA NEVADA RESORT

PLANTING NOTES

- 1. ALL EXISTING TREES TO BE REMOVED PER DEMOLITION PLAN SEE CIVIL PLANS. CONTRACTOR TO ACQUIRE TREE REMOVAL PERMIT PRIOR TO CONSTRUCTION.
- 2. TREAT ALL GROUNDCOVER BEDS WITH PRE-EMERGENT HERBICIDE PRIOR TO PLANTING. CONTRACTOR IS RESPONSIBLE FOR ALL WEEDING UNTIL FINAL ACCEPTANCE.
- 3. ALL PLANT BEDS TO BE NEATLY LAID IN WITH 3" DEEP TRENCH EDGING BORDER.
- 4. ALL GROUNDCOVER AND PLANT BEDS SHALL MEET LANDSCAPE ARCHITECT'S SPECIFICATIONS. FINAL GRADES FOR ALL PLANT BEDS SHALL BE 1" BELOW EDGE OF WALK OR CURBING SO THAT WHEN 3" OF MULCH IS ADDED THE MULCH WILL BE 2" ABOVE THE WALKS. TAPER MULCH DOWN TO EDGE OF WALK OR CURB.
- 5. ALL AREAS WITHIN PLANT BEDS TO BE MULCHED WITH 3" DEEP LAYER OF DECOMPOSED SHREDDED PINE BARK OR DECORATIVE COBBLE.
- 6. ALL TREES OF A SIMILAR SPECIES TO BE MATCHED IN SIZE AND UNIFORMITY. CONTRACTOR TO WARRANTY ALL PLANTINGS FOR A PERIOD OF ONE YEAR AFTER DATE OF FINAL ACCEPTANCE BY OWNER. WARRANTY TO INCLUDE ALL DEFECTS INCLUDING DEATH OR UNSATISFACTORY GROWTH; EXCEPT FOR DEFECTS RESULTING FROM LACK OF ADEQUATE MAINTENANCE, NEGLECT OR ABUSE BY OWNER, OR ABNORMAL WEATHER CONDITIONS UNUSUAL FOR
- 8. CONTRACTOR IS RESPONSIBLE FOR MAINTENANCE OF PLANTS UNTIL TIME OF FINAL ACCEPTANCE.
- 9. PROVIDE TREES, SHRUBS, AND PLANTS OF QUALITY, SIZE, GENUS, SPECIES AND VARIETY SHOWN AND SCHEDULED FOR LANDSCAPE WORK AND COMPLYING WITH RECOMMENDATIONS AND requirements of ansi z60.1 "american standard for nursery stock". Provide Healthy, Vigorous stock, Grown in a recognized nursery in accordance with good HORTICULTURAL PRACTICE AND FREE OF DISEASE, INSECTS, EGGS, LARVAE, AND DEFECTS SUCH AS KNOTS, SUN-SCALD, INJURIES, ABRASIONS OR DISFIGUREMENT. HEIGHT AND WIDTH SHOWN ARE MINIMUM SIZES.
- 10. DO NOT MAKE SUBSTITUTIONS. IF SPECIFIED LANDSCAPE MATERIAL IS NOT OBTAINABLE, SUBMIT PROOF OF NON-AVAILABILITY FROM A MINIMUM OF 6 SUPPLIERS TO LANDSCAPE ARCHITECT, TOGETHER WITH A PROPOSAL FOR USE OF EQUIVALENT MATERIAL PRIOR TO FINAL BID DATE.
- 11. SUBMIT TYPEWRITTEN INSTRUCTIONS RECOMMENDING PROCEDURES TO BE ESTABLISHED BY OWNER FOR MAINTENANCE OF LANDSCAPE WORK FOR ONE FULL YEAR; SUBMIT PRIOR TO EXPIRATION OF REQUIRED MAINTENANCE PERIOD.
- 12. DELIVER PACKAGED MATERIALS IN CONTAINERS SHOWING WEIGHT, ANALYSIS, AND NAME OF MANUFACTURER. PROTECT MATERIALS FROM DETERIORATION DURING DELIVERY AND WHILE
- 13. DELIVER TREES AND SHRUBS AFTER PREPARATIONS FOR PLANTING HAS BEEN COMPLETED AND PLANT IMMEDIATELY. IF PLANTING IS DELAYED MORE THAN 6 HOURS AFTER DELIVERY, SET TREES AND SHRUBS IN SHADE, PROTECT FROM WEATHER AND MECHANICAL DAMAGE, AND KEEP ROOTS MOIST BY COVERING WITH MULCH, BURLAP, OR OTHER ACCEPTABLE MEANS OF RETAINING
- 14. DETERMINE LOCATION OF UNDERGROUND UTILITIES AND PERFORM WORK IN A MANNER WHICH WILL AVOID POSSIBLE DAMAGE. HAND EXCAVATE AS REQUIRED. MAINTAIN GRADE STAKES SET BY OTHERS UNTIL REMOVAL IS MUTUALLY AGREED UPON BY PARTIES CONCERNED.
- 15. PROVIDE 12" OF NEW TOPSOIL TO ALL PLANTING AREAS PER LANDSCAPE ARCHITECT'S SPECIFICATIONS. OBTAIN TOPSOIL FROM SOURCES LISTED IN SPECIFICATIONS.
- 16. BEGIN MAINTENANCE IMMEDIATELY AFTER PLANTING. MAINTAIN TREES, SHRUBS, AND OTHER PLANTINGS BY PRUNING, WATERING, CULTIVATING AND WEEDING AS REQUIRED FOR HEALTHY GROWTH. RESTORE PLANTING SAUCERS. RESET TREES AND SHRUBS TO PROPER GRADES OR VERTICAL POSITION AS REQUIRED. SPRAY AS REQUIRED TO KEEP TREES AND SHRUBS FREE OF INSECTS AND DISEASE. MAINTAIN LAWN BY WATERING, FERTILIZING, WEEDING, MOWING, TRIMMING, AND OTHER OPERATIONS SUCH AS ROLLING, REGRADING, AND REPLANTING AS REQUIRED TO ESTABLISH A SMOOTH, ACCEPTABLE LAWN, FREE OF ERODED OR BARE AREAS.
- 17. WHERE INSPECTED LANDSCAPE WORK DOES NOT COMPLY WITH REQUIREMENTS, REPLACE REJECTED WORK AND CONTINUE SPECIFIED MAINTENANCE UNTIL REINSPECTED BY LANDSCAPE
- ARCHITECT AND FOUND TO BE ACCEPTABLE. REMOVE REJECTED PLANTS PROMPTLY FROM PROJECT SITE. 18. ANY AND ALL QUANTITIES INDICATED ON THE PLANT SCHEDULE AND PLAN ARE PROVIDED FOR THE CONVENIENCE OF THE CONTRACTOR. THE CONTRACTOR SHALL BE RESPONSIBLE FOR HIS/HER OWN QUANTITY CALCULATION AND THE LIABILITY WHICH PERTAINS TO THOSE QUOTATIONS. ANY DISCREPANCY SHALL BE CALLED TO THE ATTENTION OF THE LANDSCAPE ARCHITECT
- 19. LOCATIONS OF ALL PLANT BEDS AND TREES TO BE STAKED AND APPROVED BY LANDSCAPE ARCHITECT PRIOR TO PLANTING.
- 20. SCARIFY ALL TREE PITS BEFORE PLANTING. VERIFY THAT ALL TREE PITS ADEQUATELY DRAIN BEFORE PLANTING TREES.
- 21. IF ROCK IS ENCOUNTERED, CONTRACTOR TO REMOVE ROCK AND PROVIDE DRAINAGE AWAY FROM EACH TREE PIT.
- 22. SHRUBS AND GROUNDCOVER BEDS TO BE PLANTED IN A TRIANGULAR SPACING. SEE PLANTING SCHEDULE FOR DISTANCES.
- 23. PROVIDE TRUE RADII FOR THE LAYOUT OF ALL PLANT BEDS.
- 24. REFER TO PROJECT MANUAL REGARDING TREE FERTILIZATION AND PRUNING.
- 25. ALL LANDSCAPE AREAS TO BE IRRIGATED WITH FULLY AUTOMATED IRRIGATION SYSTEM. REFER TO L6.00 SERIES
- 26. DO NOT WILLFULLY PROCEED WITH PLANTING OPERATIONS AS DESIGNED WHEN IT IS OBVIOUS THAT UNKNOWN OBSTRUCTIONS AND/OR GRADE DIFFERENCES EXIST THAT MAY NOT HAVE BEEN known during the design process. Such conditions shall be immediately brought to the attention of the owner authorized representative. The contractor shall assume FULL RESPONSIBILITY FOR ALL NECESSARY REVISIONS DUE TO THE FAILURE TO GIVE SUCH NOTIFICATION PRIOR TO BEGINNING WORK.
- 27. THE CONTRACTOR SHALL BE RESPONSIBLE FOR ANY COORDINATION WITH SUBCONTRACTORS AS REQUIRED TO ACCOMPLISH PLANTING OPERATIONS. 28. TREE LOCATIONS SHOWN ON PLAN MAY REQUIRE ADJUSTMENT IN THE FIELD. WHENEVER FEASIBLE, TREES SHOULD BE PLANTED A MINIMUM OF TEN (10) FEET FROM ALL UNDERGROUND UTILITIES
- AND OUT OF DRAINAGE FLOW LINES AND THREE (3) FEET FROM SPRAY HEADS. SHOULD THIS NOT BE POSSIBLE, CONTACT THE LANDSCAPE ARCHITECT FOR A DECISION ON TREE PLACEMENT.
- 29. INSTALL ROOT BARRIER IF CENTER OF TREE TRUNK IS WITHIN 5' OF ANY CURBS OR SIDEWALKS.
- 30. DO NOT PLANT ON TOP OF TREE ROOTBALLS UNLESS DIRECTED BY LANDSCAPE ARCHITECT. 31. CONTRACTOR SHALL SUBMIT FOR APPROVAL, PHOTOS OF ALL BOXED TREES AND SHRUB, AND VINES. SEE SPECIFICATIONS FOR FURTHER DETAIL.
- 32. LANDSCAPE ARCHITECT SHALL HAVE THE OPPORTUNITY TO INSPECT ALL PLANT MATERIALS AT THE JOB SITE PRIOR TO PLANTING.
- 33. UPON COMPLETION OF PLANTING, THE CONTRACTOR SHALL ARRANGE FOR A SUBSTANTIAL COMPLETION INSPECTION BY THE LANDSCAPE ARCHITECT. CONTRACTOR SHALL CORRECT ANY DISCREPANCIES FOUND PRIOR TO FINAL INSPECTION AND ACCEPTANCE OF THE PROJECT.
- 34. LANDSCAPE CONTRACTOR SHALL FIELD VERIFY LOCATION OF POWER POLE/LIGHT POLE AND WIRES PRIOR TO PLACEMENT OF TREES TO AVOID CONFLICT. TREES MUST BE A MINIMUM 15' DISTANCE FROM POWER POLE/LIGHT POLE. ONLY UNDERSTORY TREES ARE PERMITTED UNDER POWERLINES.
- 35. NO TREES OR LARGE SHRUBS SHALL BE PLANTED IN EASEMENT ON SITE.


PLANTING SCHEDULE NOTES


- TREES TO BE OF THE HIGHEST GRADE AND PURCHASED FROM THESE SELECTED VENDORS ONLY:
- SELECT TREES
- CRAWFORD, GA (706)743-5124
- BOLD SPRINGS NURSERY
- HAWKINSVILLE, GA (478)783-4975
- SHADY GROVE PLANTATION AND NURSERY ORANGEBURG, SC - (803)534-5683
- WATKINS NURSERIES
- MIDLOTHIAN, VA. (804)379-8733
- HUNTER TREES NURSERY, LLC. BIRMINGHAM, AL - (866)348-6837
- HAWKERSMITH NURSERY
- TULLAHOMA, TN (931)455-5436
- SOUTHEASTERN GROWERS, INC.
- WATKINSVILLE, GA (706)310-1151
- PLANTATION TREE CO. SELMA, AL - (334)875-9176
- 2. IF TREES ARE NOT AVAILABLE AT THE INDICATED NURSERIES, CONTRACTOR TO SUBMIT ALTERNATIVE NURSERIES. ALL TREES OBTAINED AT LISTED NURSERIES MUST MEET ALL OF THE SPECIFICATIONS REQUIRED


SOILS ANALYSIS NOTE


- PRIOR TO PLANTING, PERFORM AGRONOMIC SOIL TESTING AND SOIL AMENDMENTS PER RECOMMENDATION BY SOIL LABORATORIES; REFER TO NOTES BELOW AND SPECIFICATIONS. THE CONTRACTOR SHALL HAVE SOIL SAMPLES TAKEN FROM (3) AREAS WITHIN THE WHOLE SITE - TRINITY STREETSCAPE, BUILDING COURTYARDS AND POOL AMENITY AREA.
- THE SAMPLES SHALL BE TESTED BY A LICENSED SOILS LABORATORY, FOR SOIL FERTILITY, AGRICULTURAL SUITABILITY, N-P-K, PH, EC, SOIL TEXTURE (SILT, CLAY, SAND) AND SOIL PREPARATION RECOMMENDATIONS. THE RESULTS AND RECOMMENDATIONS OF THE SOIL TESTING LABORATORY SHALL BE SUBMITTED TO AND APPROVED BY THE OWNER AND LANDSCAPE ARCHITECT. THE APPROVED RECOMMENDATIONS FOR AMENDMENTS AND BACKFILL SHALL BECOME PART OF THE LANDSCAPE PLANS AND INCORPORATED INTO THE LANDSCAPE PLANTING AREAS PRIOR TO INSTALLATION OF PLANT MATERIALS.




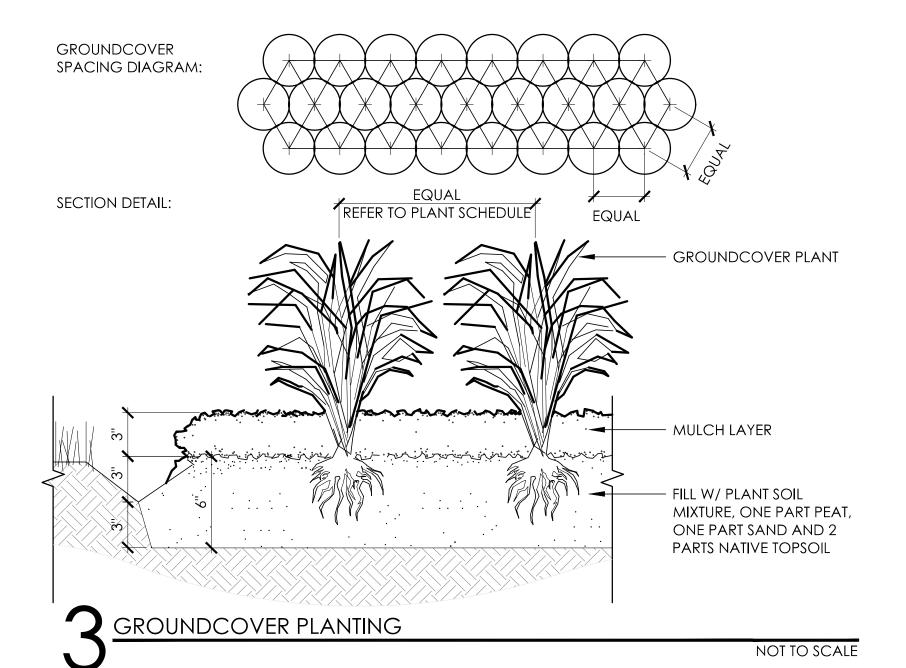

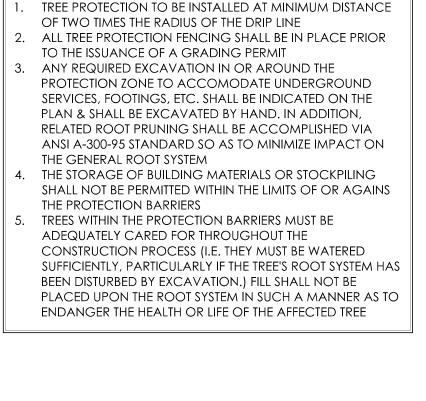


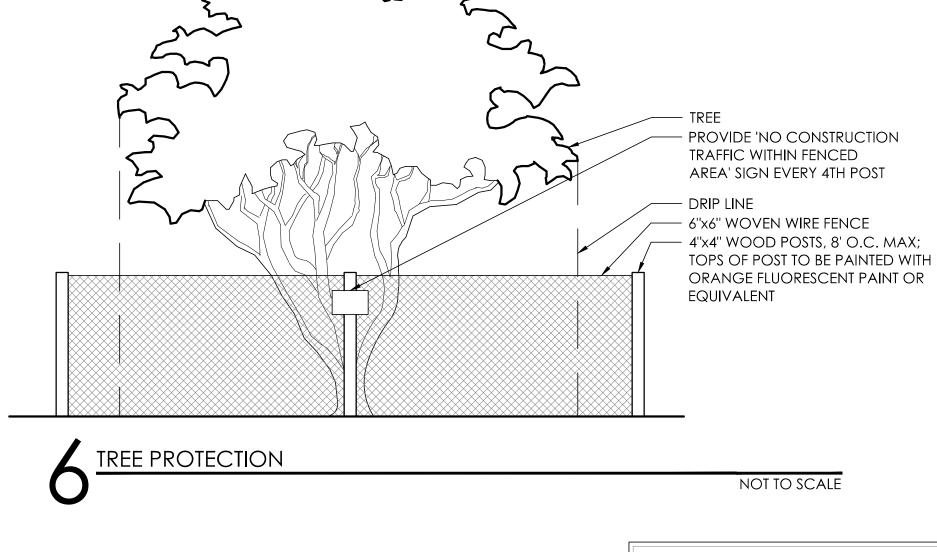


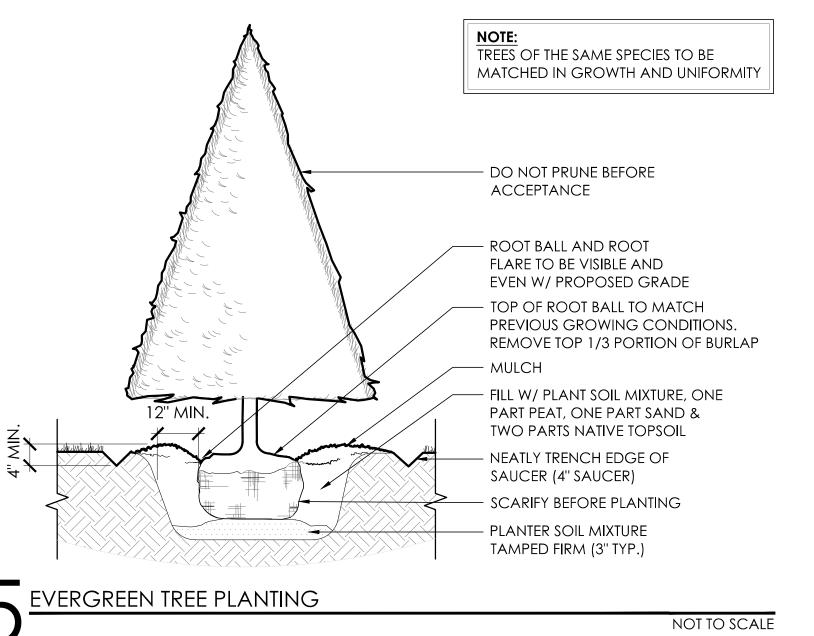

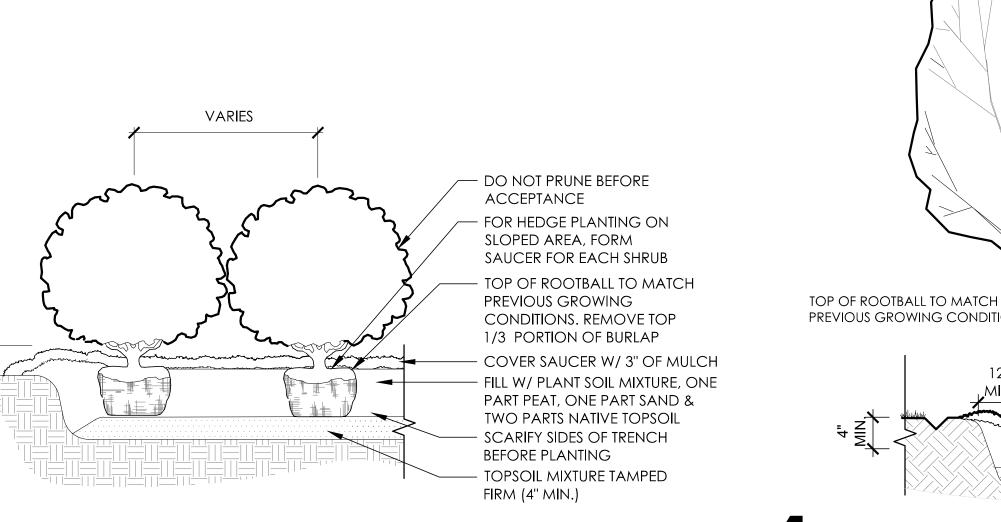

SHRUB PLANTING

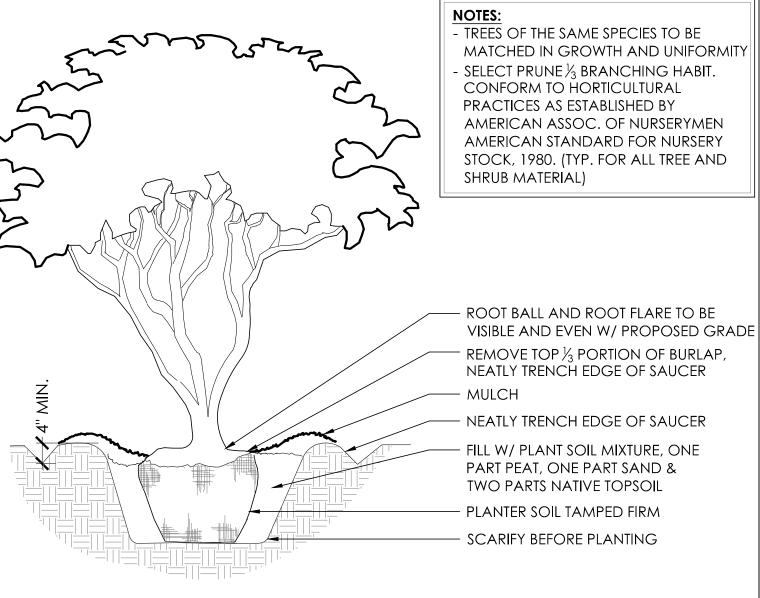

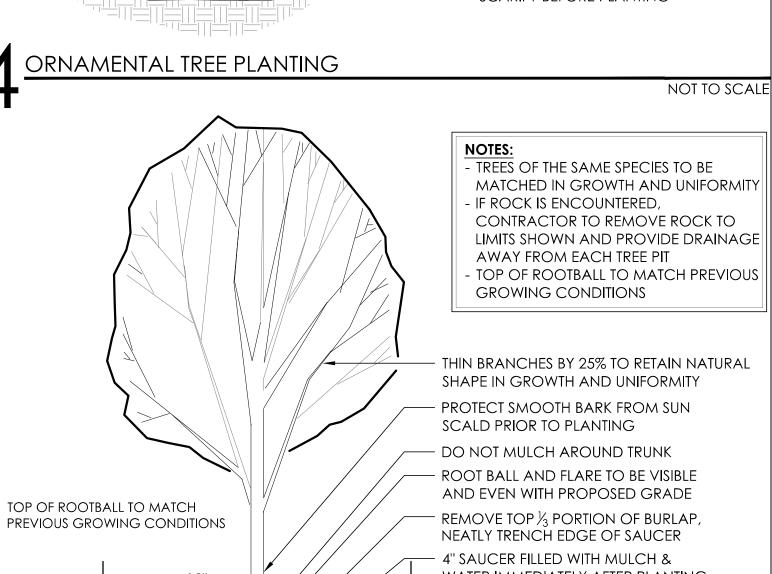

TREE PLANTING

NOT TO SCALE

TWO PARTS NATIVE TOPSOIL

SCARIFY BEFORE PLANTING

PLANTER SOIL MIXTURE TAMPED FIRM (3" TYP.)

CHECKED: PROJECT No. PLANTING DETAILS AND NOTES WATER IMMEDIATELY AFTER PLANTING FILL W/ PLANT SOIL MIXTURE, ONE PART PEAT, ONE PART SAND &

NOT TO SCALE

DESIGN REVIEW SUBMITTAL

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(∞) SPRINGBOARD

11/17/21

DO, MP

PROJECT ISSUES:

SHEET DATE:

REVISIONS

DESIGN REVIEW SUBMITTAL

DESIGN REVIEW RESUBMITTAL

D5.07

ORIGINAL SHEET SIZE IS 24"x36" | PLOT DATE:

SIERRA NEVADA RESORT

164 OLD MAMMOTH RD,

MAMMOTH LAKES, CA

DESIGN REVIEW

November 17, 2021

SUBMITTAL

93546

TREES	BOTANICAL NAME	COMMON NAME	CONT/ CAL.	HEIGHT	SPREAD	SPACING	REMARKS
AG	Acer ginnala	Amur Maple	B&B - 2"	8`- 10`	4' - 6'	As shown	FULL CROWN, MATCHED, STRONG CENTRAL LEADER
ا ر	Pinus jeffreyi	Jeffrey Pine	B&B - 3"	12`- 14`	6' - 8'	As shown	DENSE FOLIAGE, MATCHED, STRONG CENTRAL LEADER
^P M	Pseudotsuga macrocarpa	Bigcone Douglas Fir	B&B - 2.5"	12`- 14`	6' - 8'	As shown	DENSE FOLIAGE, MATCHED, STRONG CENTRAL LEADER
	T	T		T	1		T
SHRUBS	BOTANICAL NAME	COMMON NAME		HEIGHT	SPREAD	SPACING	
AM	Aronia melanocarpa	Black Chokeberry		36"	36"	36" o.c.	MATCHED, FULL TO GROUND
	Forsythia x intermedia	Border Forsythia		24"	24"	36" o.c.	MATCHED, FULL TO GROUND
V	llex vomitoria	Yaupon Holly		36"	48"	72" o.c.	MATCHED, FULL TO GROUND
<u>'S</u>	Pinus mugo 'Slowmound'	Slowmound Mugo Pine		18"	18"	18" o.c.	MATCHED, FULL TO GROUND
PT	Purshia tridentata	Antelope Bitterbrush		36"	36"	36" o.c.	MATCHED, FULL TO GROUND
RT	Rhus trilobata	Skunkbush Sumac		48''	48''	48" o.c.	MATCHED, FULL TO GROUND
?A	Ribes aureum	Golden Currant		42"	42"	42" o.c.	MATCHED, FULL TO GROUND
R	Rosa rugosa	Rugosa Rose		48"	48"	48" o.c.	MATCHED, FULL TO GROUND
SV	Syringa vulgaris	Common Lilac		48"	48"	48" o.c.	MATCHED, FULL TO GROUND
GROUND COVERS	BOTANICAL NAME	COMMON NAME		HEIGHT	SPREAD	SPACING	
	Arctostaphylos uva-ursi	Kinnikinnick		12"	24"	24" o.c.	FULL, DENSELY ROOTED
BA	Berberis aquifolium 'Compacta'	Compact Oregon Grape		24"	24"	24" o.c.	FULL, DENSELY ROOTED
 CH	Cotoneaster horizontalis	Rockspray Cotoneaster		18"	24"	24" o.c.	FULL, DENSELY ROOTED
RG	Rhus aromatica 'Gro-Low'	Gro-Low Fragrant Sumac		18"	24"	24" o.c.	FULL, DENSELY ROOTED
GRASSES	BOTANICAL NAME	COMMON NAME		HEIGHT	SPREAD	SPACING	
3B	Bouteloua gracilis 'Blonde Ambition'	Blonde Ambition Blue Grama		18"	18"	18" o.c.	FULL, DENSELY ROOTED
1C	Hesperostipa comata	Needle and Thread Bunchgrass		24"	24"	24" o.c.	FULL, DENSELY ROOTED
SL	Schizachyrium scoparium	Little Bluestem		36"	24"	24" o.c.	FULL, DENSELY ROOTED
,	SCHIZACHYHOTH SCOPAHOTH	Limo bioesterri				21 0.0.	TOLL, BENGELT ROOTEB
PERENNIALS	BOTANICAL NAME	COMMON NAME		HEIGHT	SPREAD	SPACING	
AC	Agastache cana	Texas Hummingbird Mint		18"	18"	18" o.c.	FULL, DENSELY ROOTED
 \L	Aquilegia canadensis 'Little Lanterns'	Little Lanterns Eastern Columbine		12"	12"	12" o.c.	FULL, DENSELY ROOTED
۸V	Aquilegia vulgaris	European Columbine		18"	18"	18" o.c.	FULL, DENSELY ROOTED
DG	Coreopsis grandiflora	Tickseed		18"	18"	18" o.c.	FULL, DENSELY ROOTED
S	Eriogonum umbellatum	Sulfurflower Buckwheat		12"	12"	12" o.c.	FULL, DENSELY ROOTED
 C	Eschscholzia californica	California Poppy		18"	18"	18" o.c.	FULL, DENSELY ROOTED
MO	Monardella odoratissima	Mountain Coyote Mint		18"	18"	18" o.c.	FULL, DENSELY ROOTED
TURF	BOTANICAL NAME	COMMON NAME		HEIGHT	SPREAD	SPACING	
TS	Turf Sod	Drought Tolerant Fescue Blend		SOD			FULL, DENSELY ROOTED



164 OLD MAMMOTH RD, MAMMOTH LAKES, CA 93546

DESIGN REVIEW SUBMITTAL November 17, 2021



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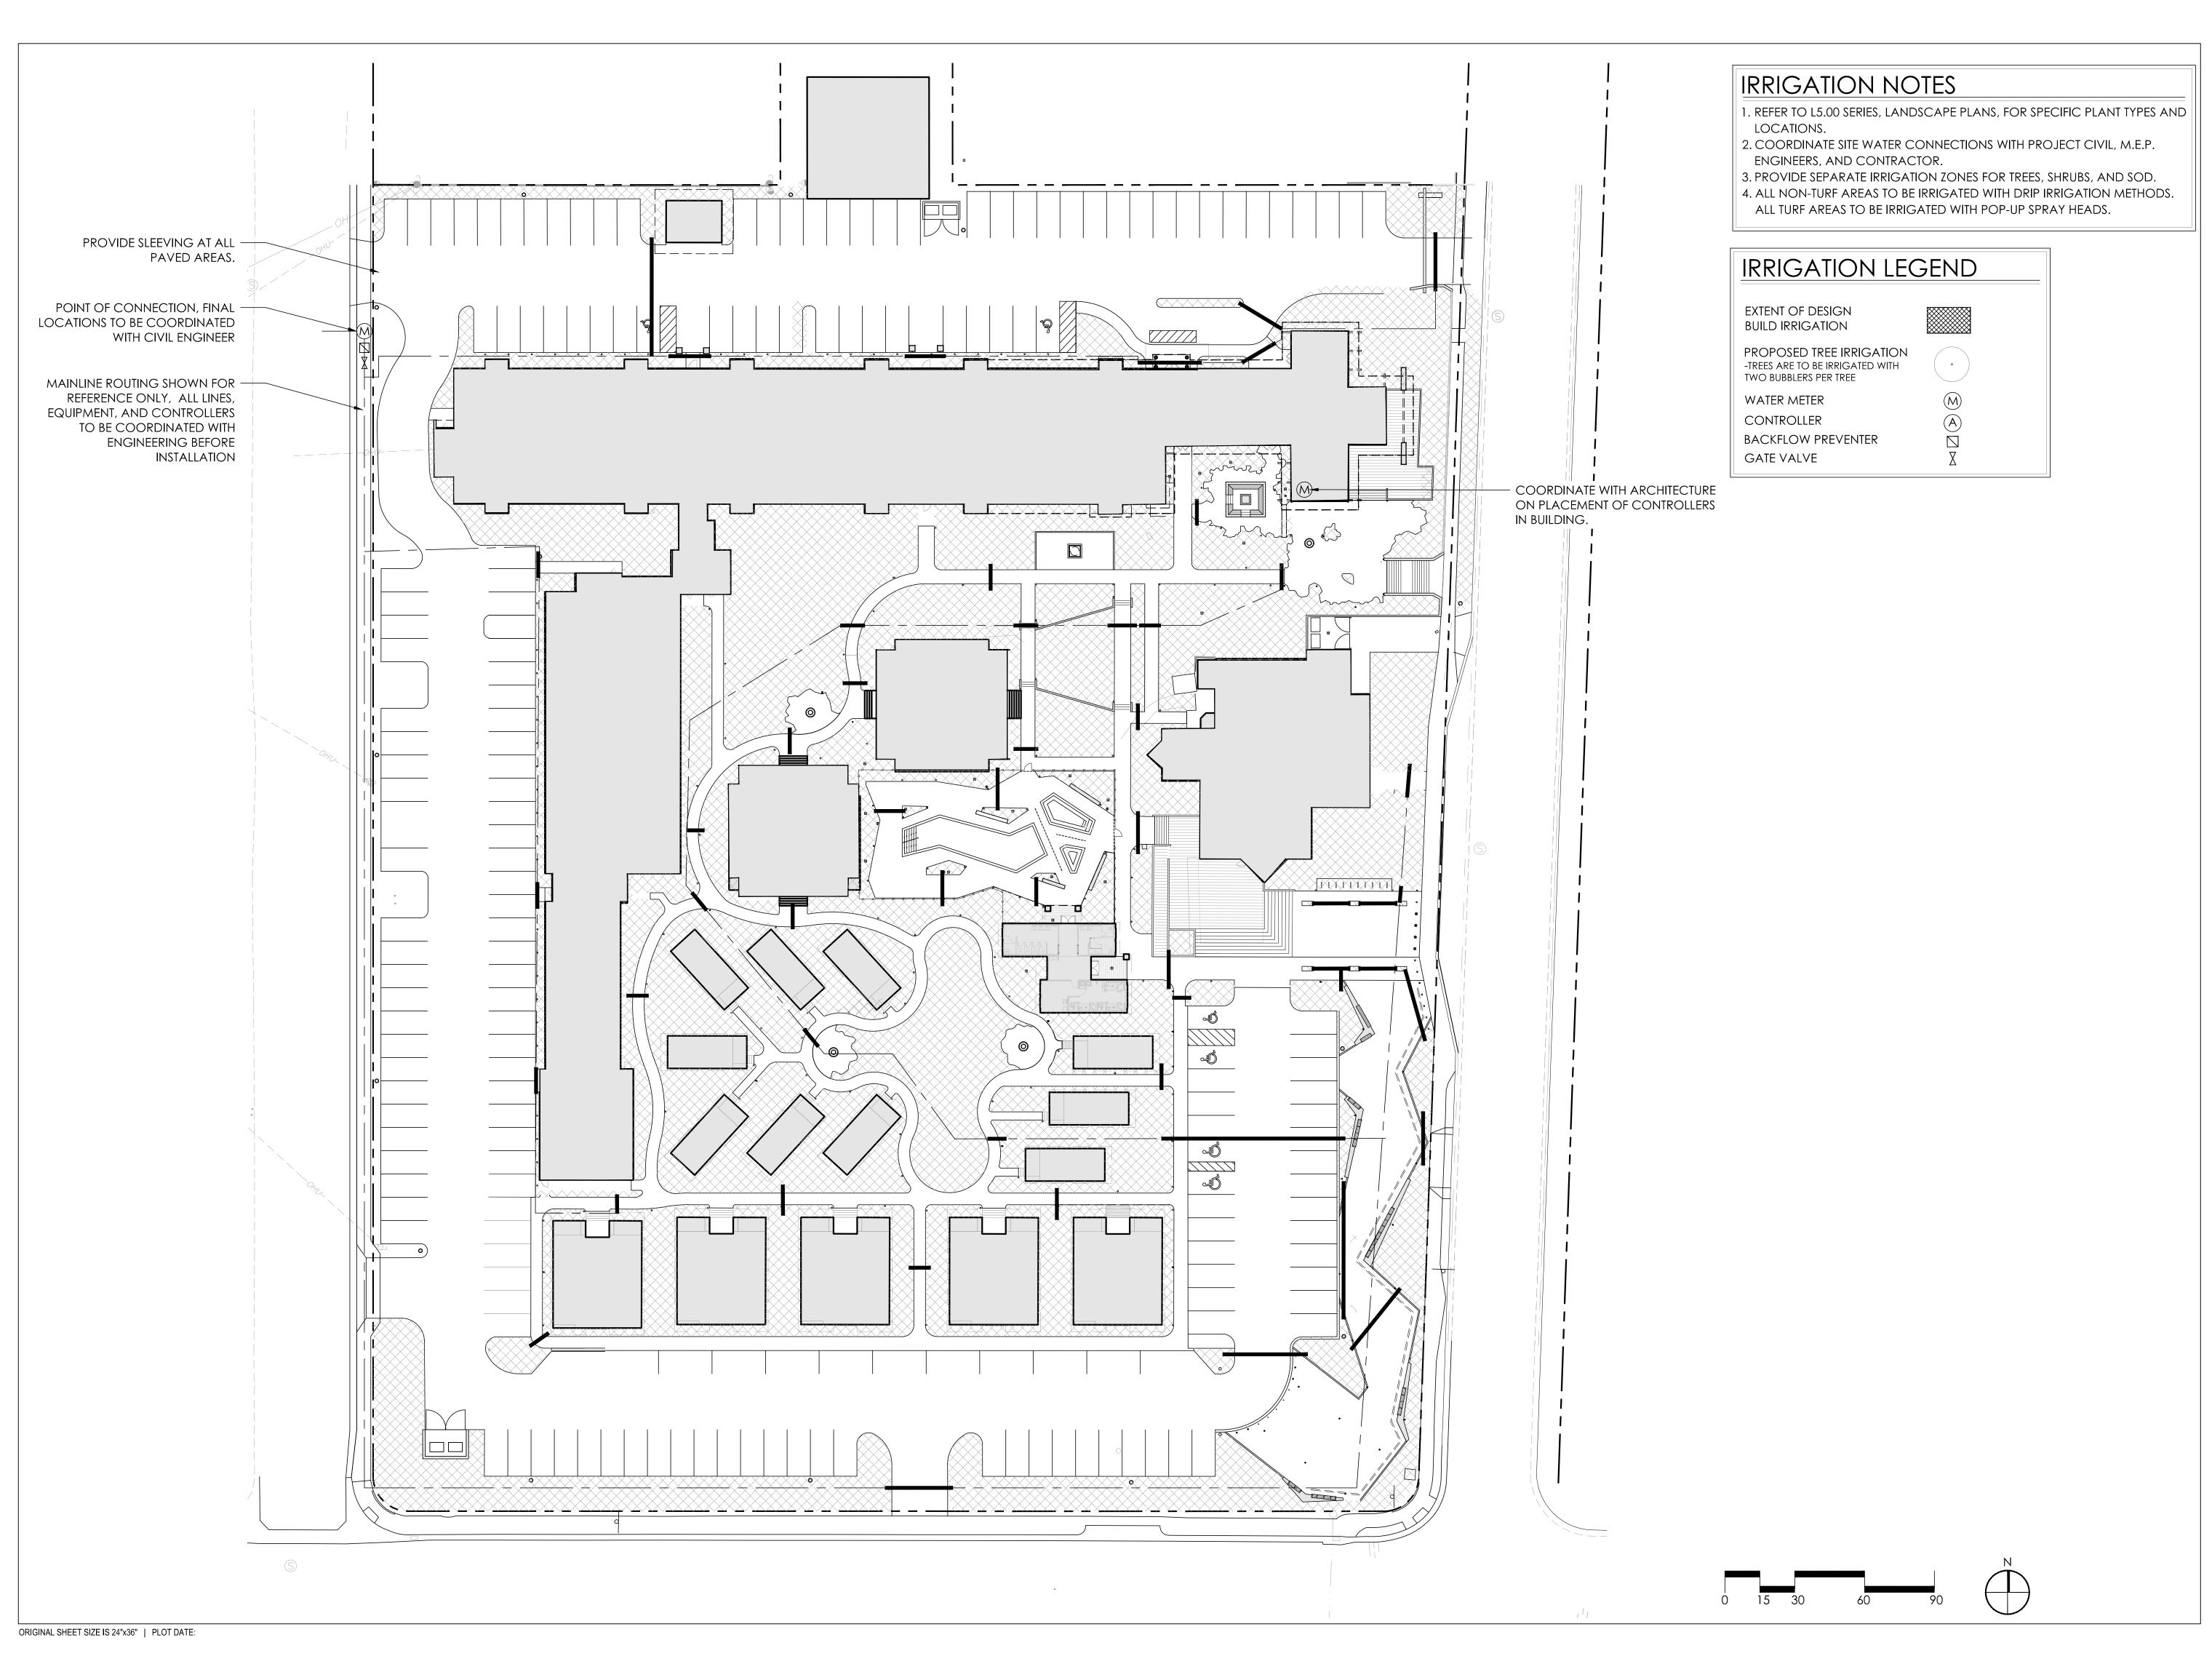
SHEET DATE: REVISIONS

DRAWN: DC
CHECKED:
PROJECT No.

SHEET TITLE: PLANTING SCHEDULE

ISSUE: **DESIGN REVIEW SUBMITTAL**

D5.08





164 OLD MAMMOTH RD, MAMMOTH LAKES, CA 93546

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November 17, 2021

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 SPRINGBOARD PROJECT ISSUES:

DESIGN REVIEW SUBMITTAL DESIGN REVIEW RESUBMITTAL


SHEET DATE: REVISIONS

CHECKED: PROJECT No.

OVERALL EXTENT OF IRRIGATION

ISSUE: DESIGN REVIEW SUBMITTAL

D6.00

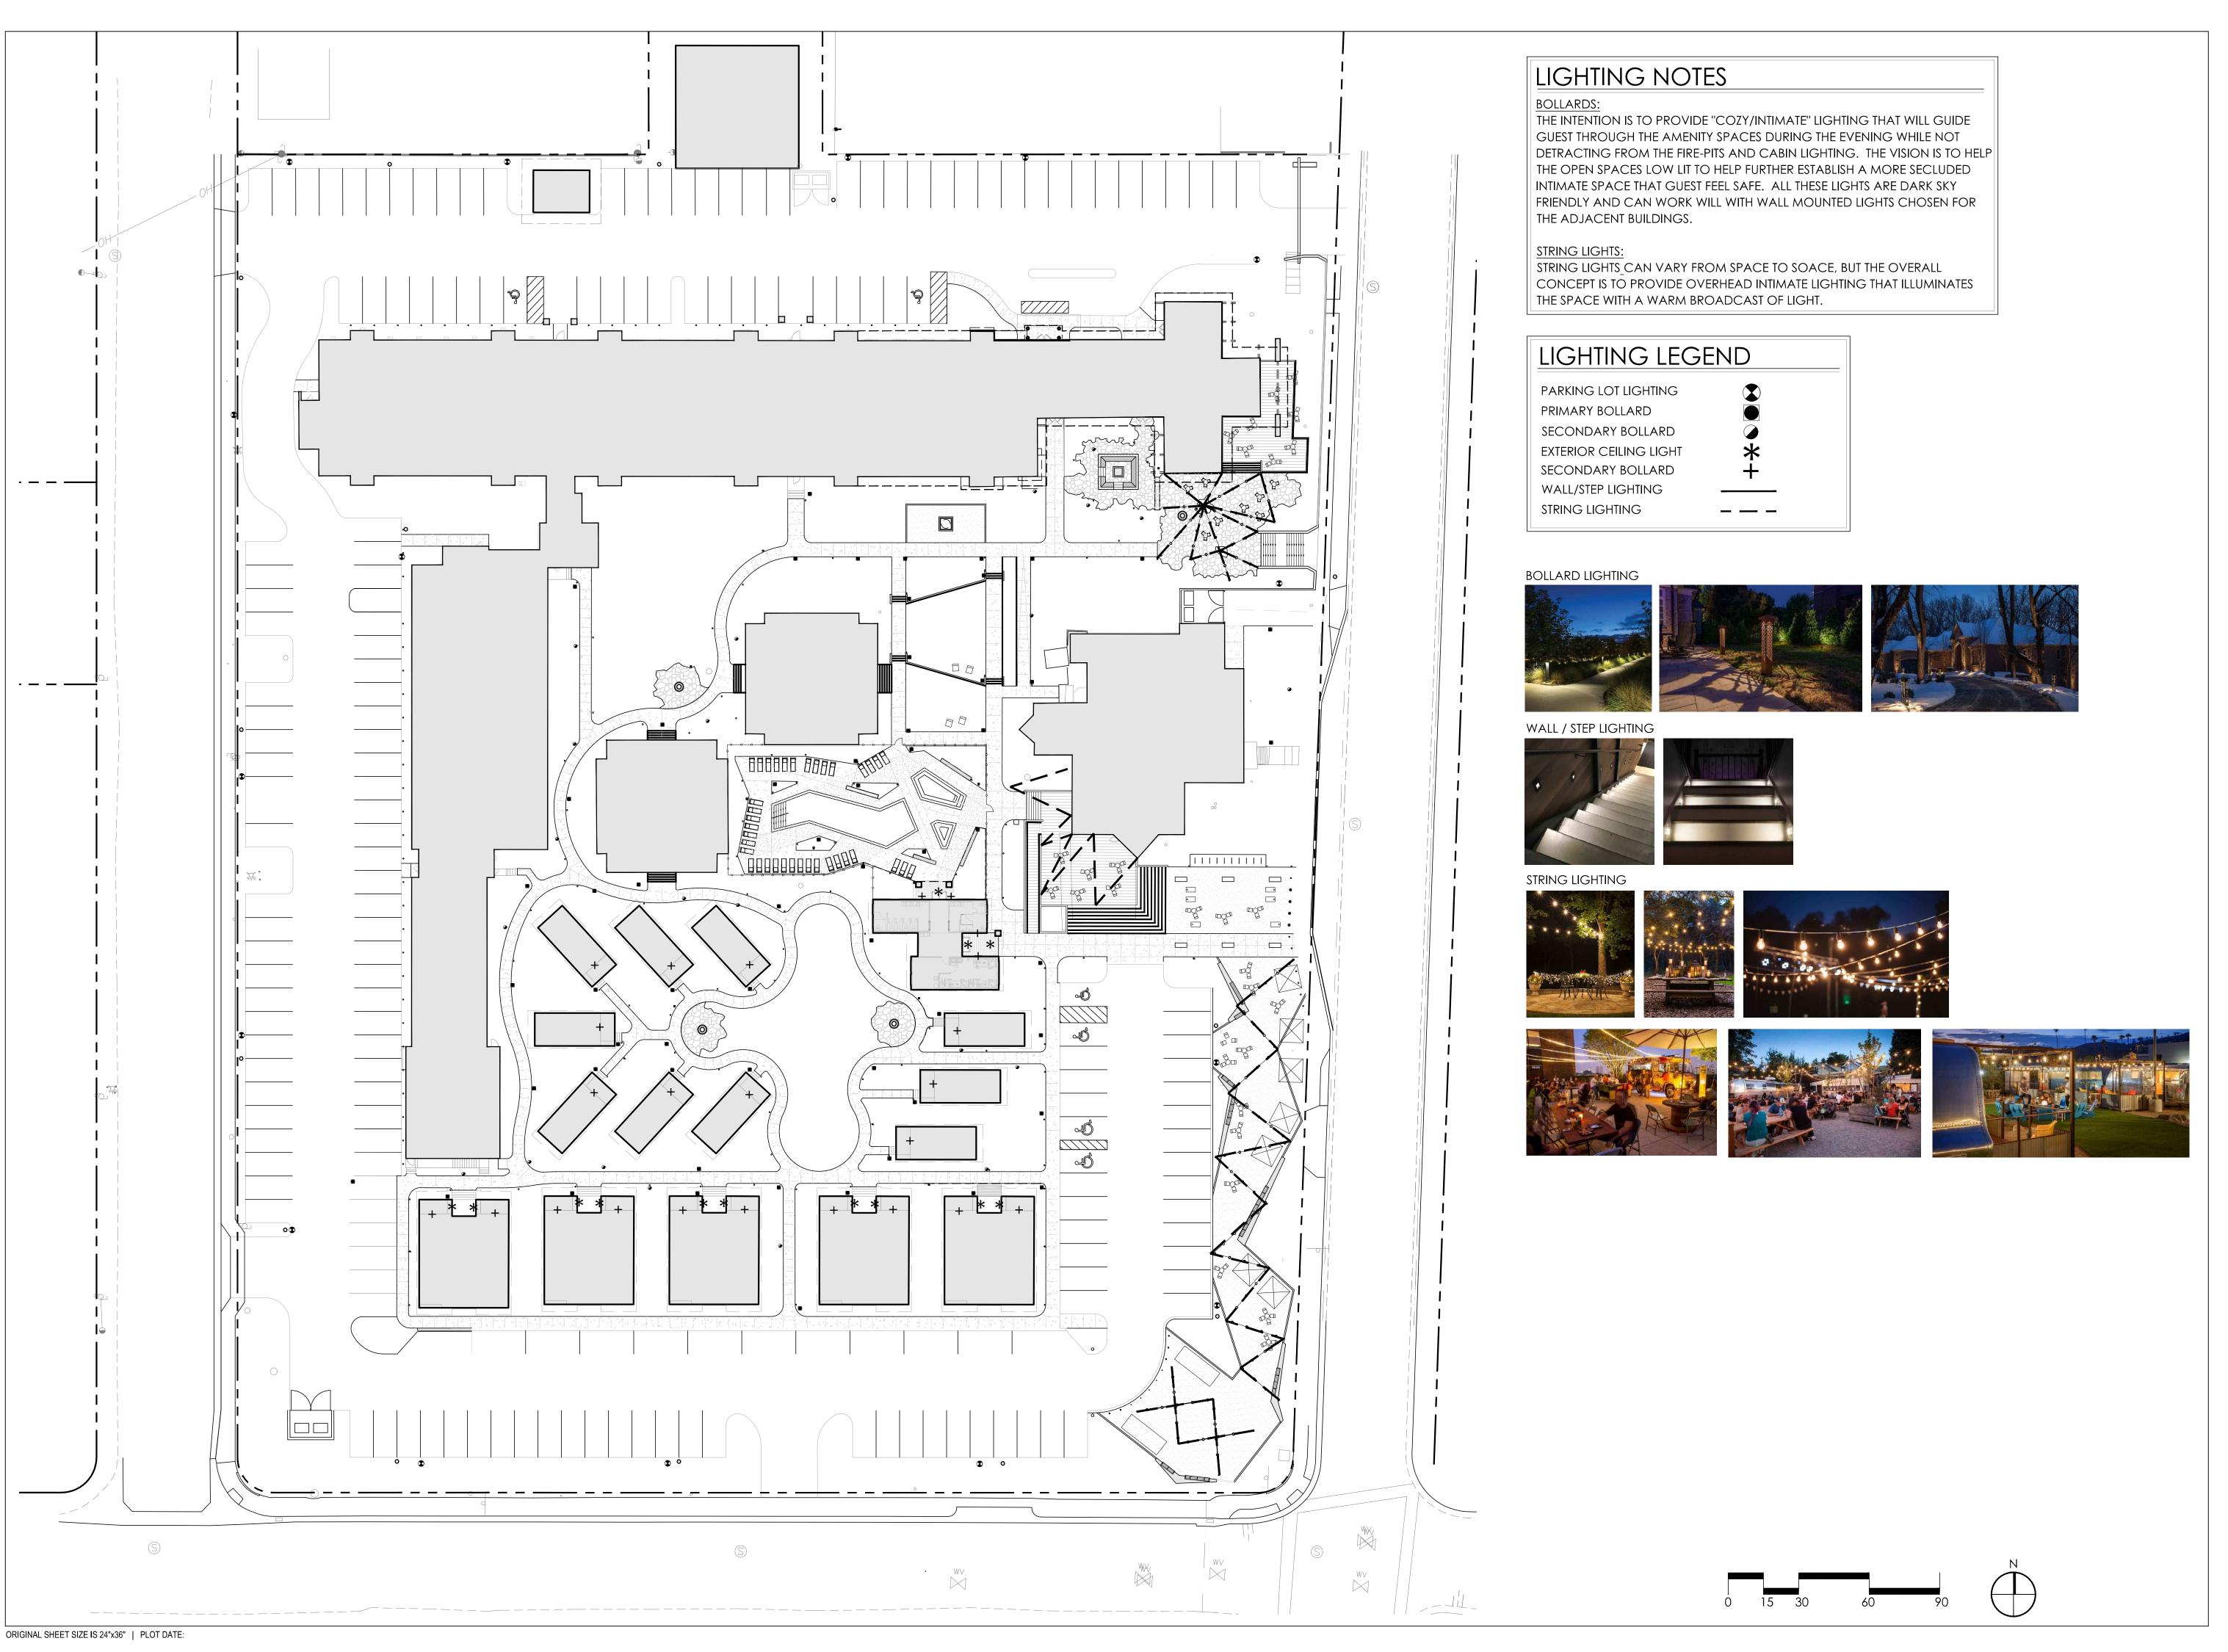

164 OLD MAMMOTH RD, MAMMOTH LAKES, CA 93546

DESIGN REVIEW SUBMITTAL

November 17, 2021

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PROJECT ISSUES: **DESIGN REVIEW SUBMITTAL DESIGN REVIEW RESUBMITTAL**


SHEET DATE: REVISIONS

CHECKED: PROJECT No.

SHEET TITLE: **OVERALL LIGHTING PLAN**

ISSUE: DESIGN REVIEW SUBMITTAL

D7.00

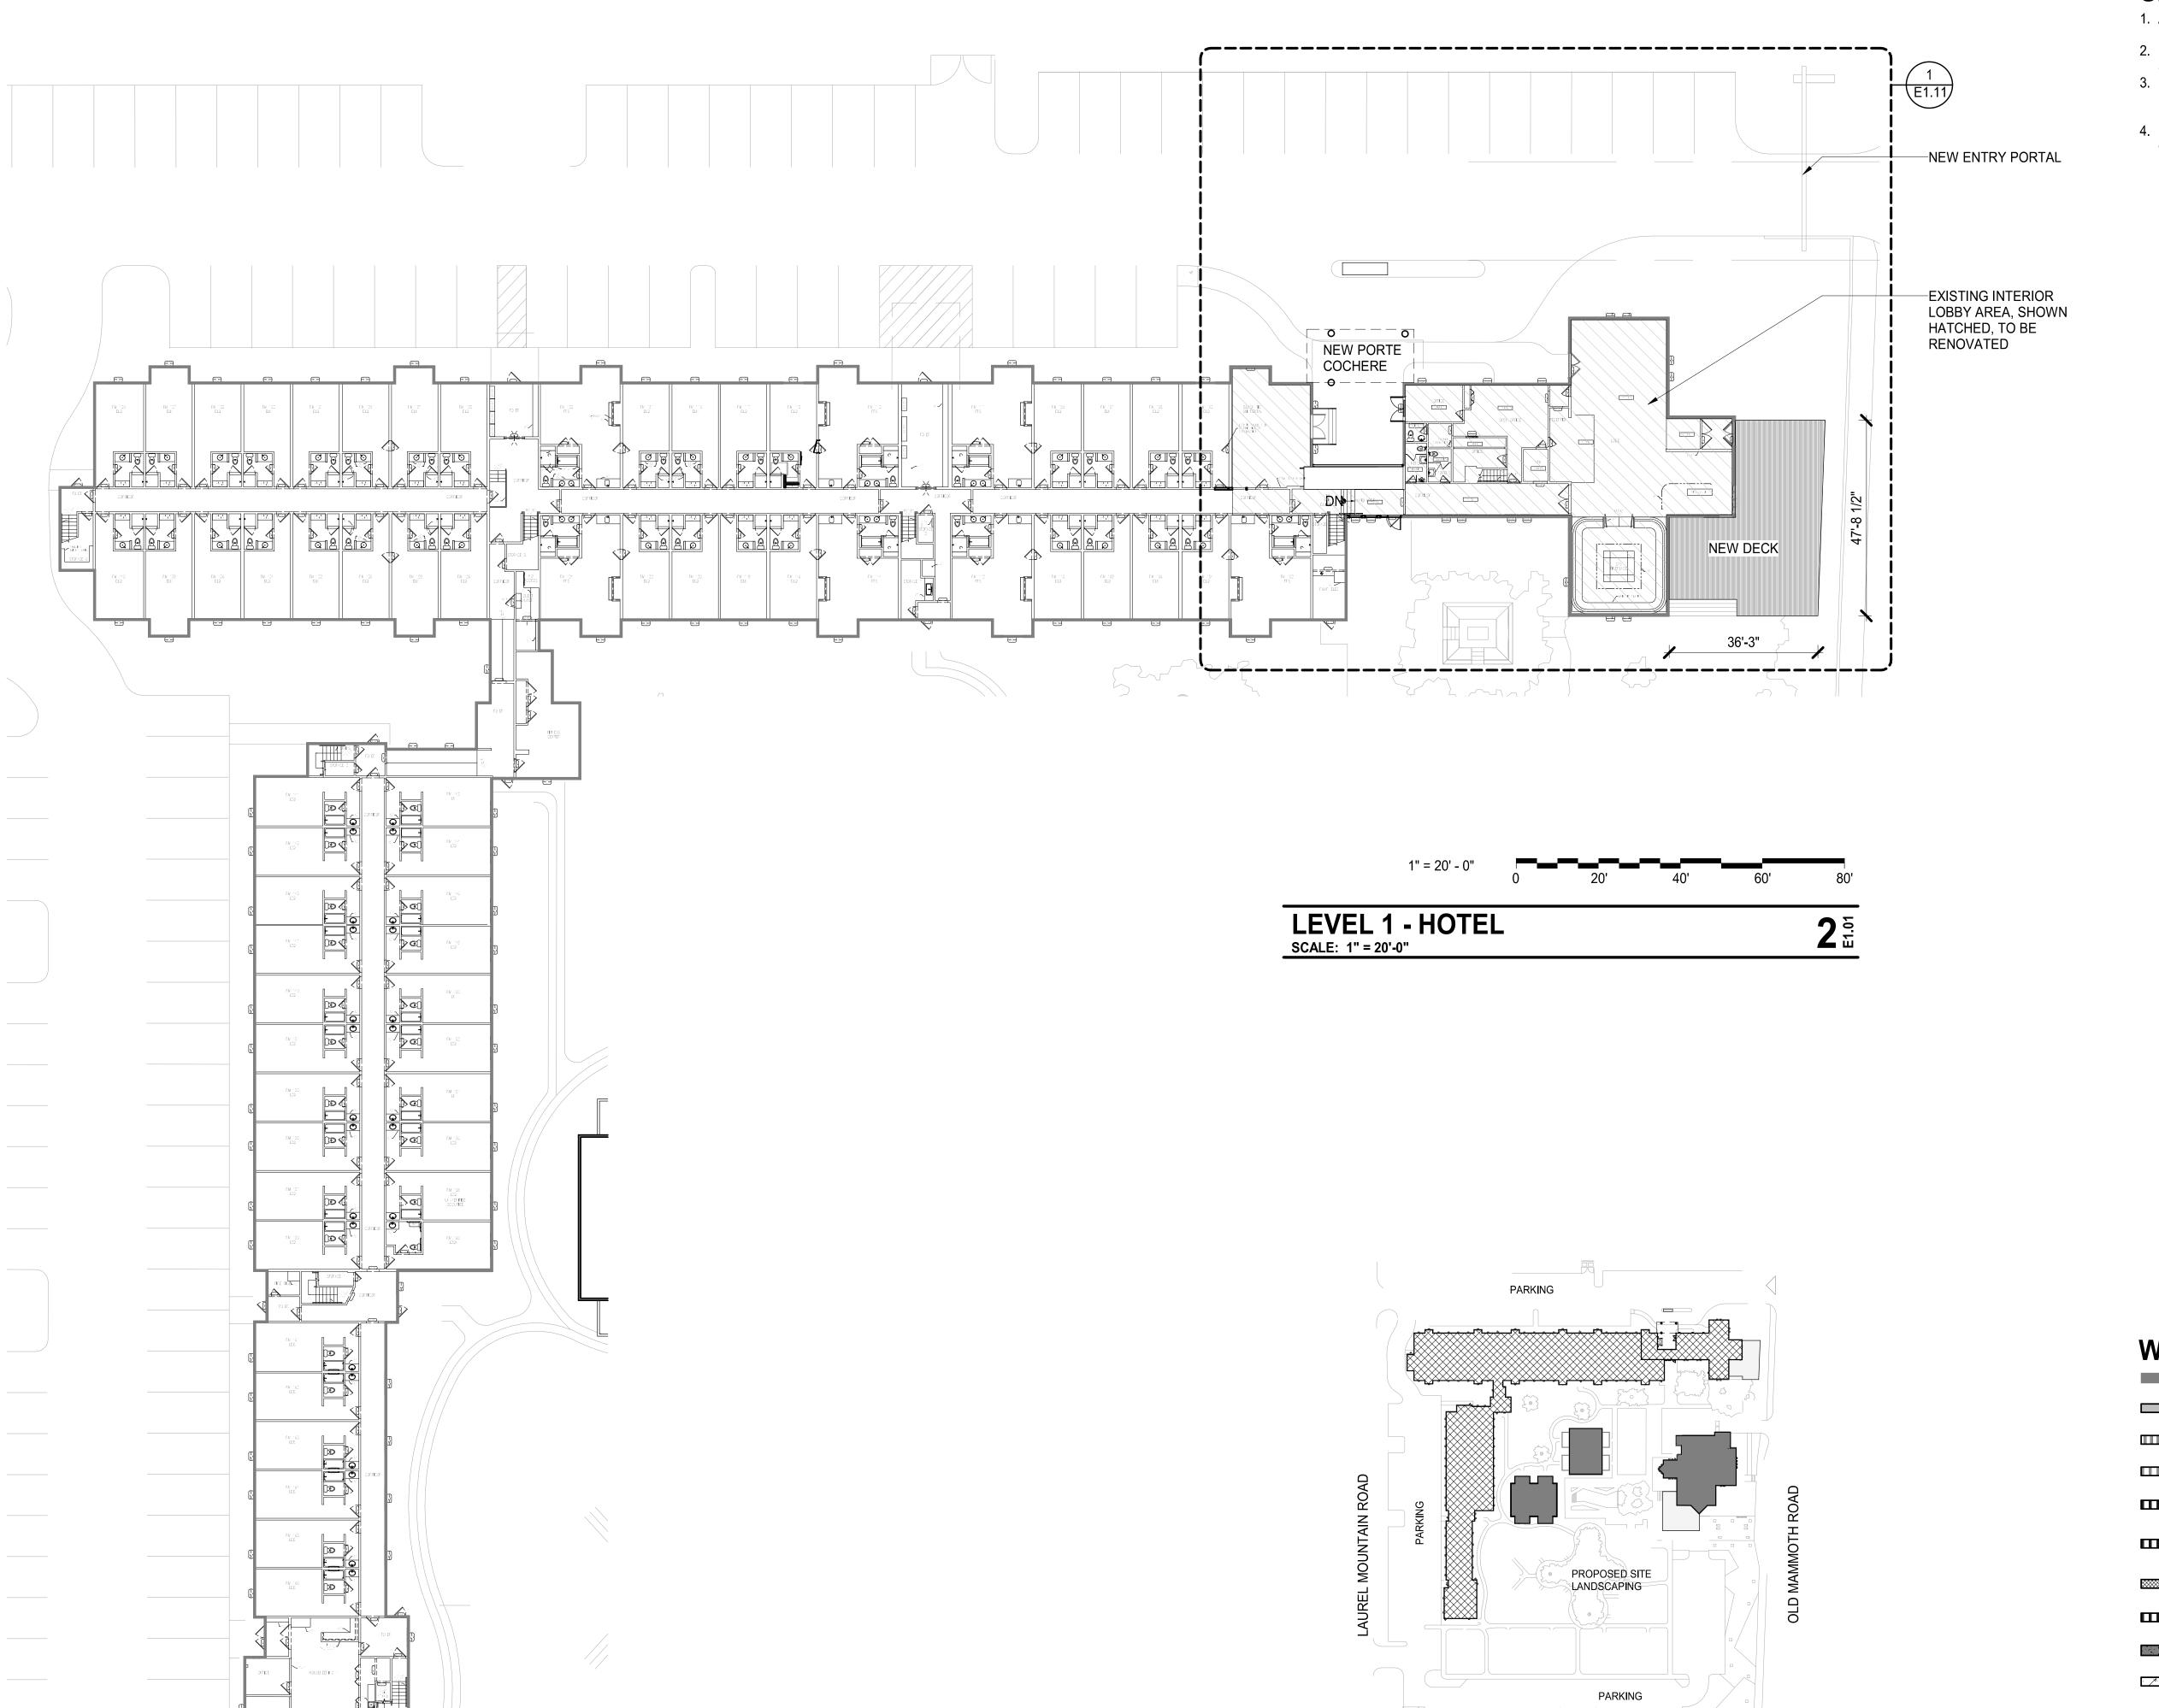

ORIGINAL SHEET SIZE IS 24"x36" | PLOT DATE: 11/13/2021 10:14:45 PM

SIERRA NEVADA RD

KEY - SITE PLAN (HOTEL)

SCALE: 1" = 100'-0"

SHEET NOTES

- 1. ALL DIMENSIONS ARE TO FACE OF FINISH,
- U.O.N. 2. EXISTING BUILDING EXTERIORS TO REMAIN,
- SEE E4.11 FOR PROPOSED FINISHES.
- 3. REFER TO CIVIL C-SERIES SHEETS AND LANDSCAPE D-SERIES SHEETS FOR
- PROPOSED SITE WORK. 4. REFER TO F-SERIES SHEETS FOR PROPOSED CABINS AND POOL SCOPE.





SIERRA NEVADA RESORT 164 OLD MAMMOTH RD, MAMMOTH LAKES, CA 93546

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November 1, 2021



1/1/2019

XX.XXX

WALL TYPES

EXISTING WALL

NON-RATED WALL (NEW)

1-HOUR FIRE PROTECTED WALL

1-HOUR RATED FIRE PARTITION

1-HOUR RATED FIRE BARRIER

2-HOUR RATED FIRE BARRIER / FIRE BARRIER

2-HOUR FIRE PROTECTED WALL

3-HOUR RATED FIRE WALL

CONCRETE WALL

CONCRETE MASONRY UNIT WALL

PARTITION TYPE: SEE 'PARTITION TYPE NAMING CONVENTION' ON A8.01

-MODIFIER: SEE PARTITION COMPONENT MATRIX ON A8.01 —FIRE RATING (HRS)

E1.01

ISSUE:

SHEET DATE:


REVISIONS

DRAWN: CHECKED:

PROJECT No.

SHEET TITLE:

OVERALL FLOOR PLANS AT EXISTING BUILDINGS

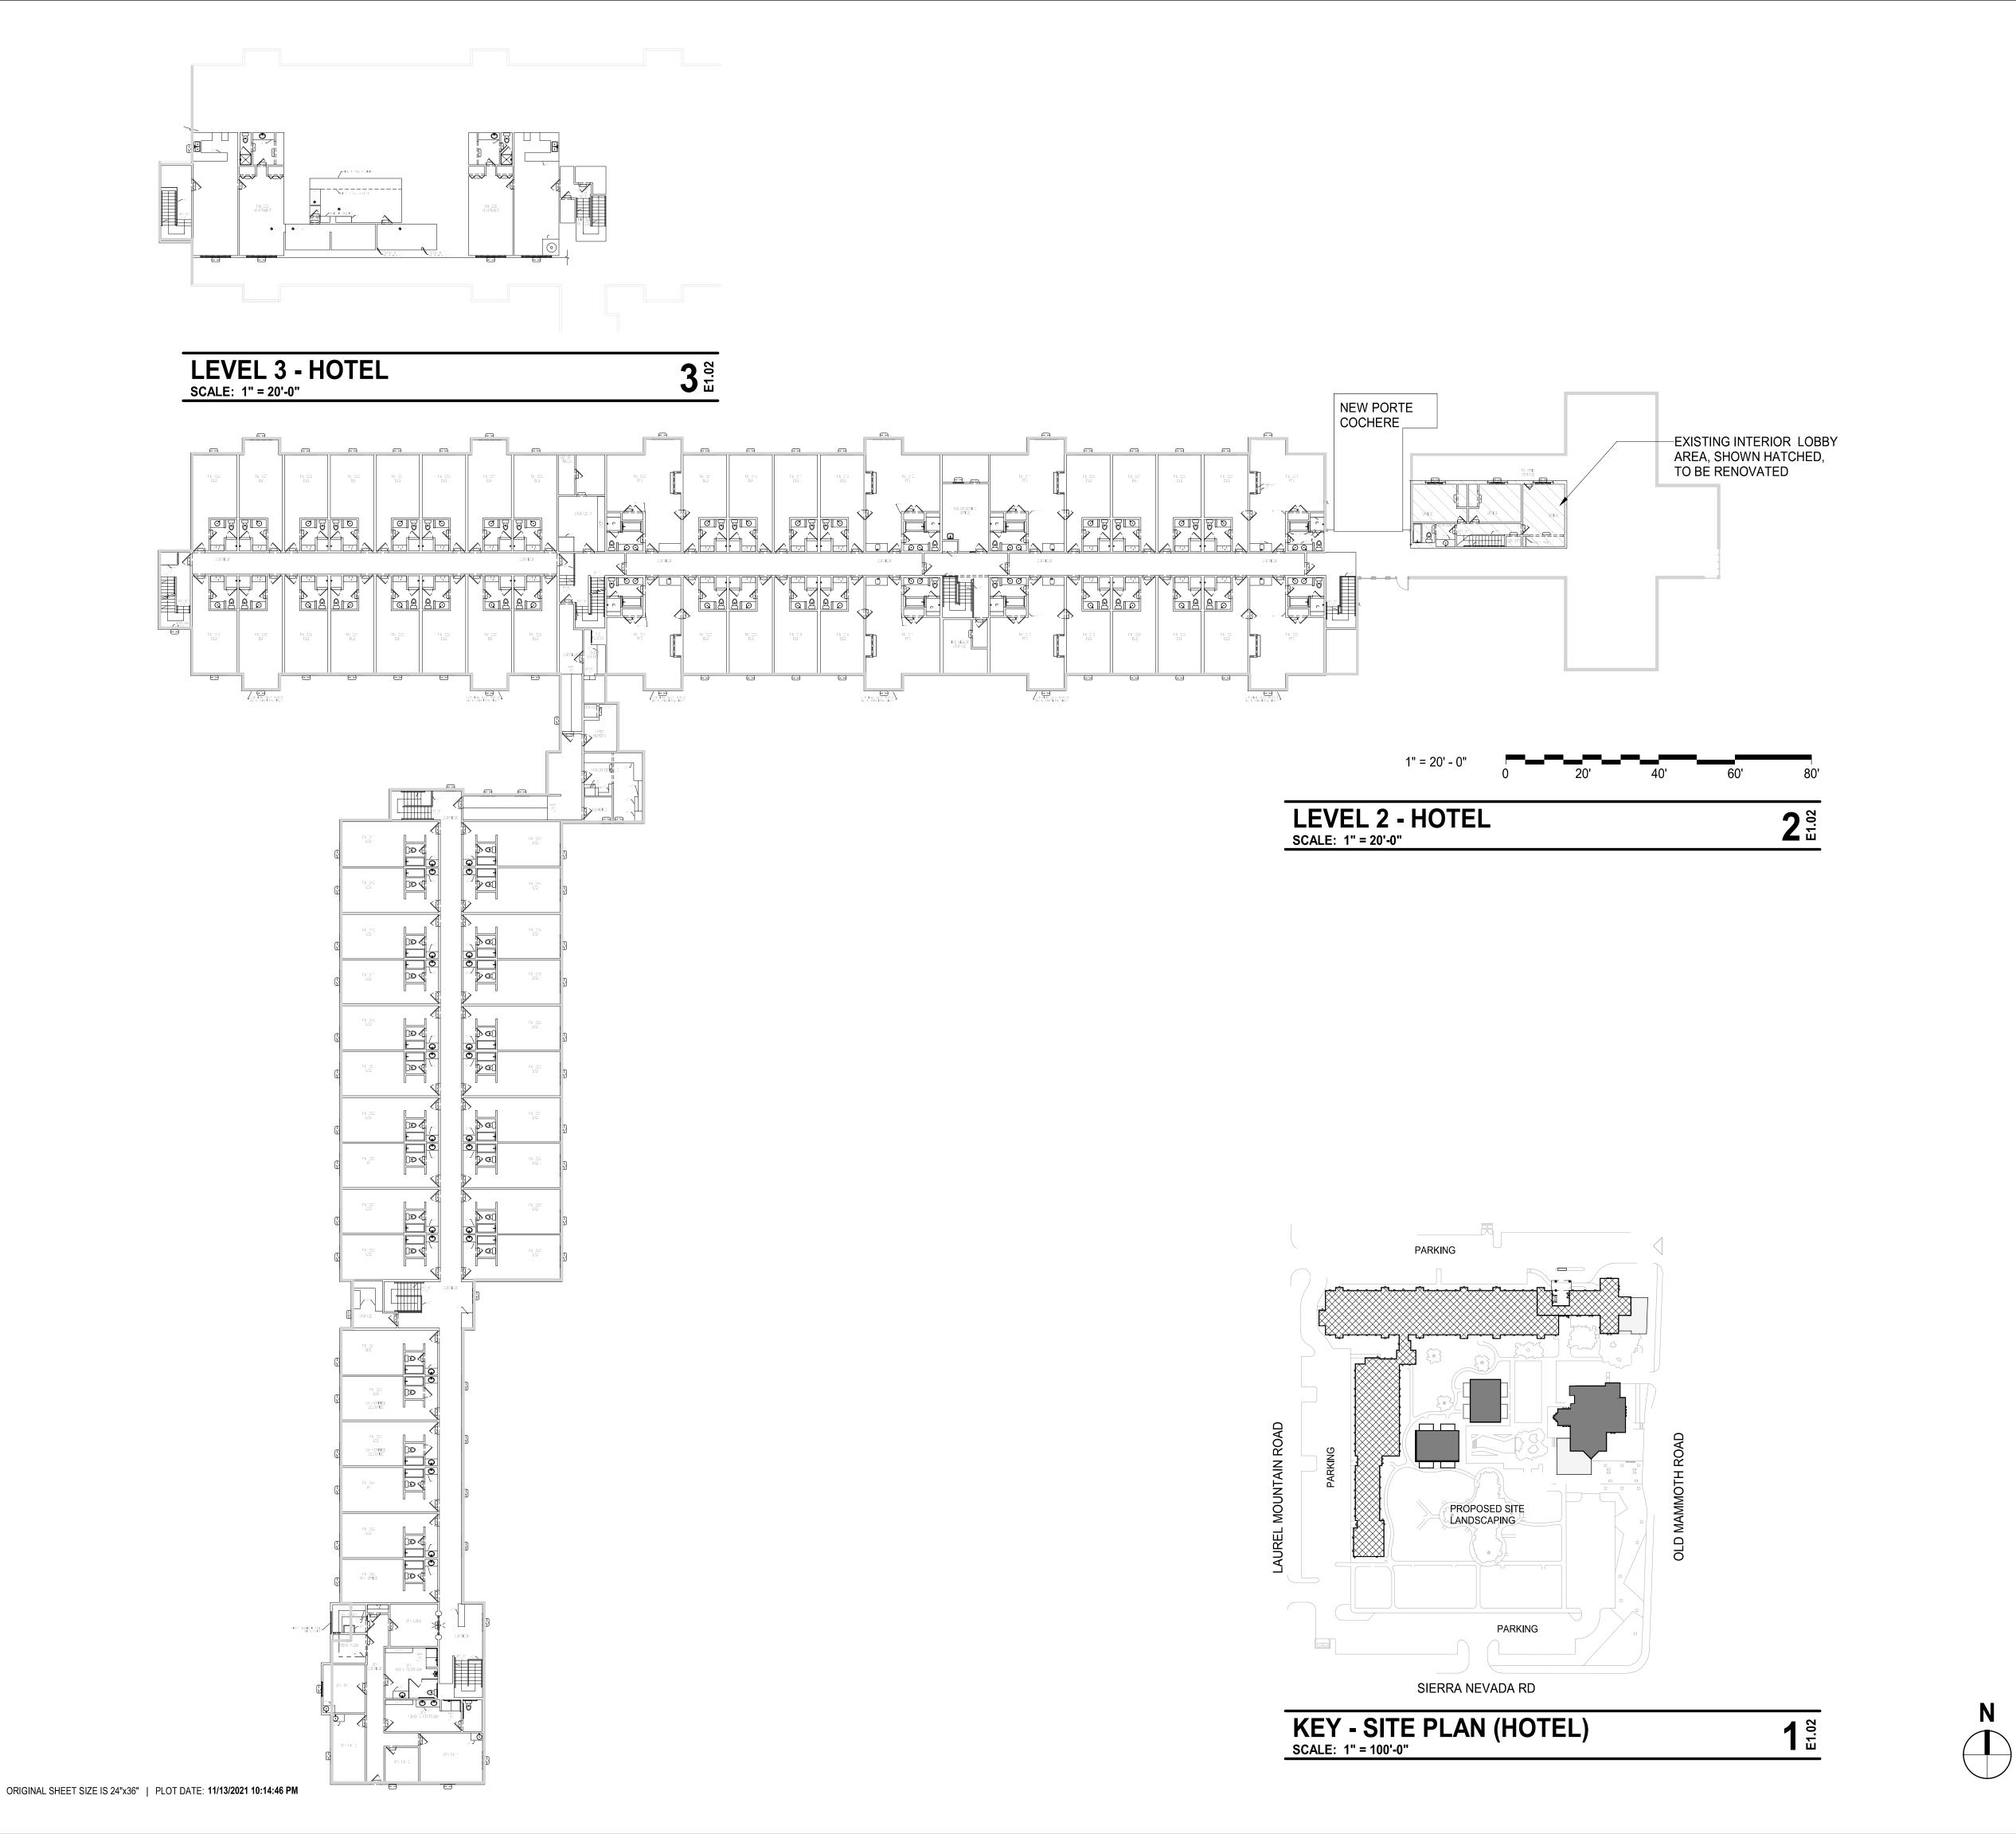

SHEET NOTES

- 1. ALL DIMENSIONS ARE TO FACE OF FINISH,
- U.O.N. 2. EXISTING BUILDING EXTERIORS TO REMAIN,
- SEE E4.11 FOR PROPOSED FINISHES. 3. REFER TO CIVIL C-SERIES SHEETS AND
- LANDSCAPE D-SERIES SHEETS FOR PROPOSED SITE WORK.
- 4. REFER TO F-SERIES SHEETS FOR PROPOSED CABINS AND POOL SCOPE.



SIERRA NEVADA RESORT 164 OLD MAMMOTH RD,

MAMMOTH LAKES, CA 93546

DESIGN REVIEW SUBMITTAL

November 1, 2021



SHEET DATE:

REVISIONS

DRAWN: CHECKED:

PROJECT No.

SHEET TITLE:

ISSUE:

WALL TYPES

EXISTING WALL

NON-RATED WALL (NEW)

1-HOUR FIRE PROTECTED WALL

1-HOUR RATED FIRE PARTITION

1-HOUR RATED FIRE BARRIER

2-HOUR RATED FIRE BARRIER / FIRE BARRIER

2-HOUR FIRE PROTECTED WALL

3-HOUR RATED FIRE WALL

CONCRETE WALL CONCRETE MASONRY UNIT WALL


-PARTITION TYPE: SEE 'PARTITION TYPE NAMING CONVENTION' ON A8.01


-MODIFIER: SEE PARTITION COMPONENT MATRIX ON A8.01 FIRE RATING (HRS)

E1.02

OVERALL FLOOR PLANS AT EXISTING BUILDINGS


XX.XXX

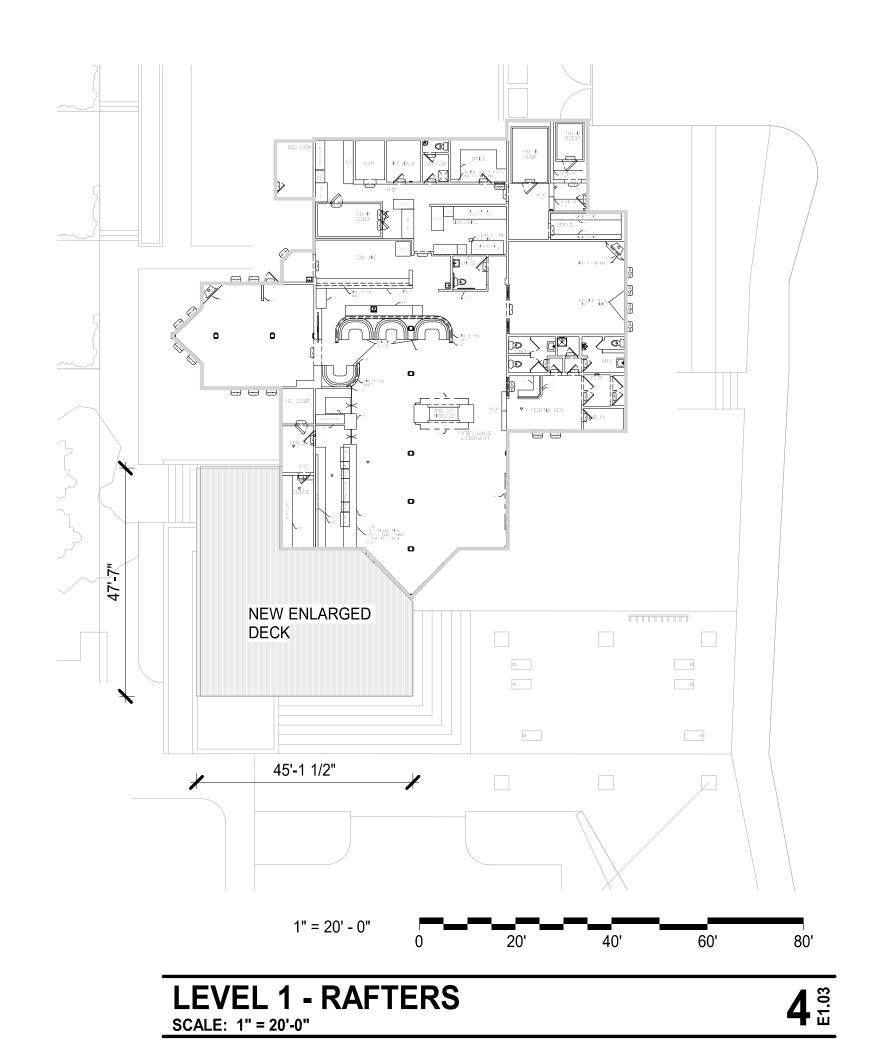

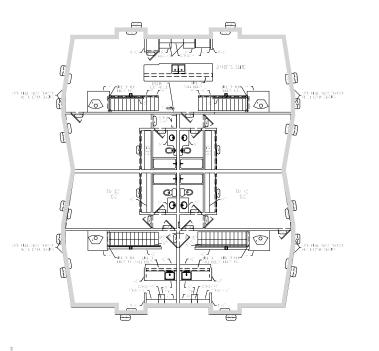

LEVEL 2 - CHALET (TYP. OF 2)
SCALE: 1" = 20'-0"


3 E. .

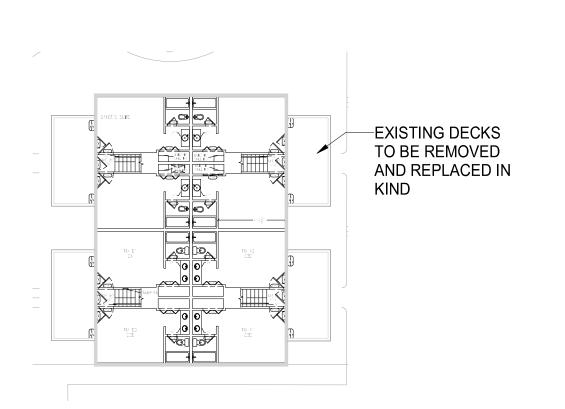



LEVEL 1 - CHALET (TYP. OF 2)

SCALE: 1" = 20'-0"

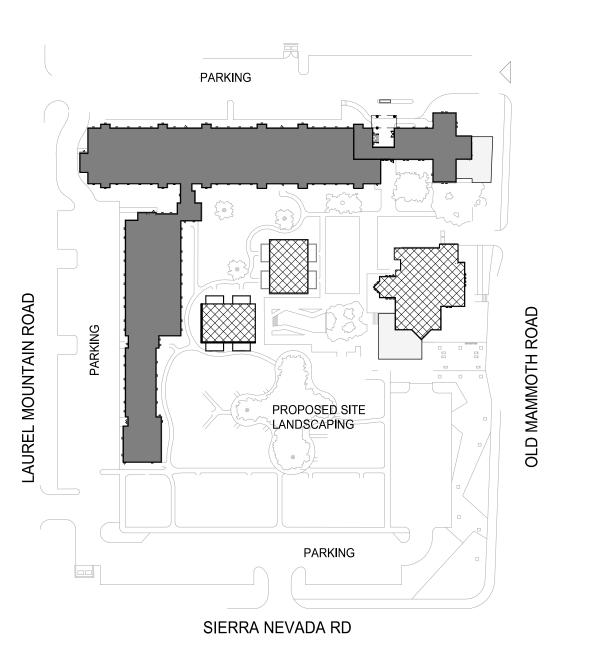

KEY - SITE PLAN (RAFTERS/CHALETS)
SCALE: 1" = 100'-0"

SHEET NOTES

- 1. ALL DIMENSIONS ARE TO FACE OF FINISH,
- 2. EXISTING BUILDING EXTERIORS TO REMAIN,
- SEE E4.11 FOR PROPOSED FINISHES.

 3. REFER TO CIVIL C-SERIES SHEETS AND LANDSCAPE D-SERIES SHEETS FOR
- PROPOSED SITE WORK.

 4. REFER TO F-SERIES SHEETS FOR PROPOSED CABINS AND POOL SCOPE.



164 OLD MAMMOTH RD, MAMMOTH LAKES, CA 93546

DESIGN REVIEW SUBMITTAL

November 1, 2021

WATERTON

The Local Section of the Comparchitect of

WALL TYPES

EXISTING WALL

NON-RATED WALL (NEW)

1-HOUR FIRE PROTECTED WALL

1-HOUR RATED FIRE PARTITION

1-HOUR RATED FIRE BARRIER

2-HOUR RATED FIRE BARRIER / FIRE BARRIER

2-HOUR FIRE PROTECTED WALL

3-HOUR RATED FIRE WALL

CONCRETE WALL

CONCRETE MASONRY UNIT WALL

PARTITION TYPE: SEE 'PARTITION
TYPE NAMING CONVENTION' ON A8.01

MODIFIER: SEE PARTITION
COMPONENT MATRIX ON A8.01
FIRE RATING (HRS)

ISSUE:

SHEET DATE:

REVISIONS

DRAWN: CHECKED:


PROJECT No.

SHEET TITLE:

E1.03

OVERALL FLOOR PLANS AT EXISTING BUILDINGS

XX.XXX

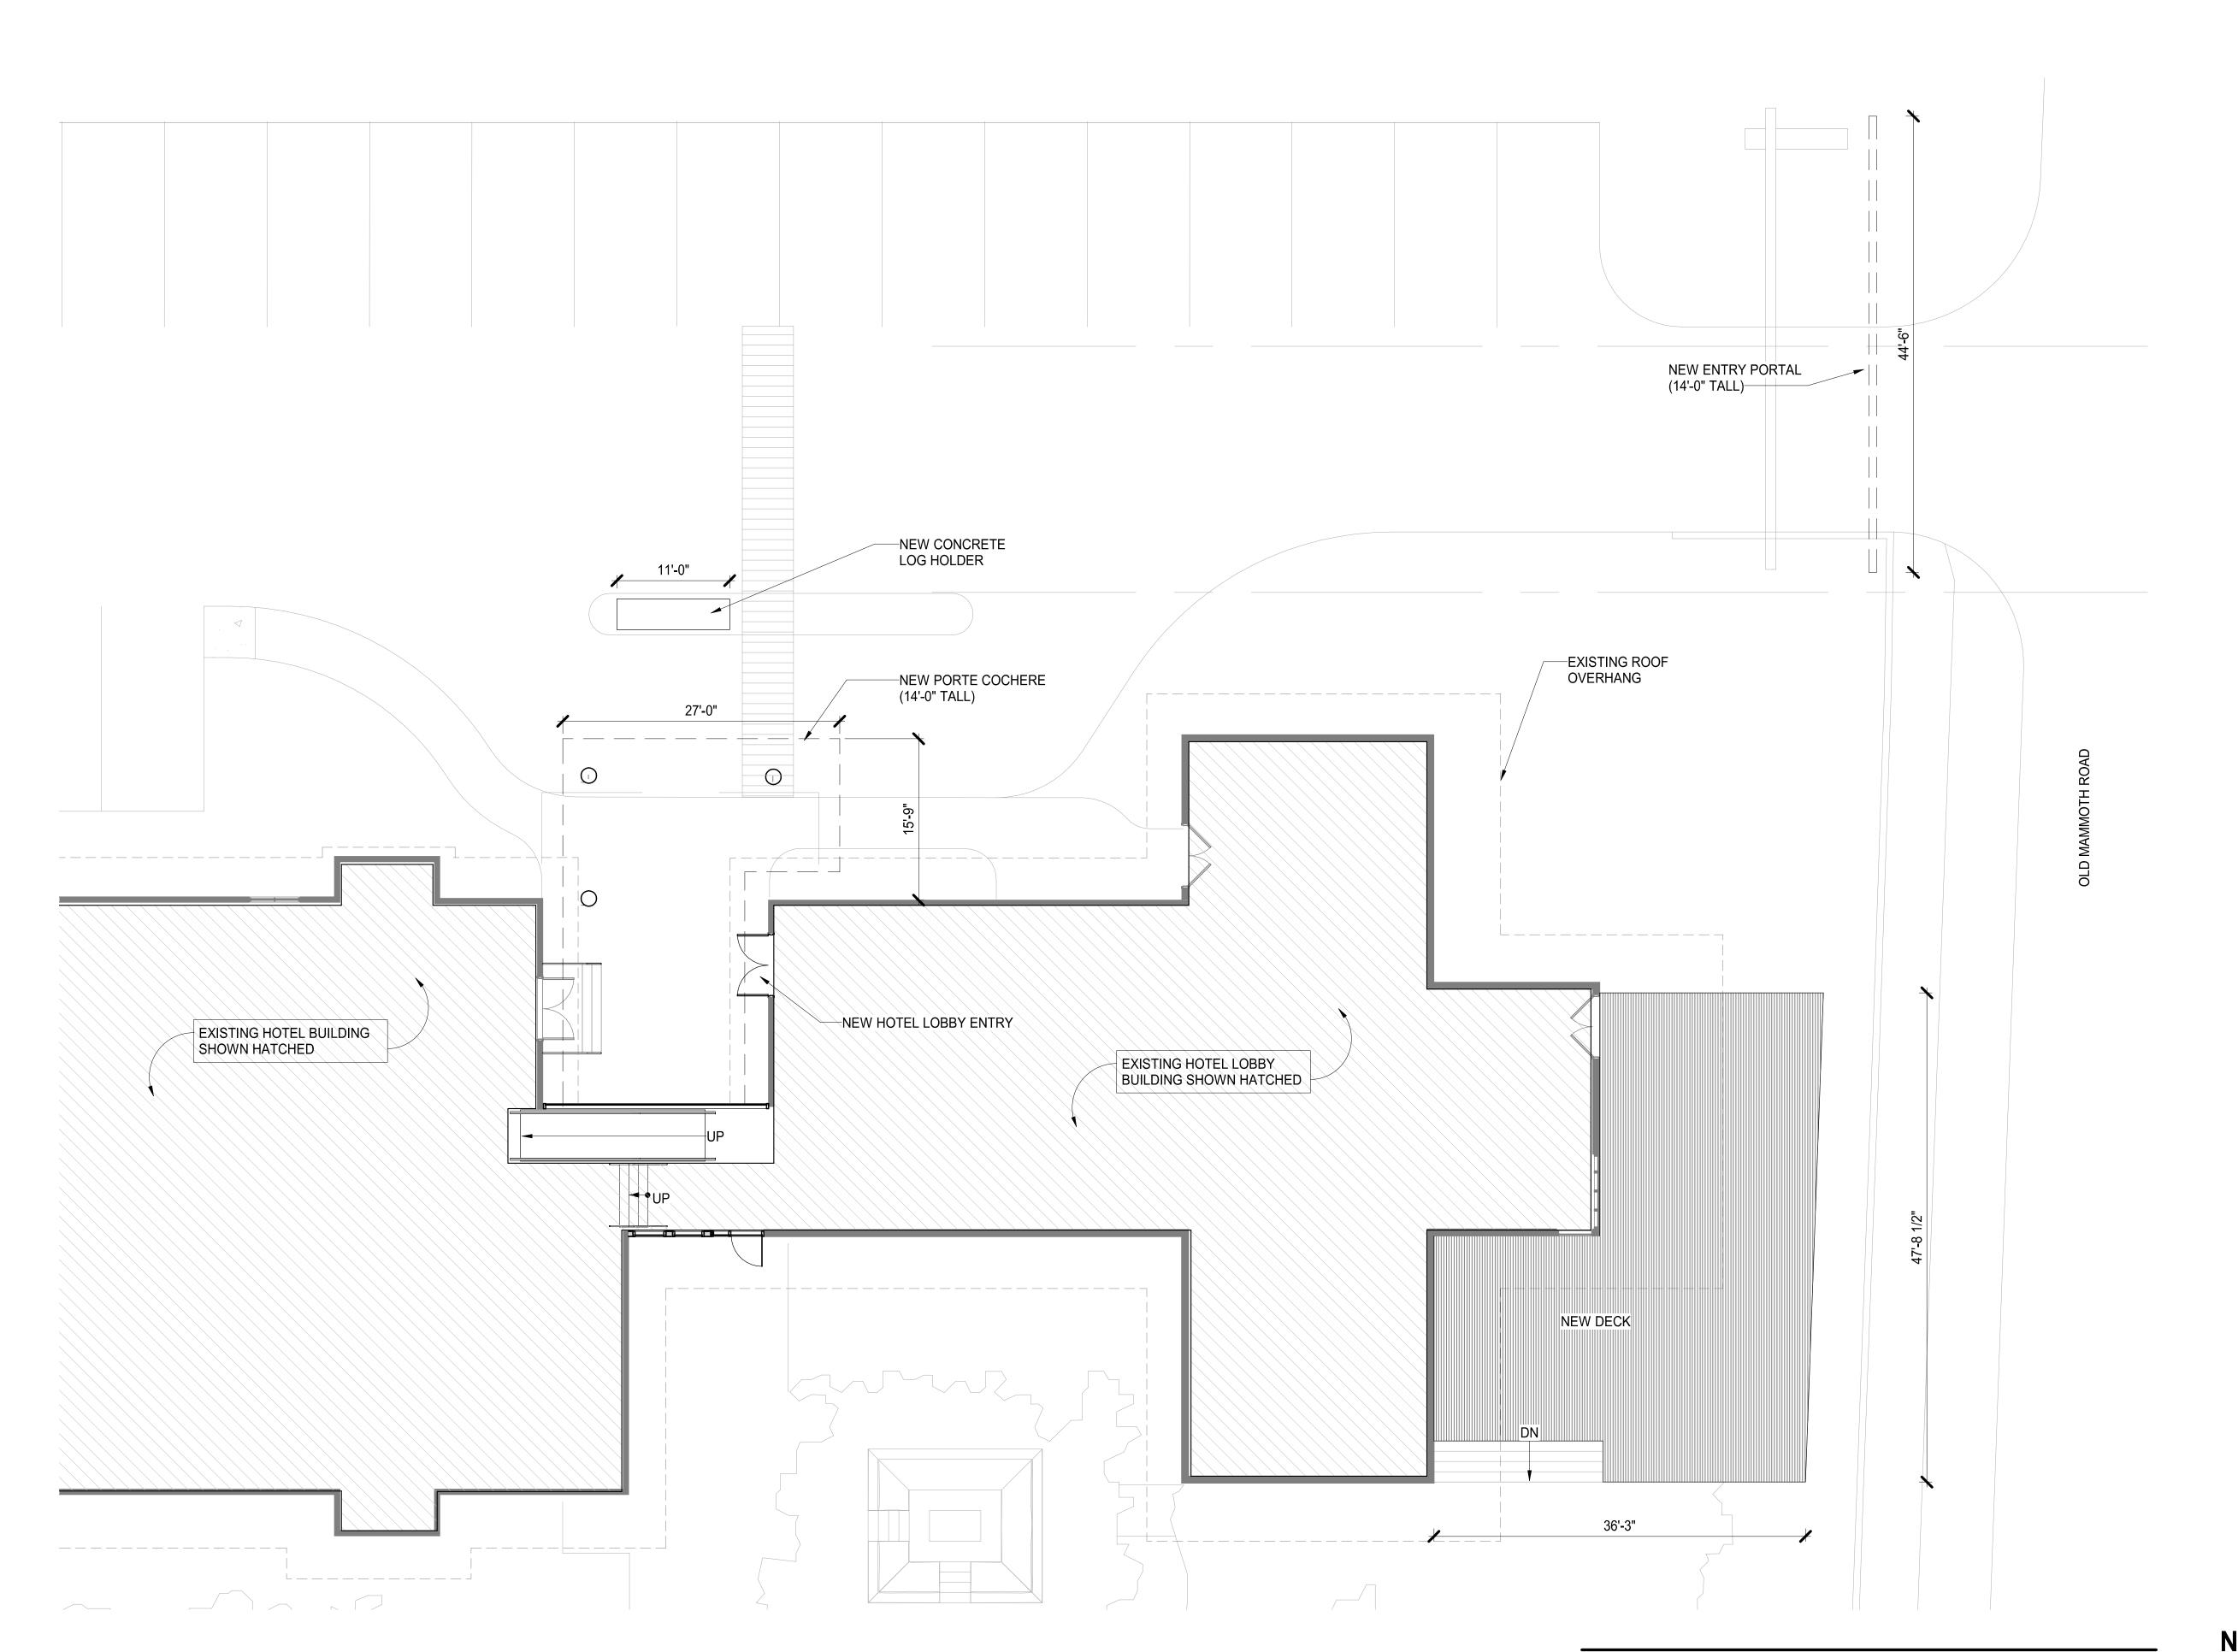

LEVEL 1 - PORTE COCHERE AND LOBBY 1 = SCALE: 1/8" = 1'-0"



- 1. ALL DIMENSIONS ARE TO FACE OF FINISH, U.O.N.
- 2. EXISTING BUILDING EXTERIORS TO REMAIN, SEE E4.11 FOR PROPOSED FINISHES.
- 3. REFER TO CIVIL C-SERIES SHEETS AND LANDSCAPE D-SERIES SHEETS FOR
- PROPOSED SITE WORK. 4. REFER TO F-SERIES SHEETS FOR PROPOSED CABINS AND POOL SCOPE.



164 OLD MAMMOTH RD, MAMMOTH LAKES, CA 93546

DESIGN REVIEW SUBMITTAL

November 1, 2021



SHEET DATE:

REVISIONS

DRAWN: CHECKED:

PROJECT No.

SHEET TITLE:

ISSUE:

1/1/2019

XX.XXX

WALL TYPES

EXISTING WALL

NON-RATED WALL (NEW)

1-HOUR FIRE PROTECTED WALL

1-HOUR RATED FIRE PARTITION

1-HOUR RATED FIRE BARRIER

2-HOUR RATED FIRE BARRIER / FIRE BARRIER

2-HOUR FIRE PROTECTED WALL

3-HOUR RATED FIRE WALL

CONCRETE WALL CONCRETE MASONRY UNIT WALL

—PARTITION TYPE: SEE 'PARTITION TYPE NAMING CONVENTION' ON A8.01

MODIFIER: SEE PARTITION
COMPONENT MATRIX ON A8.01 FIRE RATING (HRS)

E1.11

ENLARGED FLOOR PLAN

- PORTE COCHERE, LOBBY




APPROACH FROM NORTH ON OLD MAMMOTH



APPROACH FROM SOUTH ON OLD MAMMOTH



CERTAINTEED
"HARBOR SUNSET"

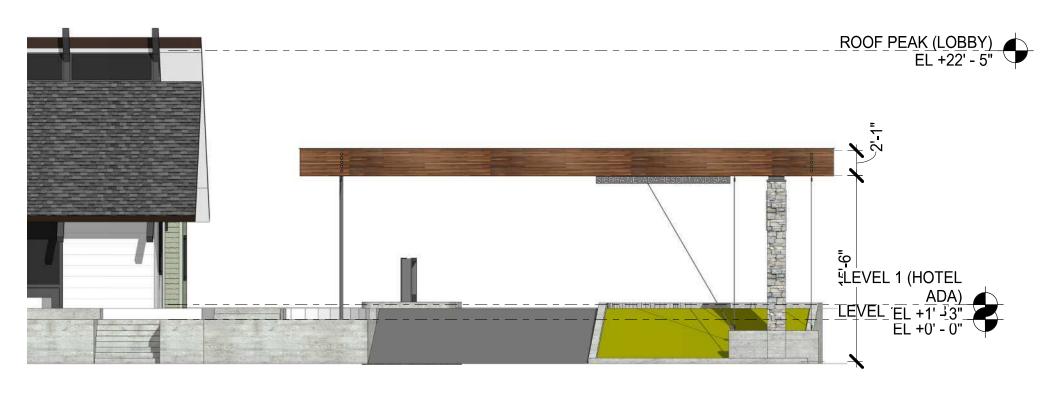

ELEVATION AT ENTRY PORTAL SCALE: 1/8" = 1'-0"

1 E4.01

SIERRA NEVADA RESORT

93546

164 OLD MAMMOTH RD, MAMMOTH LAKES, CA

DESIGN REVIEW SUBMITTAL November 1, 2021



PROJECT ISSUES:

DESIGN REVIEW SUBMITTAL 1:

SHEET DATE:
REVISIONS

DRAWN:

CHECKED:
PROJECT No. 21.029

SHEET TITLE:

ELEVATIONS - ENTI

ELEVATIONS - ENTRY PORTAL

ISS


E4.01



OVERALL - SOUTH
SCALE: 1/16" = 1'-0"

LEVEL 1 (LOBBY)

OLD MAMMOTH RD.

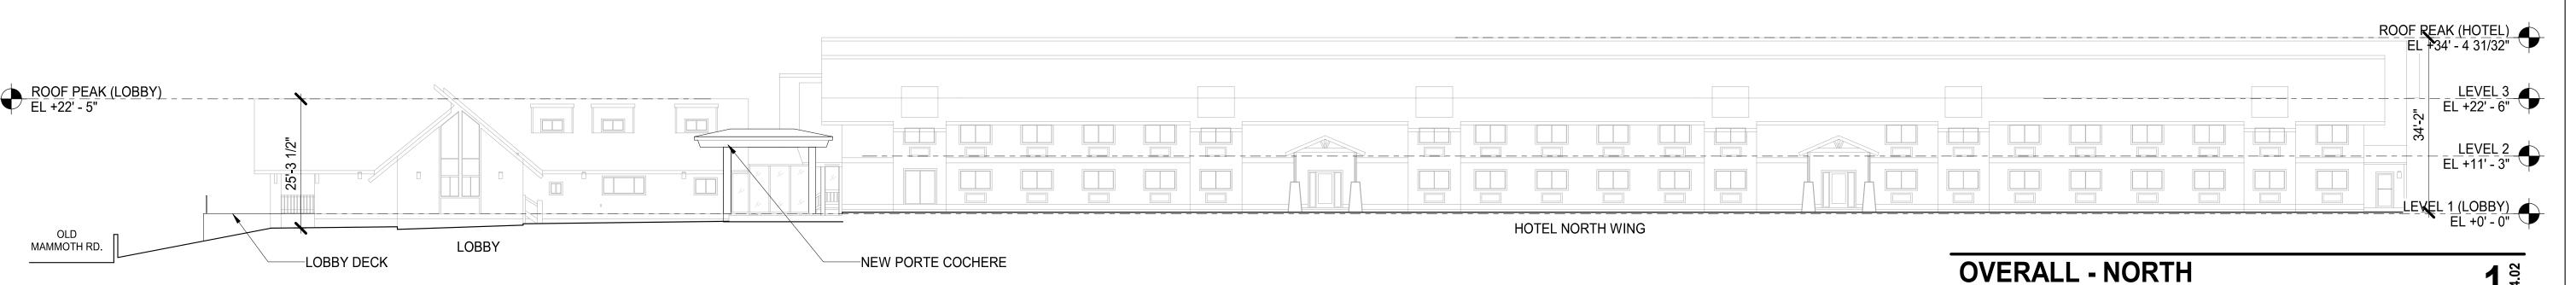

CHALET BEYOND

CHALET

BUILDING HEIGHTS

SEE BELOW FOR MAXIMUM HEIGHTS AT EACH BUILDING PER MUNICIPAL CODE 17.36.060.

RAFTERS

SCALE: 1/16" = 1'-0"

REFER TO C-SERIES SHEETS FOR SITE GRADING.

ALL BUILDINGS BELOW ARE EXISTING TO REMAIN, NO HEIGHTS ARE PROPOSED TO BE ALTERED.

LOBBY BUILDING: 25'-3 1/2"

HOTEL NORTH WING: 34'-0"

HOTEL WEST WING: 35'-10"

.....

CHALETS: 29'-3"


RAFTERS RESTAURANT: 31'-10"

SHEET NOTES

PROPOSED SITE WORK.

- 1. ALL EXISTING BUILDINGS TO REMAIN, SHOWN GREY. ALL PROPOSED ADDITIONS NOTED.
- 2. NO NEW ROOF TOP STRUCTURES PROPOSED.
- NO ALTERATIONS TO EXISTING BUILDING HEIGHTS PROPOSED.
- 4. SEE E4.11 FOR PROPOSED EXTERIOR PAINT
- COLORS ON EXISTING BUILDINGS.

 5. REFER TO CIVIL C-SERIES SHEETS AND LANDSCAPE D-SERIES SHEETS FOR
- 6. REFER TO F-SERIES SHEETS FOR PROPOSED CABINS AND POOL SCOPE.
- 7. BUILDING HEIGHTS ARE MEASURED PER MUNICIPAL CODE SECTION 17.36.060. REFER TO C-SERIES SHEETS FOR SITE GRADING.

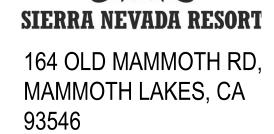

DESIGN REVIEW SUBMITTAL November 1, 2021



SHEET DATE: REVISIONS

DRAWN: CHECKED:

PROJECT No.

SHEET TITLE:

ISSUE:


EXTERIOR ELEVATIONS

E4.02

10/20/21

XX.XX

HOTEL WEST WING

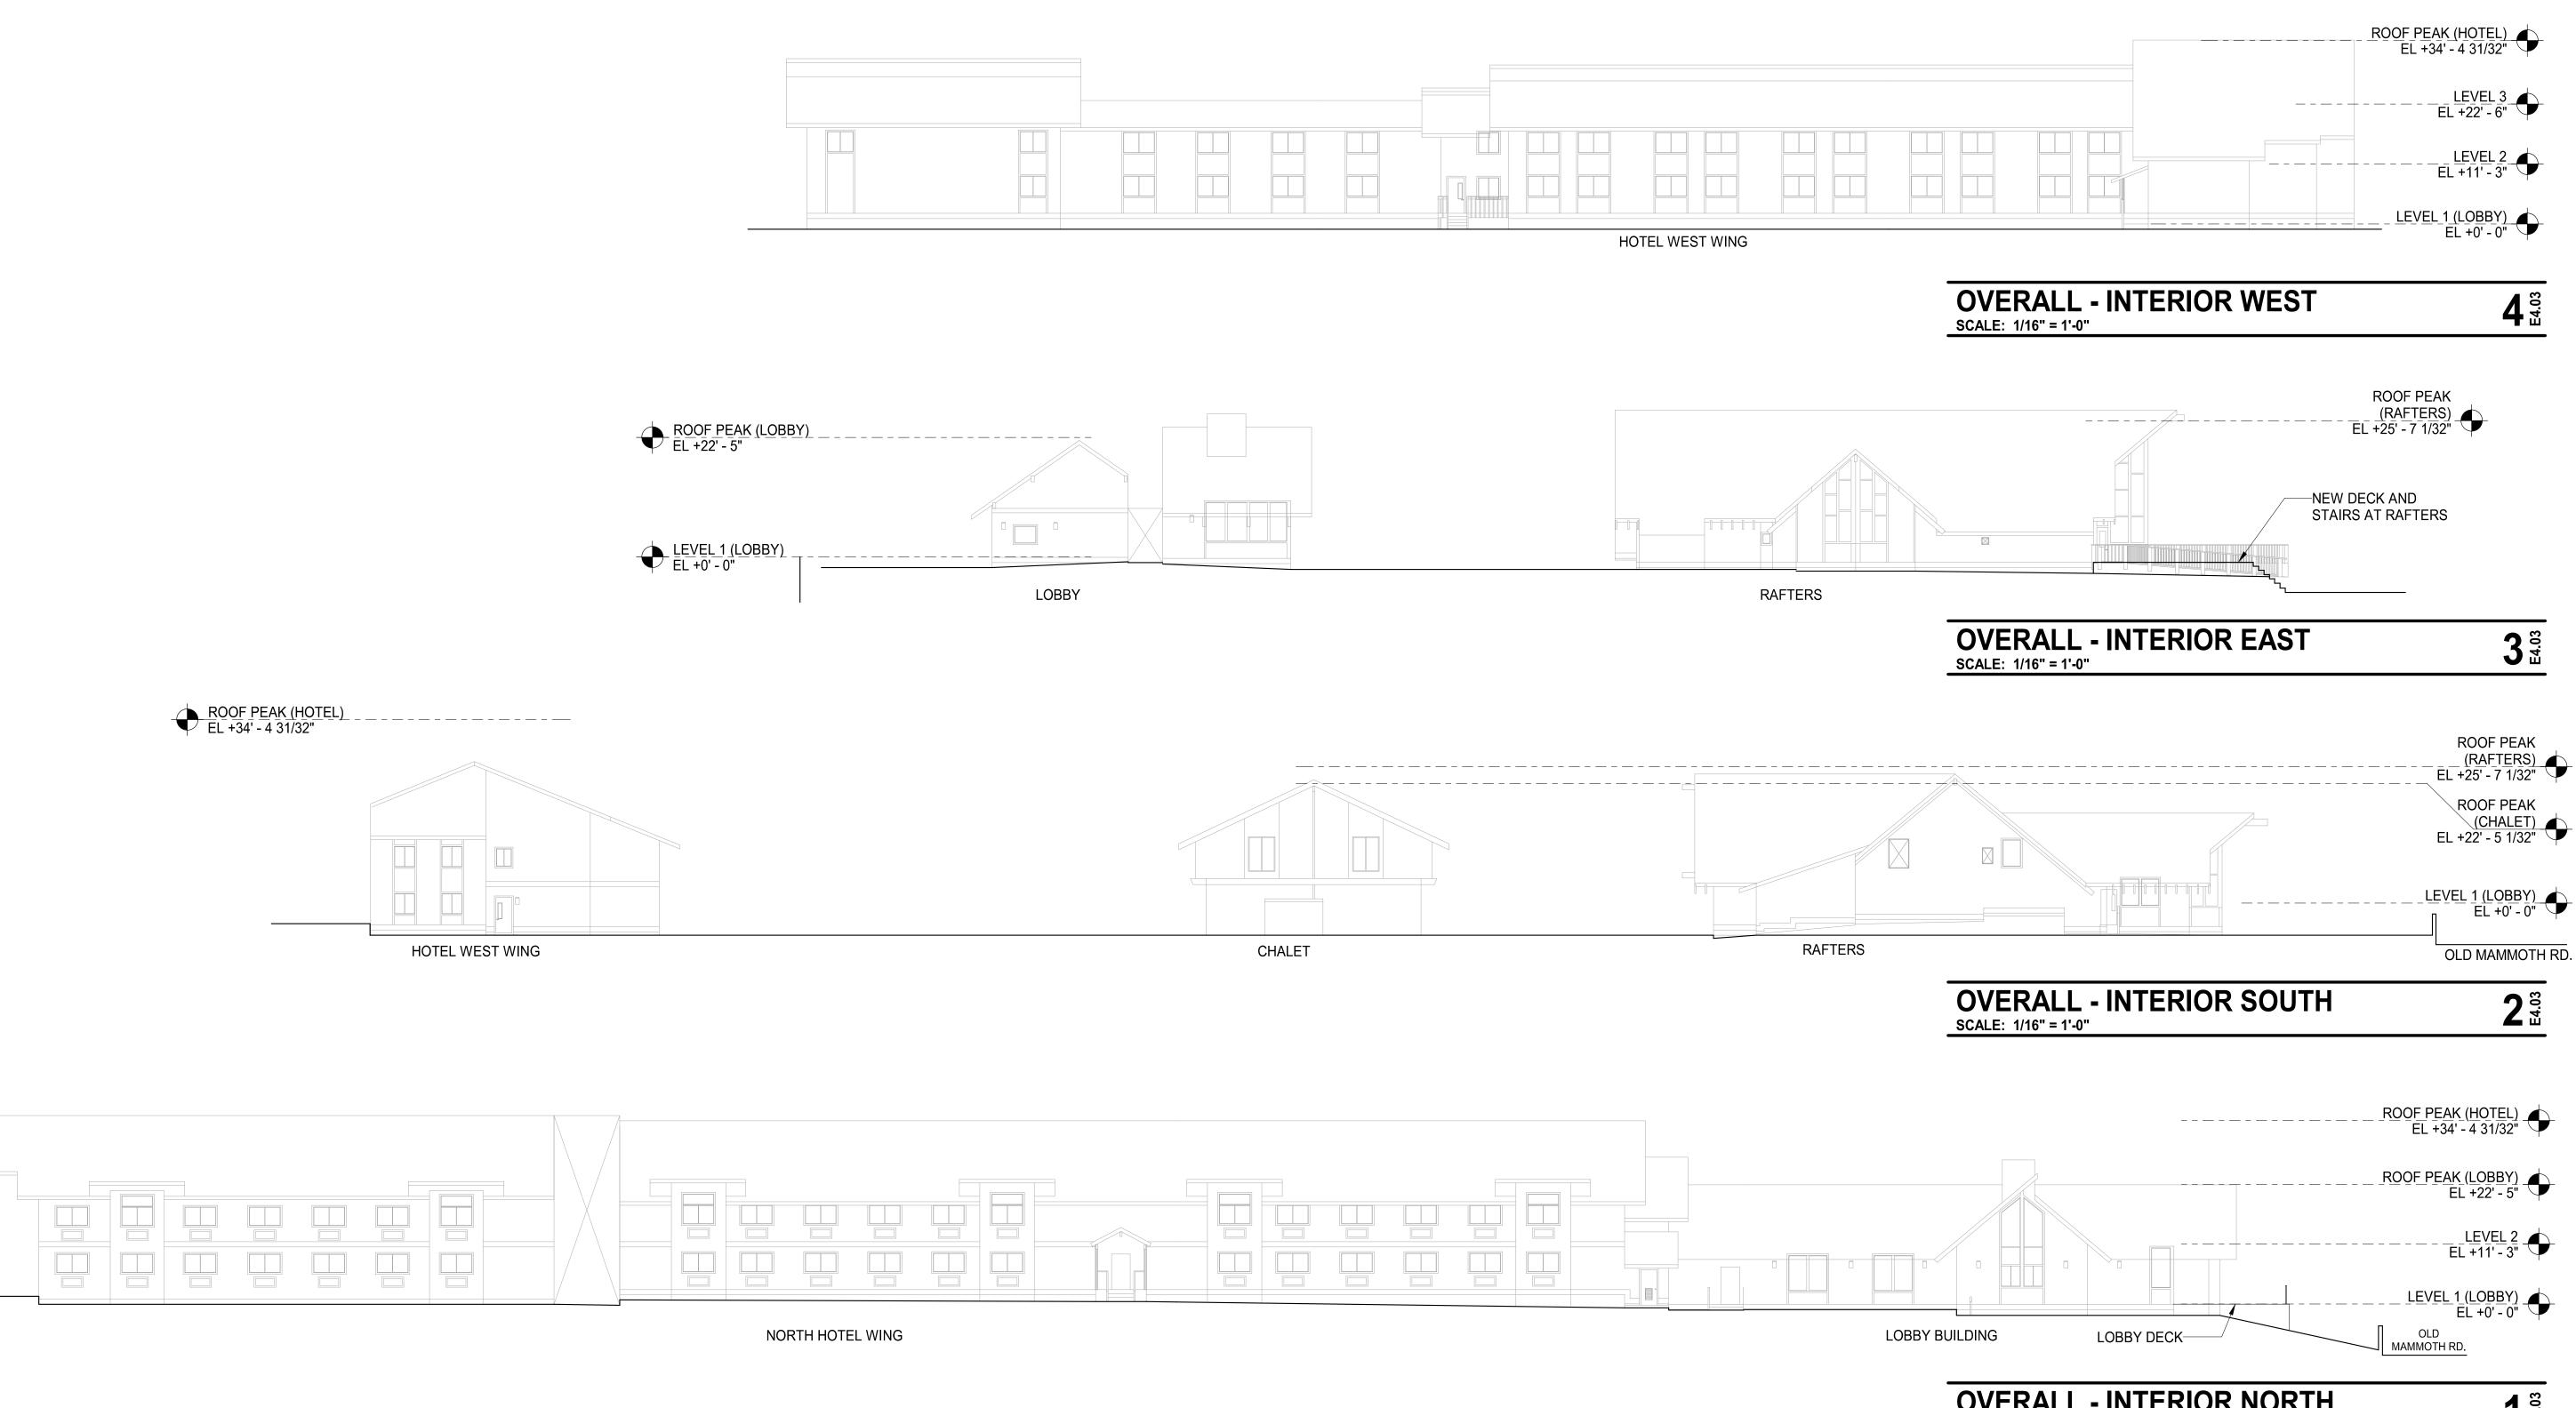

OVERALL - INTERIOR NORTH SCALE: 1/16" = 1'-0"

BUILDING HEIGHTS

SEE BELOW FOR MAXIMUM HEIGHTS AT EACH BUILDING PER MUNICIPAL CODE 17.36.060.

REFER TO C-SERIES SHEETS FOR SITE GRADING.

ALL BUILDINGS BELOW ARE EXISTING TO REMAIN, NO HEIGHTS ARE PROPOSED TO BE ALTERED.

LOBBY BUILDING: 25'-3 1/2"

HOTEL NORTH WING: 34'-0"

HOTEL WEST WING: 35'-10"

CHALETS: 29'-3"

RAFTERS RESTAURANT: 31'-10"

SHEET NOTES

- 1. ALL EXISTING BUILDINGS TO REMAIN, SHOWN GREY. ALL PROPOSED ADDITIONS NOTED.
- 2. NO NEW ROOF TOP STRUCTURES PROPOSED.
- 3. NO ALTERATIONS TO EXISTING BUILDING HEIGHTS PROPOSED.
- 4. SEE E4.11 FOR PROPOSED EXTERIOR PAINT COLORS ON EXISTING BUILDINGS.
- 5. REFER TO CIVIL C-SERIES SHEETS AND LANDSCAPE D-SERIES SHEETS FOR PROPOSED SITE WORK.
- 6. REFER TO F-SERIES SHEETS FOR PROPOSED CABINS AND POOL SCOPE.
- 7. BUILDING HEIGHTS ARE MEASURED PER MUNICIPAL CODE SECTION 17.36.060. REFER TO C-SERIES SHEETS FOR SITE GRADING.



164 OLD MAMMOTH RD, MAMMOTH LAKES, CA 93546

DESIGN REVIEW SUBMITTAL November 1, 2021



SHEET DATE: REVISIONS

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CHECKED: PROJECT No.

SHEET TITLE:

ISSUE:

EXTERIOR ELEVATIONS

E4.03

10/20/21

XX.XX

ORIGINAL SHEET SIZE IS 24"x36" | PLOT DATE: 11/13/2021 10:14:47 PM



EXISTING RAILINGS TO REMAIN.
REPAIR AS REQUIRED. SAND AND
CLEAR COAT AT EXISTING WOOD.

PROPOSED PAINT AT LOBBY

(VIEW OF LOBBY FROM OLD MAMMOTH ROAD)

EXISTING MASONRY TO REMAIN, TYP. CLEAN AS REQUIRED.

EXISTING DOORS TO REMAIN

PROPOSED PAINT @ RAFTERS

(VIEW OF RAFTERS FROM OLD MAMMOTH ROAD)

EXISTING MASONRY TO REMAIN, TYP. CLEAN AS REQUIRED

REFER TO REVISED COLORS ON SHEET B.08 & B.09

2-Woven Wicker SW 9104

or similar

EXISTING ROOF TO REMAIN, UNDERSIDE TO BE REPAINTED, TYP.-


1-Black Fox SW 7020

or similar

EXISTING WINDOWS TO REMAIN-

EXISTING WINDOW TRIM TO BE REPAINTED, TYP.-

EXISTING SIDING TO REMAIN AND BE REPAINTED—

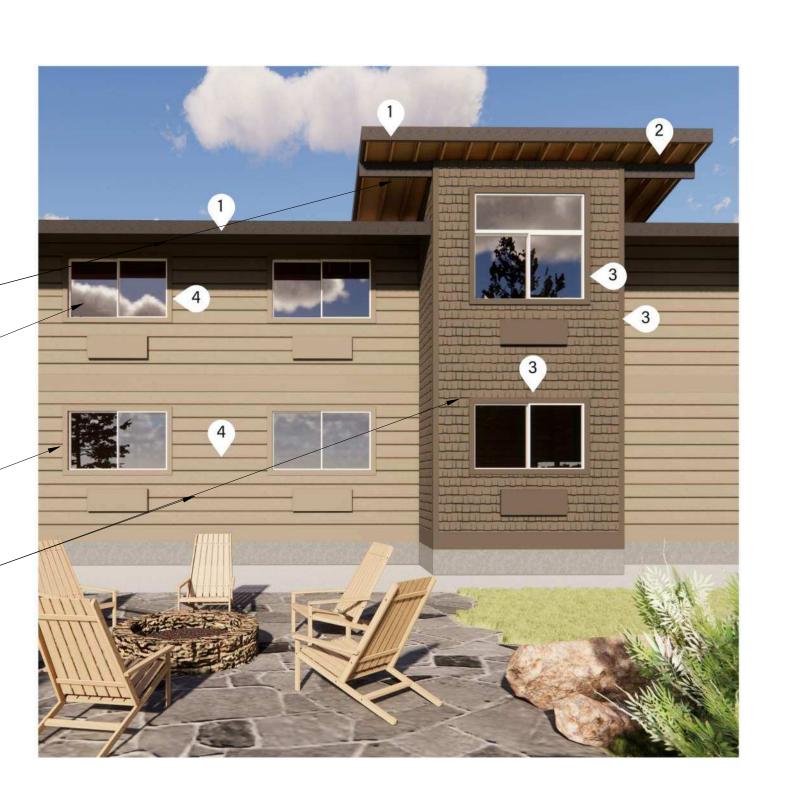

1-Black Fox SW 7020 or similar 2-Woven Wicker SW 9104 or similar

3-Statue Bronze SW 7034 or similar 4-Artisan Tan SW 7540 or similar

PROPOSED PAINT @ (E) HOTEL WINGS, TYP.



EXISTING SIDING TO REMAIN AND BE REPAINTED

164 OLD MAMMOTH RD, MAMMOTH LAKES, CA 93546

DESIGN REVIEW SUBMITTAL November 1, 2021



PROJECT ISSUES: DESIGN REVIEW SUBMITTAL

SHEET DATE: REVISIONS

DRAWN: CHECKED:

PROJECT No. 21.029 SHEET TITLE:

EXTERIOR COLOR PALETTE


E4.11

1-Black Fox SW 7020

or similar



TYPICAL CABINS AT ENTRY DECK

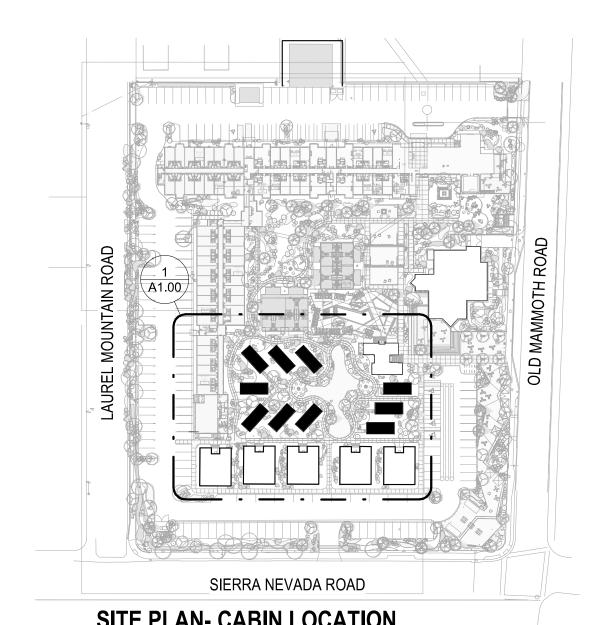



WALL MOUNT
HEAT PUMP


14' - 0" FRAMING

BEDROOM


FLOOR AREA (GSF) - CABIN


392.00 SF


LEVEL 1

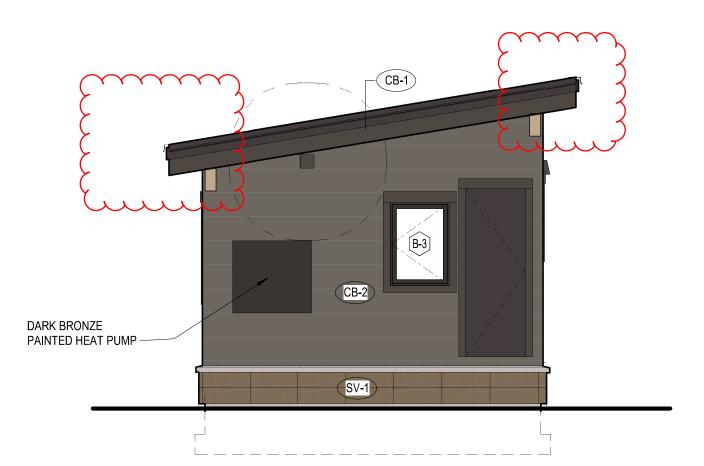

FRONT ELEVATION
SCALE: 1/4" = 1'-0"

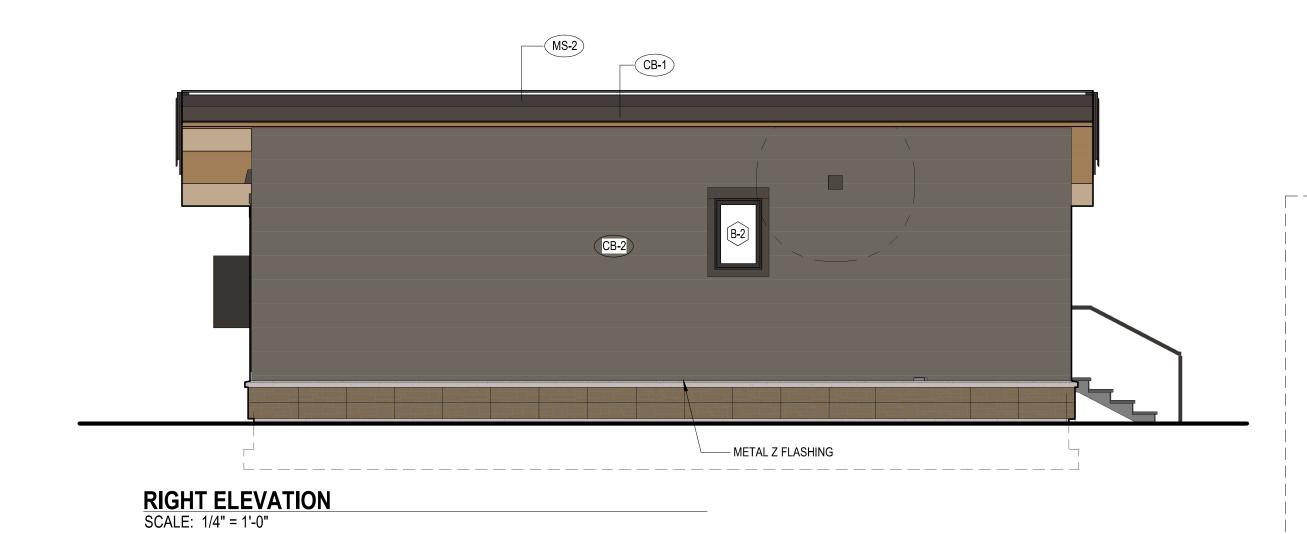

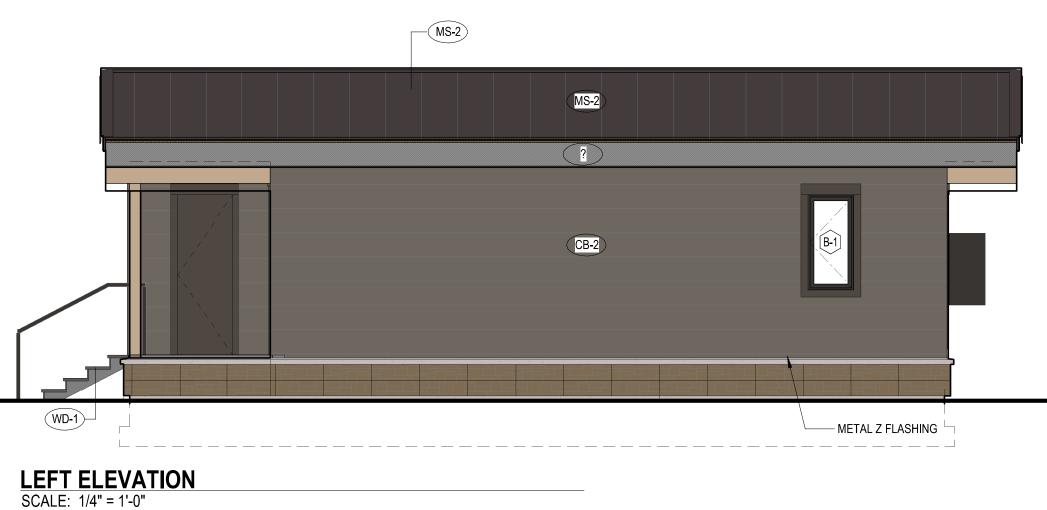

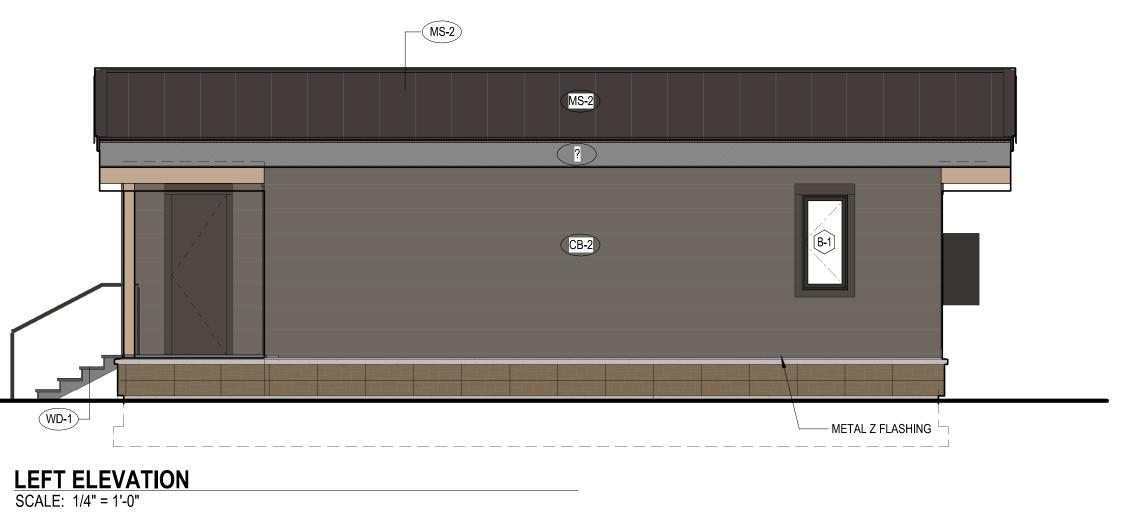

REAR ELEVATION
SCALE: 1/4" = 1'-0"



CB-1 CEMENT BOARD PANEL SHERWIN WILLIAMS SW 7020 BLACK FOX

OR SIM



CB-2



SUNSET"



CB-2

WD-1





WN-1 WINDOW MARVIN ESSENTIAL IN "BRONZE"



TREX DECKING IN

"WINCHESTER GREY"







MS-2 METAL ROOFING BOARD & BATTEN KYNAR, DARK BRONZE



F	LOOR AREA (NSF) - CA	ABIN
NAME	LEVEL	AREA
CABIN	LEVEL 1	351.00 SF
CABIN DECK	LEVEL 1	72.31 SF

grouparchitect

EDG FELLOW

WATERTON

SIERRA NEVADA RESORT

164 OLD MAMMOTH RD,

MAMMOTH LAKES, CA

DESIGN REVIEW

November 17, 2021

SUBMITTAL

93546

SPRINGBOARD PROJECT ISSUES: DESIGN REVIEW SUBMITTAL DESIGN REVIEW RESUBMITTAL 01/28/2022

SHEET DATE: 01/06/22 REVISIONS

CHECKED: PROJECT No.

SHEET TITLE: CABIN (TYP 10 LOCATIONS)

PERMIT SET ISSUE:


F.01

CONC CONCRETE ARCHITECTURAL
CAST-IN-PLACE

(A-2






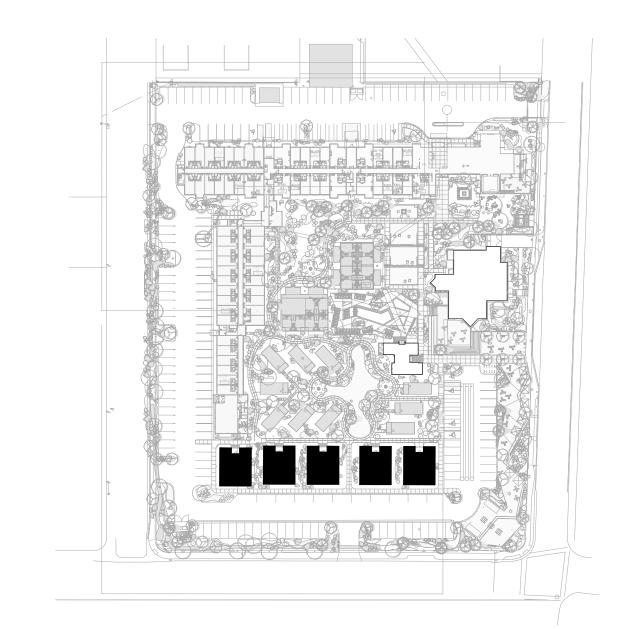


SITE PLAN - VILLA LOCATION.

NORTH PERSPECTIVE - VILLA ENTRY
SOUTH PERSPECTIVE - VILLA FACADE FACING SIERRA NEVADA ROAD

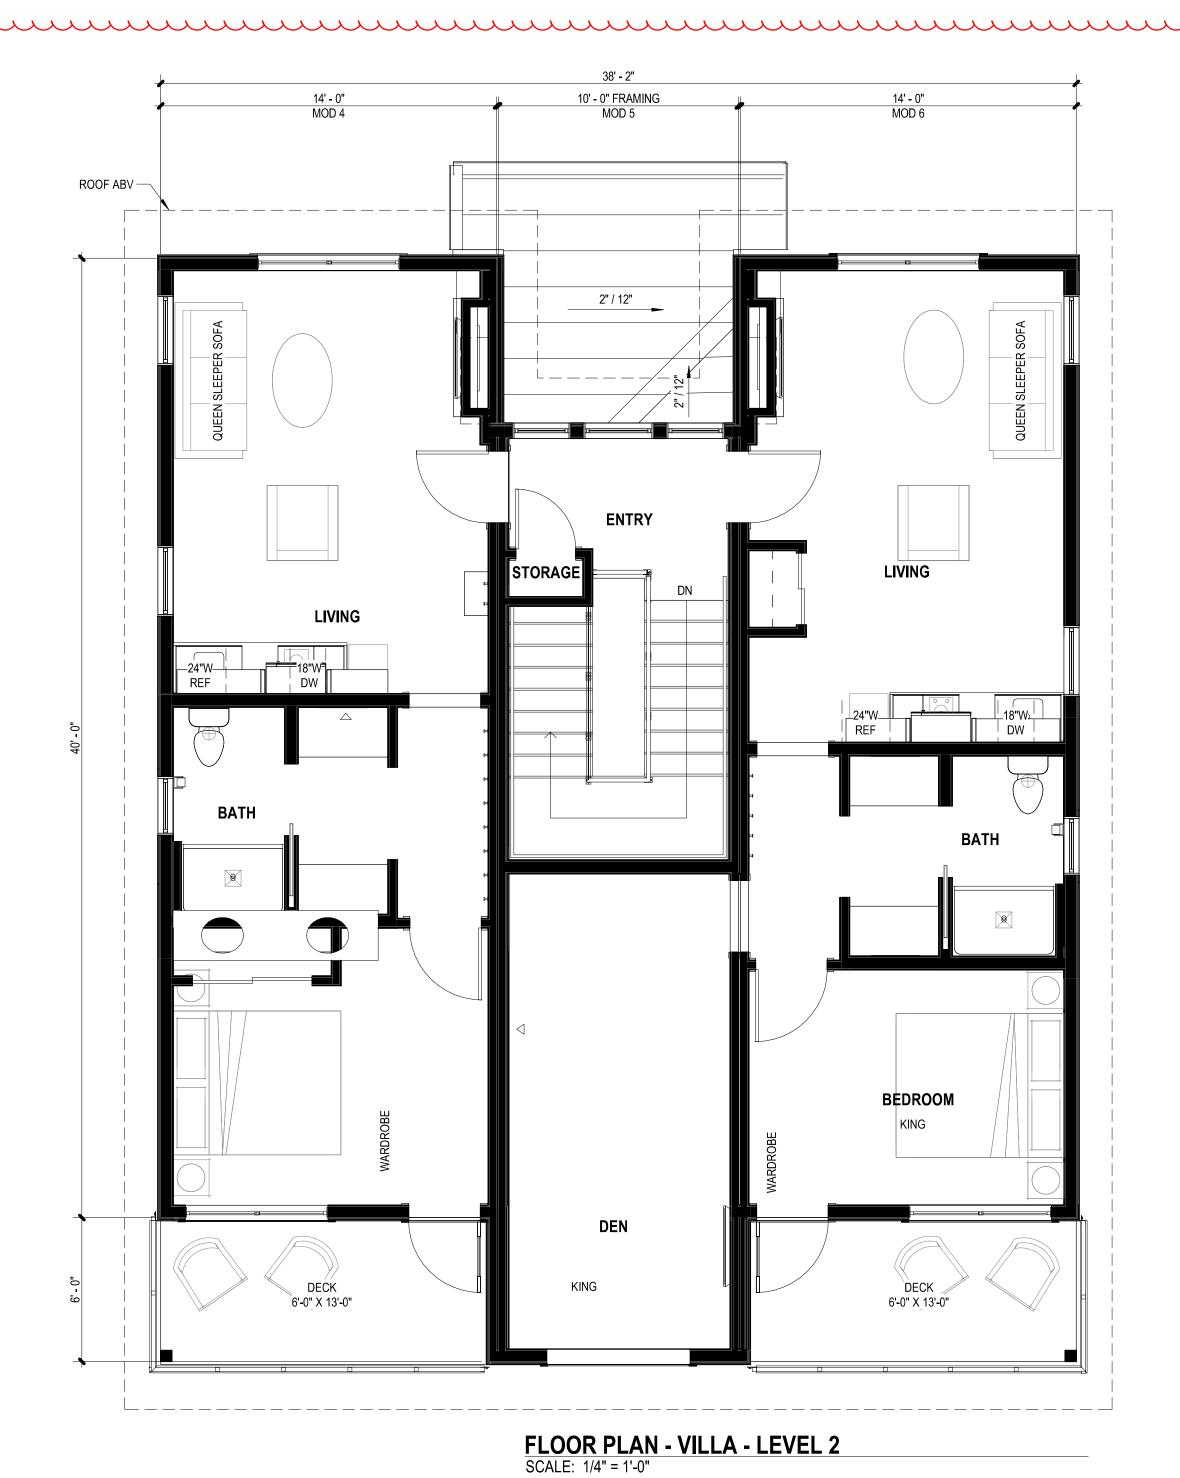

NAME	LEVEL	AREA		
VILLA	LEVEL 1	1423.00 SF		
VILLA	LEVEL 2	1427.62 SF		
		2850.62 SF		
VILLA DECK	LEVEL 2	82.28 S		
VILLA DECK	LEVEL 2	82.25 S		
VILLA DECK	LEVEL 1	74.50 SF		
VILLA DECK	LEVEL 1	74.50 SF		
		313.53 SF		
, A	Area Schedule (GSF) - VI	ILLA AREA		
VILLA	LEVEL 1	1543.08 SF		
VILLA	LEVEL 2	1519.78 SF		

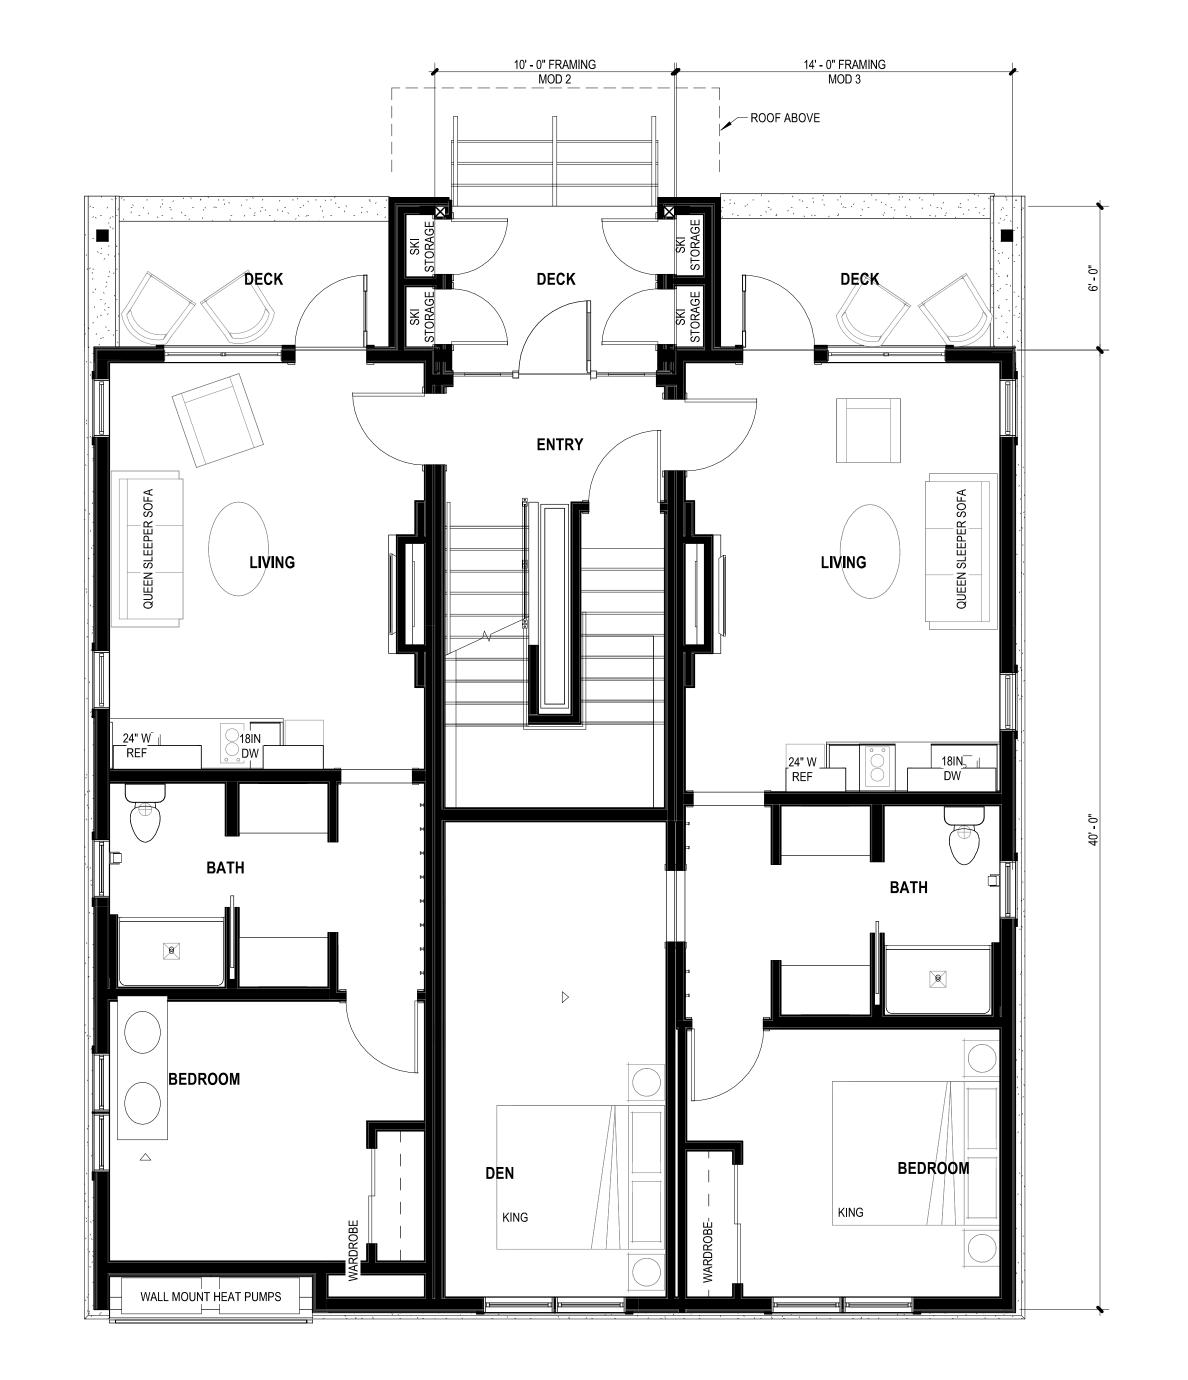

FLOOR PLAN - VILLA - LEVEL 1



164 OLD MAMMOTH RD, MAMMOTH LAKES, CA 93546

DESIGN REVIEW SUBMITTAL November 17, 2021



REVISIONS

CHECKED: PROJECT No.

F.02

SHEET TITLE:
VILLA (TYP 5

LOCATIONS)



164 OLD MAMMOTH RD, MAMMOTH LAKES, CA 93546

DESIGN REVIEW SUBMITTAL November 17, 2021

WATERTON grouparchitect EDG FELLOW method homes (S) SPRINGBOARD PROJECT ISSUES: DESIGN REVIEW SUBMITTAL DESIGN REVIEW RESUBMITTAL 01/28/2022

01/06/22


PERMIT SET

F.03



PERSPECTIVE 1 (POOL BUILDING)-DR

ORIGINAL SHEET SIZE IS 24"x36" | PLOT DATE: 1/28/2022 5:17:43 PM

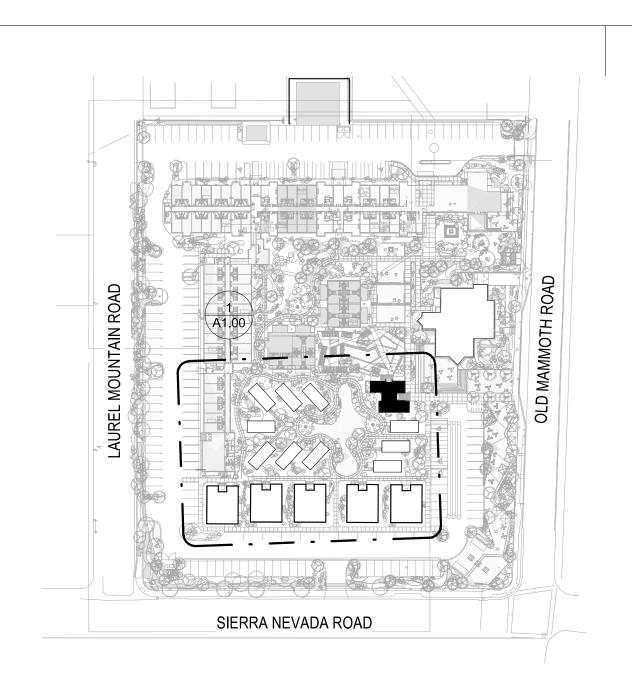

SITE PLAN- CABANA LOCATION



SIERRA NEVADA RESORT

SIERRA NEVADA RESORT

164 OLD MAMMOTH RD,
MAMMOTH LAKES, CA
93546

DESIGN REVIEW SUBMITTAL November 17, 2021



SHEET DATE: REVISIONS

CHECKED: PROJECT No.

SHEET TITLE:

CABANA



164 OLD MAMMOTH RD, MAMMOTH LAKES, CA 93546

DESIGN REVIEW SUBMITTAL November 17, 2021

WATERTON

grouparchitect

EDG FELLOW

method homes

SPRINGBOARD

DESIGN REVIEW RESUBMITTAL 01/28/2022

01/06/22

PROJECT ISSUES:

SHEET DATE: REVISIONS

CHECKED: PROJECT No.

SHEET TITLE:

ISSUE:

CABANA

ELEVATIONS

DESIGN REVIEW SUBMITTAL



4

LEVEL 1 T.O.P. OF OF OTHER PROPERTY OF THE PRO

 SOUTH ELEVATION
 2

 SCALE: 1/4" = 1'-0"
 F.05



CONC CONCRETE ARCHITECTURAL
CAST-IN-PLACE



CEMENT BOARD
PANEL
WOODTONE COLORSELECT PANEL
IN "ESPRESSO"



CB-2 CEMENT BOARD LAP SIDING WOODTONE - RUSTIC LAP IN "RIVER ROCK"



NORTH ELEVATION

SCALE: 1/4" = 1'-0"

CB-4 CEMENT BOARD
LAP SIDING

WOODTONE - RUSTIC
LAP IN "SUMMER
WHEAT"



CEDAR NICKEL GAP T&G, STAIN TBD



STONE VENEER

CERTAINTEED
STONEFACADE "HARBOR
SUNSET"



WN-1 WINDOW

MARVIN ESSENTIAL
IN "BRONZE"



WD-1 COMPOSITE DECKING

TREX DECKING IN
"WINCHESTER
GREY"



WEST ELEVATION
SCALE: 1/4" = 1'-0"

MS-1 METAL - CAP / FLASHING

KYNAR, DARK BRONZE



WINDOW TRIM

SHERWIN WILLIAMS
SW 7020 BLACK FOX
OR SIM


F.05


3 F.05

F.05

PERMIT SET

ORIGINAL SHEET SIZE IS 24"x36" | PLOT DATE: 1/28/2022 5:17:49 PM

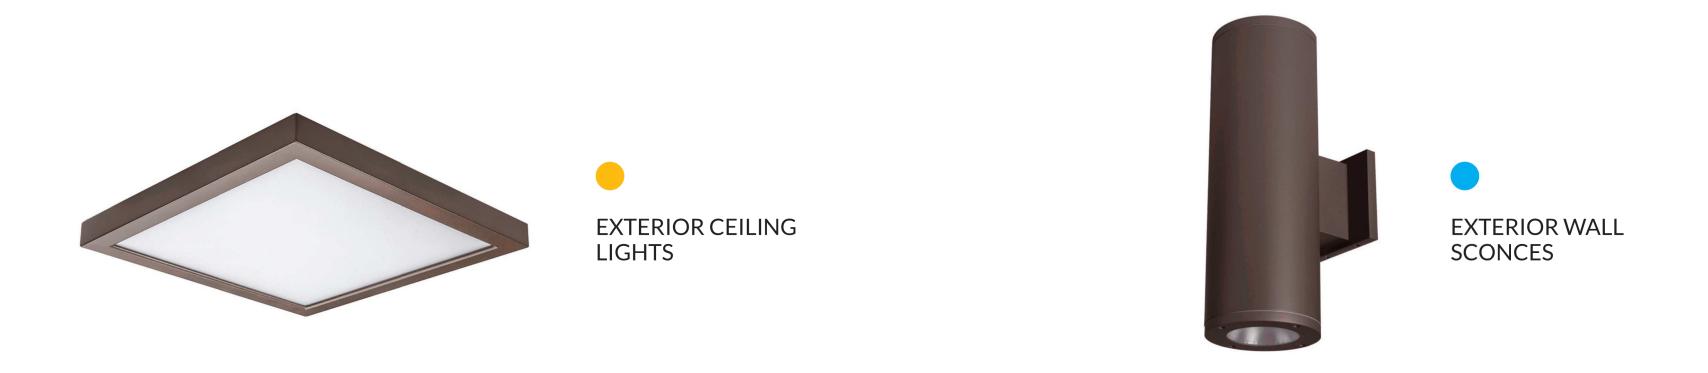

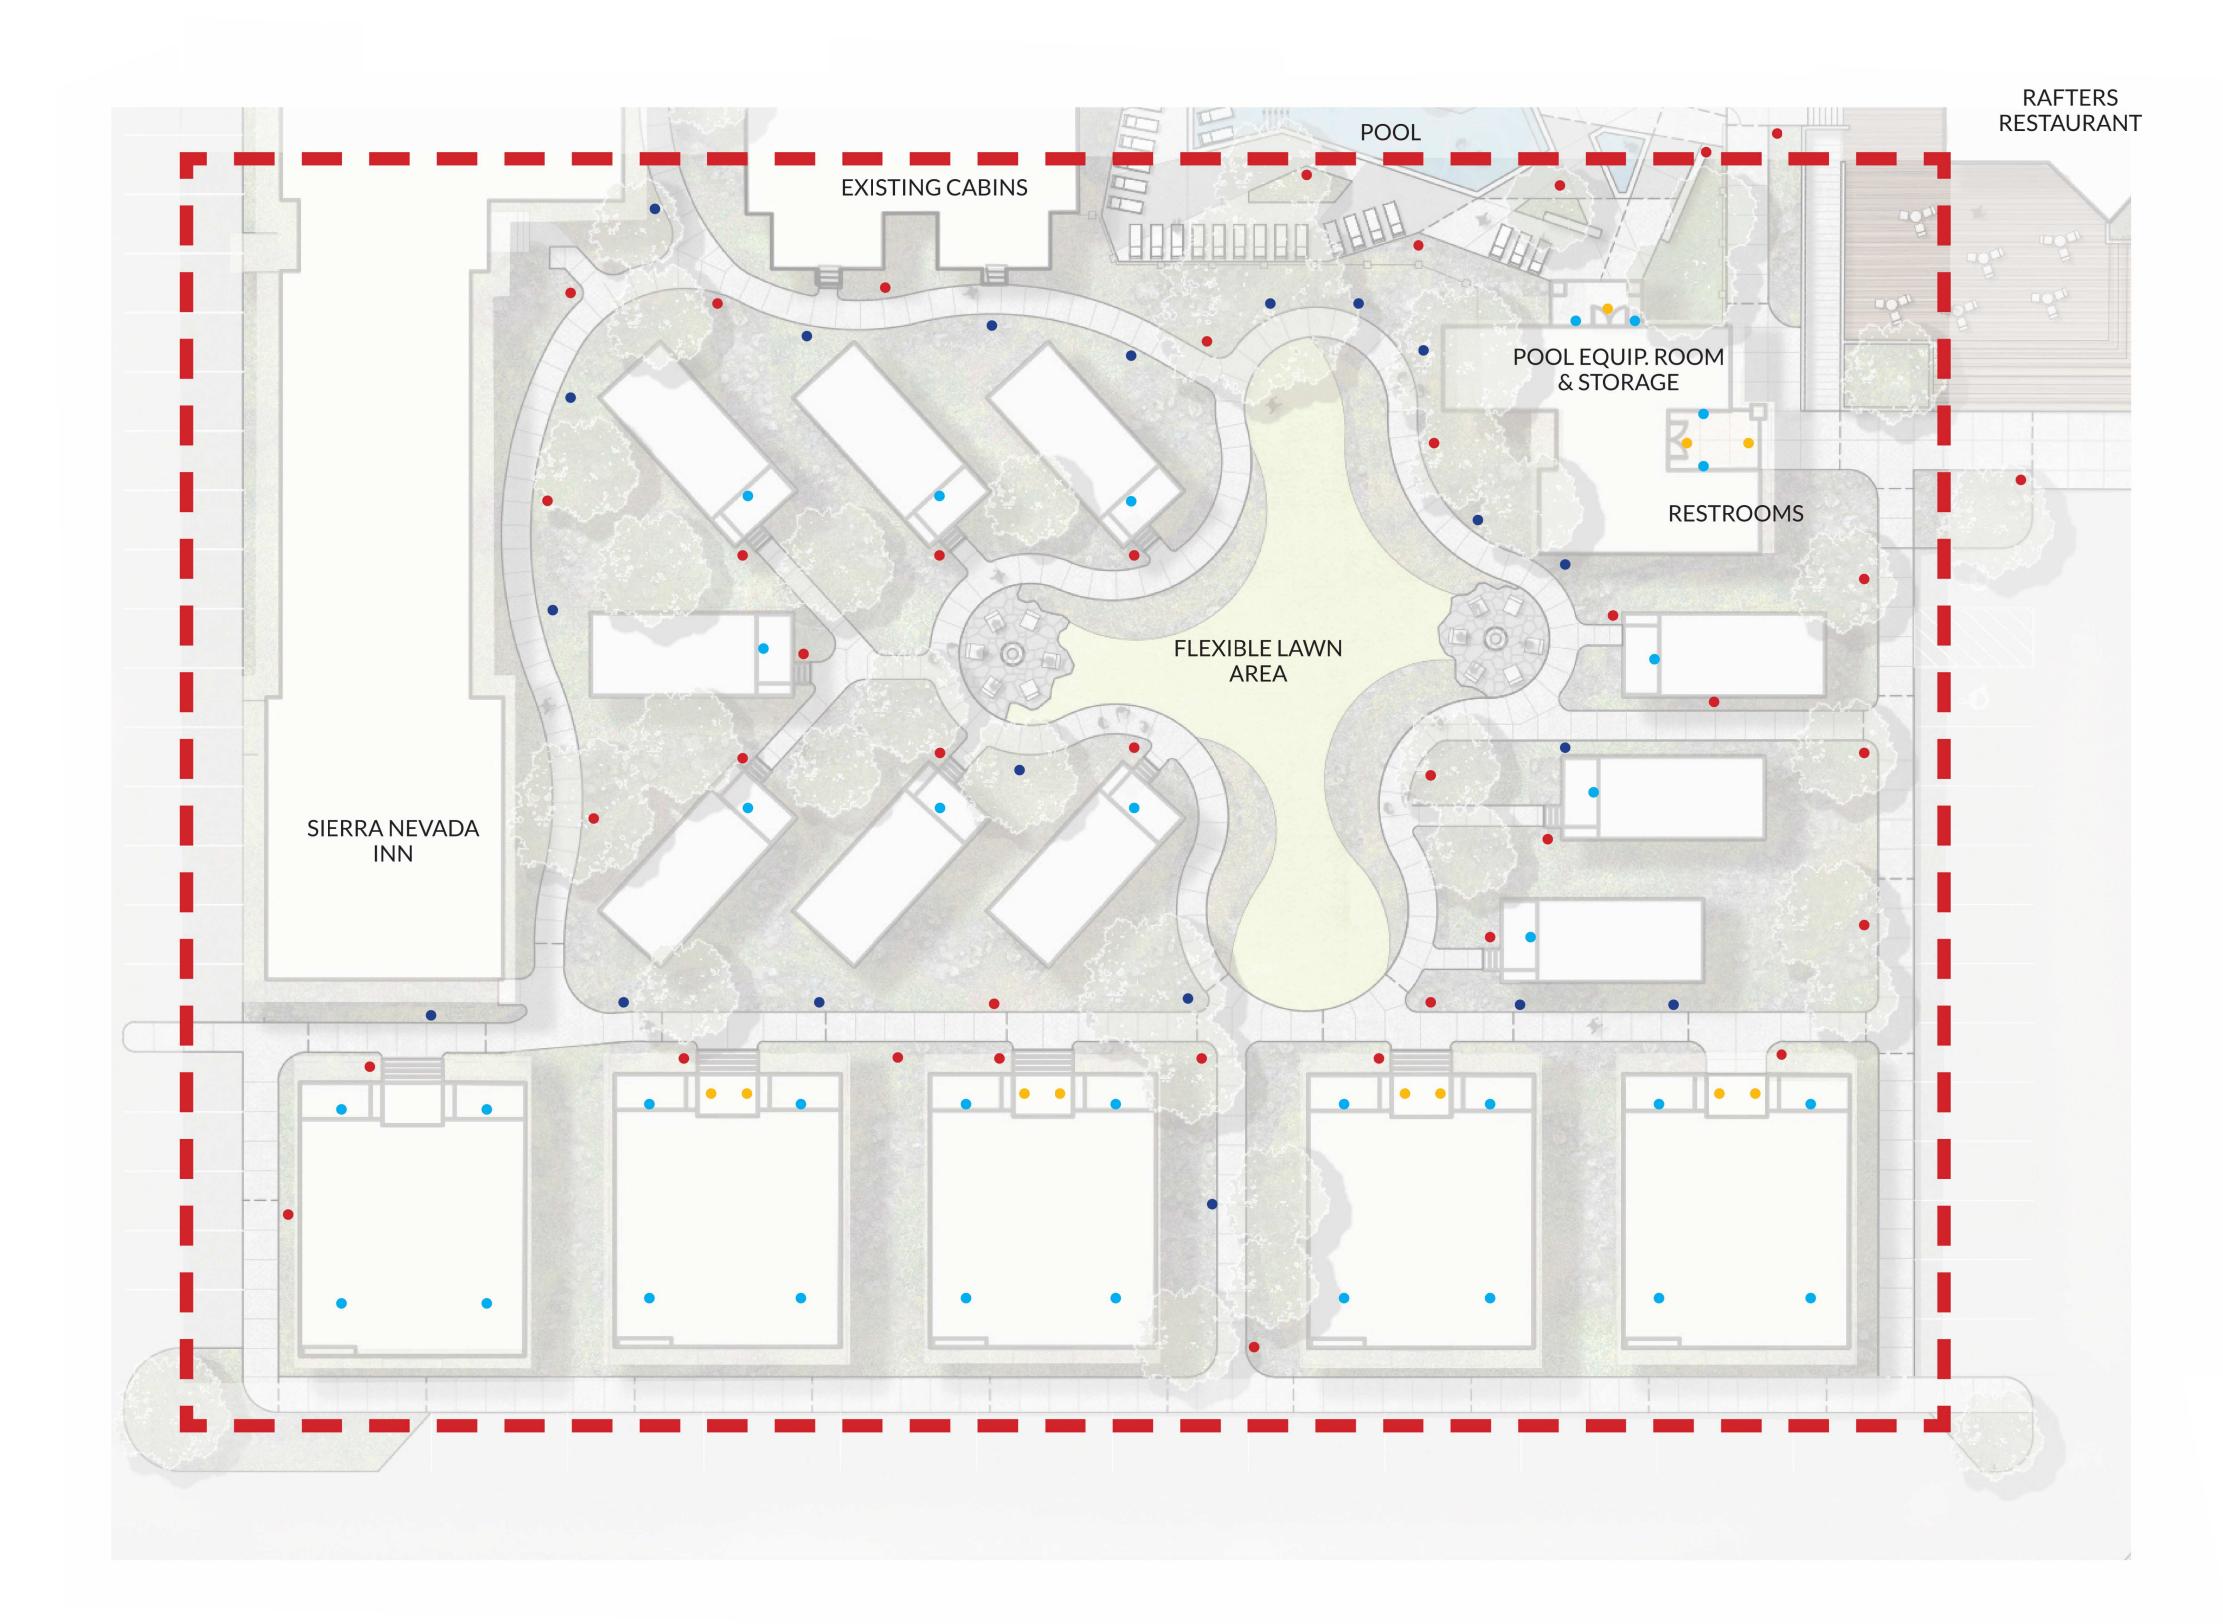


LIGHITNG CONCEPT

The intention is to provide "cozy" lighting, that will guide guest through the amenity spaces during the evening while not detracting from the firepits and cabins. The vision is to keep the open spaces low lit to help further establish a more seculded intament space that guest feel safe. These are dark sky friendly and can work well with the wall mounted lights chosen for the adjacent buildings.







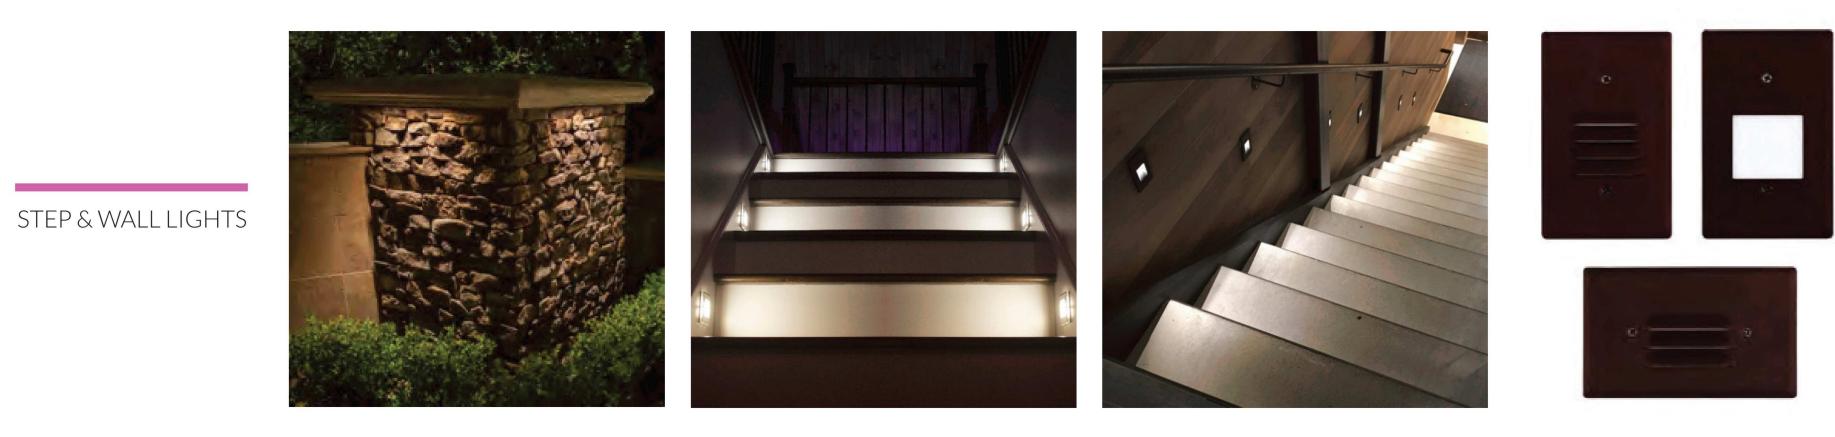


SIERRA NEVADA INN FIRE PIT LAWN AREA TERRACED LAWN AREA **EXISTING CABINS** RAFTERS RESTAURANT SPA POOLS POOL POOL EQUIP. ROOM & STORAGE


LIGHITNG CONCEPT


The intention is to provide "cozy" lighting, that will guide guest through the amenity spaces during the evening while not detracting from the firepits and cabins. The vision is to keep the open spaces low lit to help further establish a more seculded intament space that guest feel safe. These are dark sky friendly and can work well with the wall mounted lights chosen for the adjacent buildings.


SITE LIGHTING




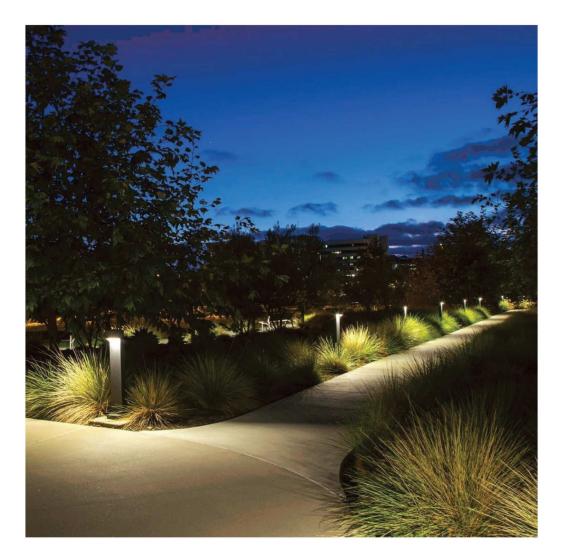

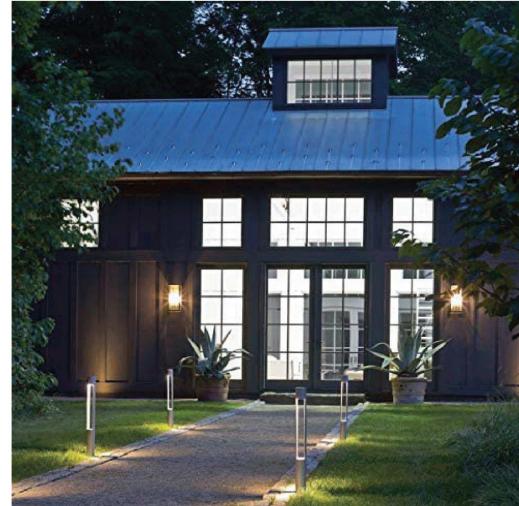

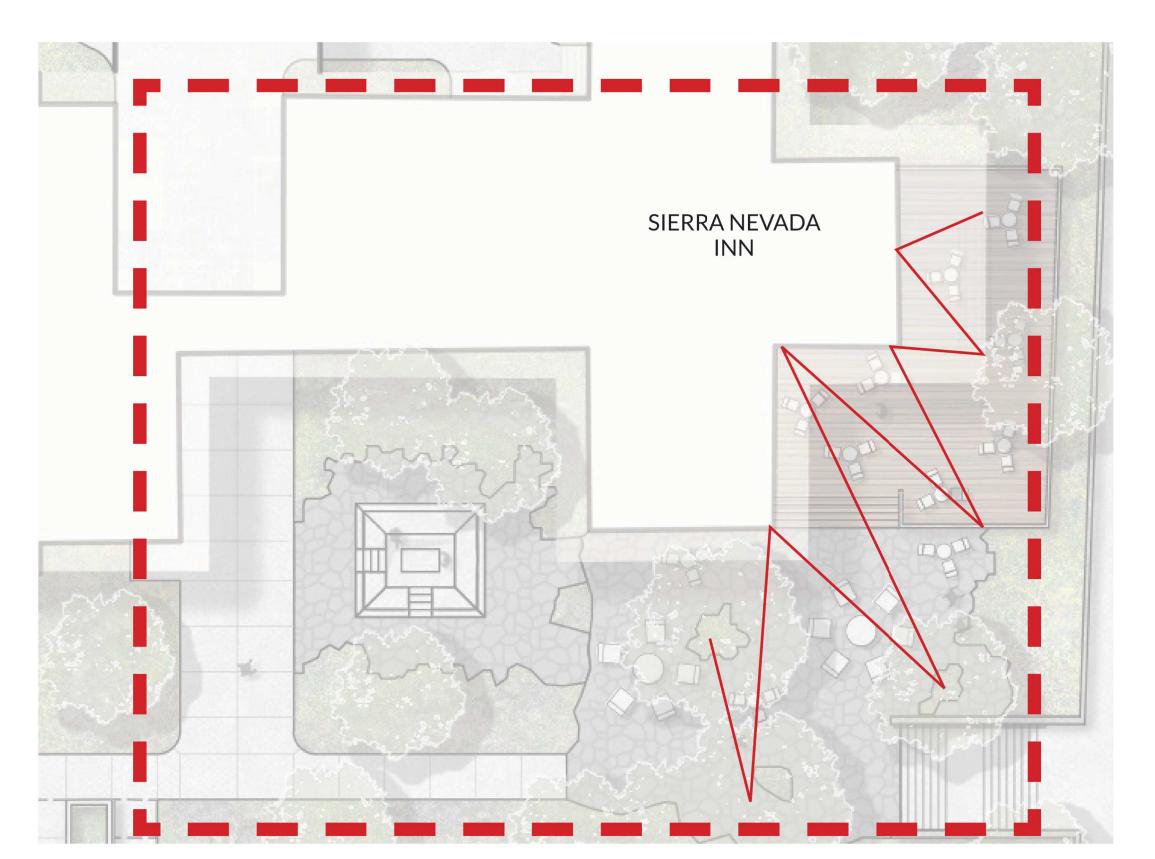

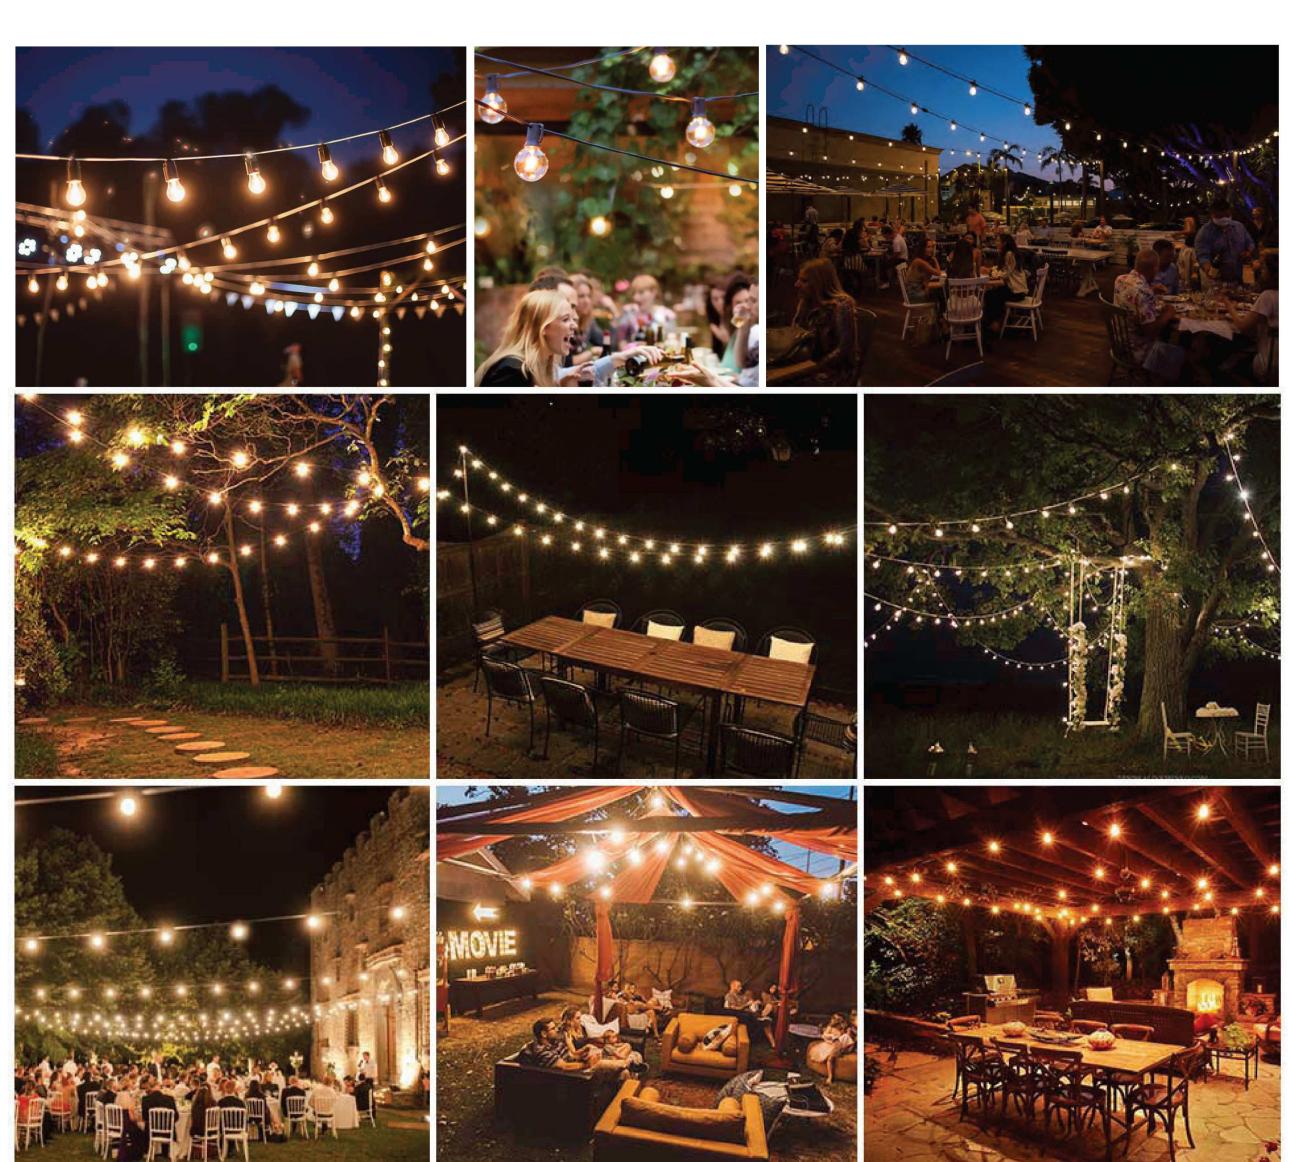

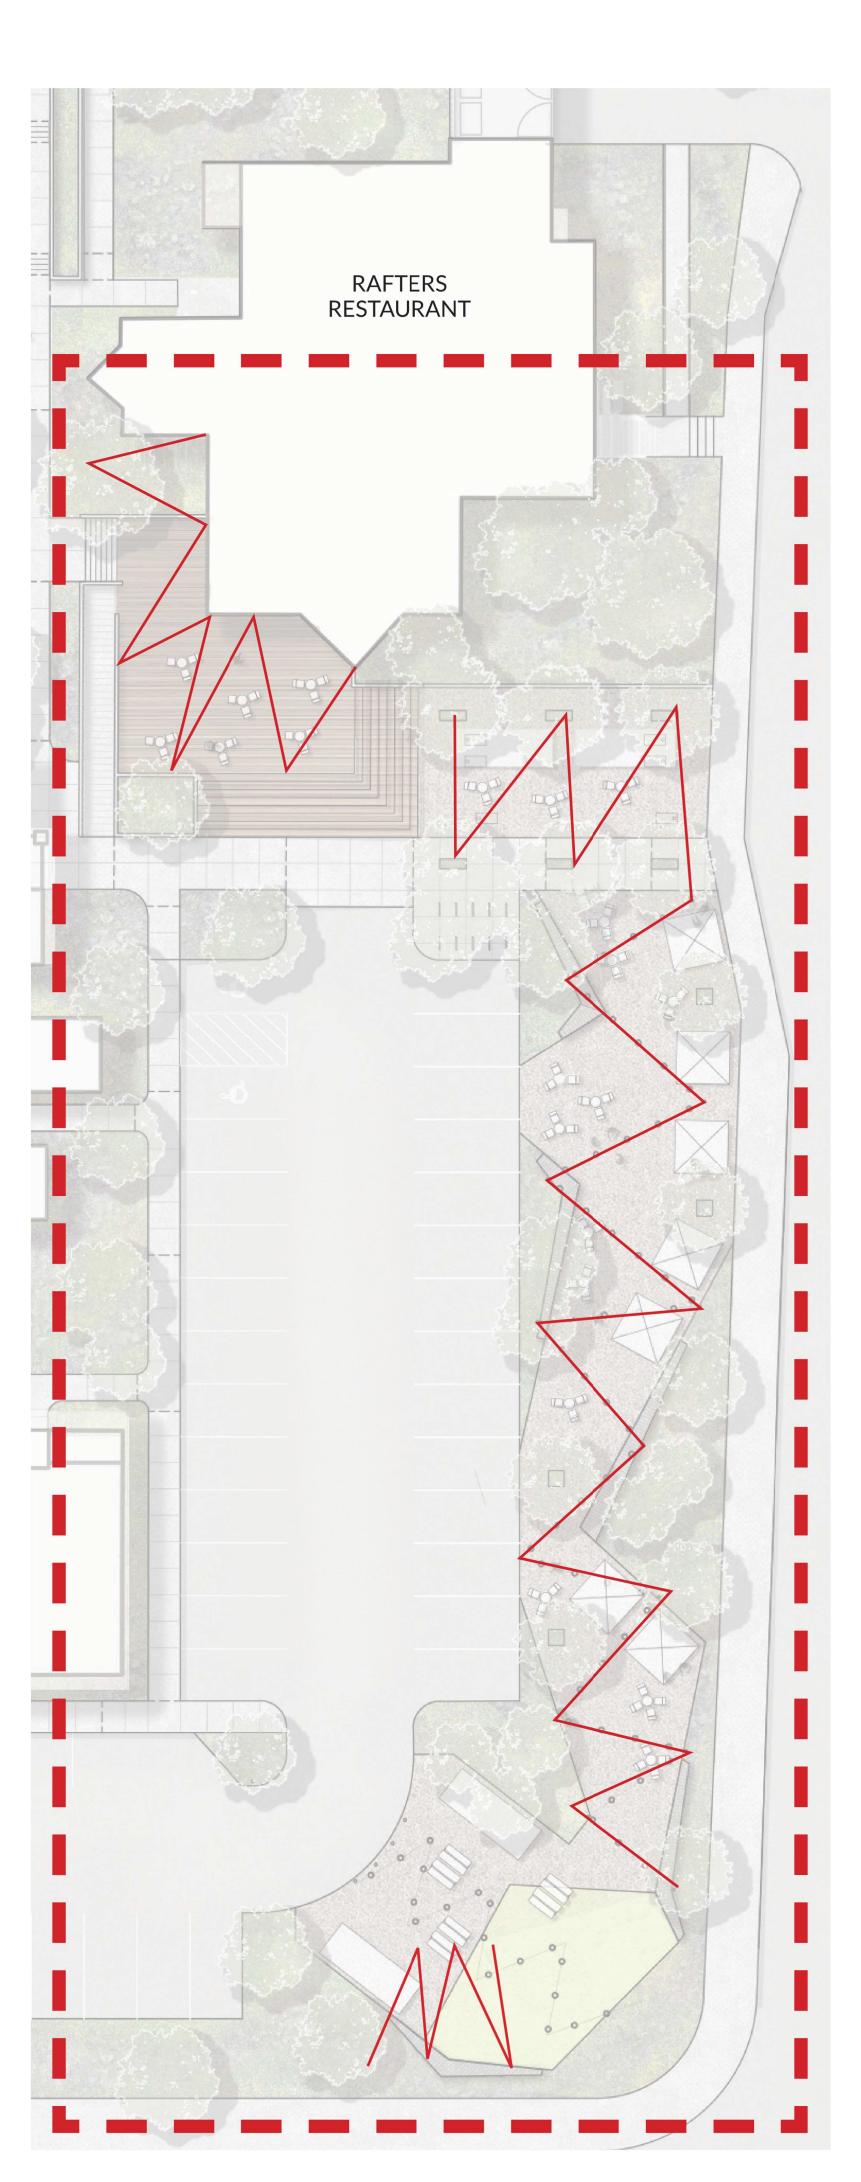

STRING LIGHTS





LIGHITNG CONCEPT

String light style can vary from space to space, but the overall concept is to provide overhead intament lighting that illuminates the space with a warm brodcast of light.



Parking Lot Lights



LIGHTING CONCEPT

The parking lot lights will be all dark sky lights compliant and will provide direct light to the ground, which reduces overall light pollution and glare to adjacent properties. The lighting also improve visibility and will reduce the wattage and the number of light necessary to illuminate the area. This ultimately will save energy and cost to the development.